

West Lake Corridor Final Environmental Impact Statement/ Record of Decision and Section 4(f) Evaluation

Appendix E


Appendix E. Engineering Drawings (Part 4 of 10)




West Lake Corridor Final Environmental Impact Statement/ Record of Decision and Section 4(f) Evaluation

Appendix E


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SOUTH HAMMOND SITE KEYPLAN

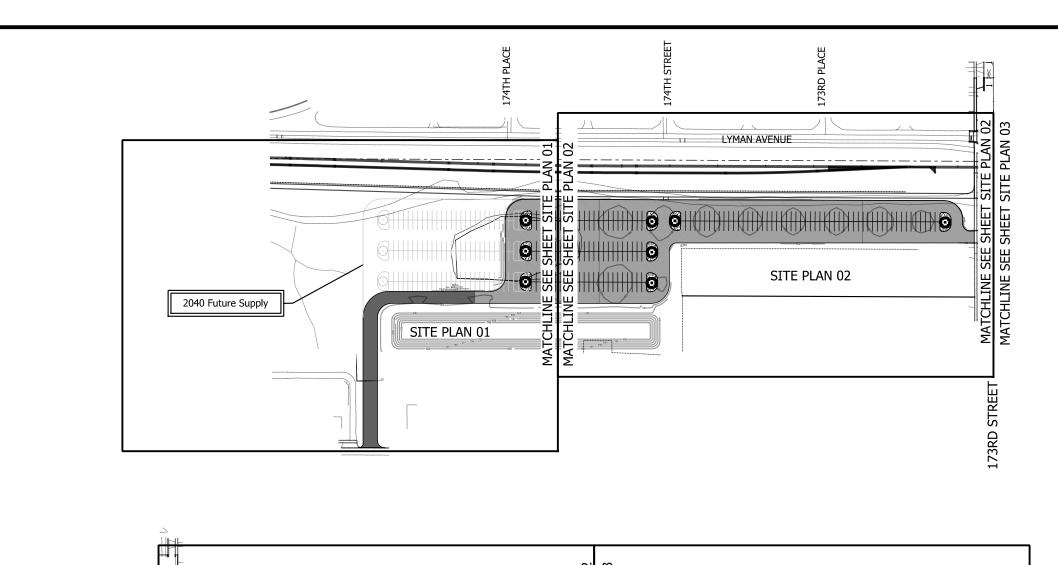


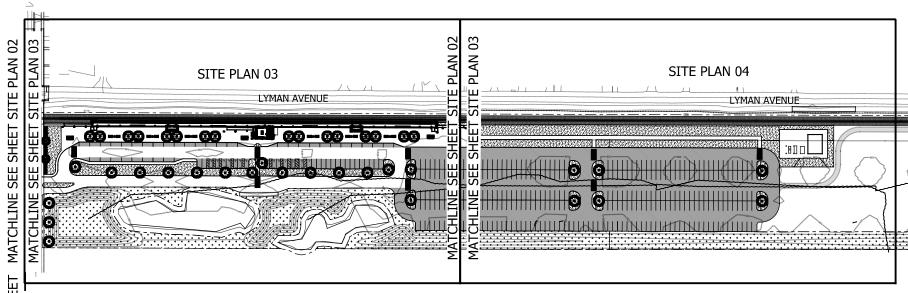



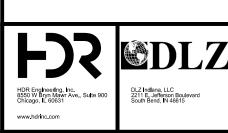

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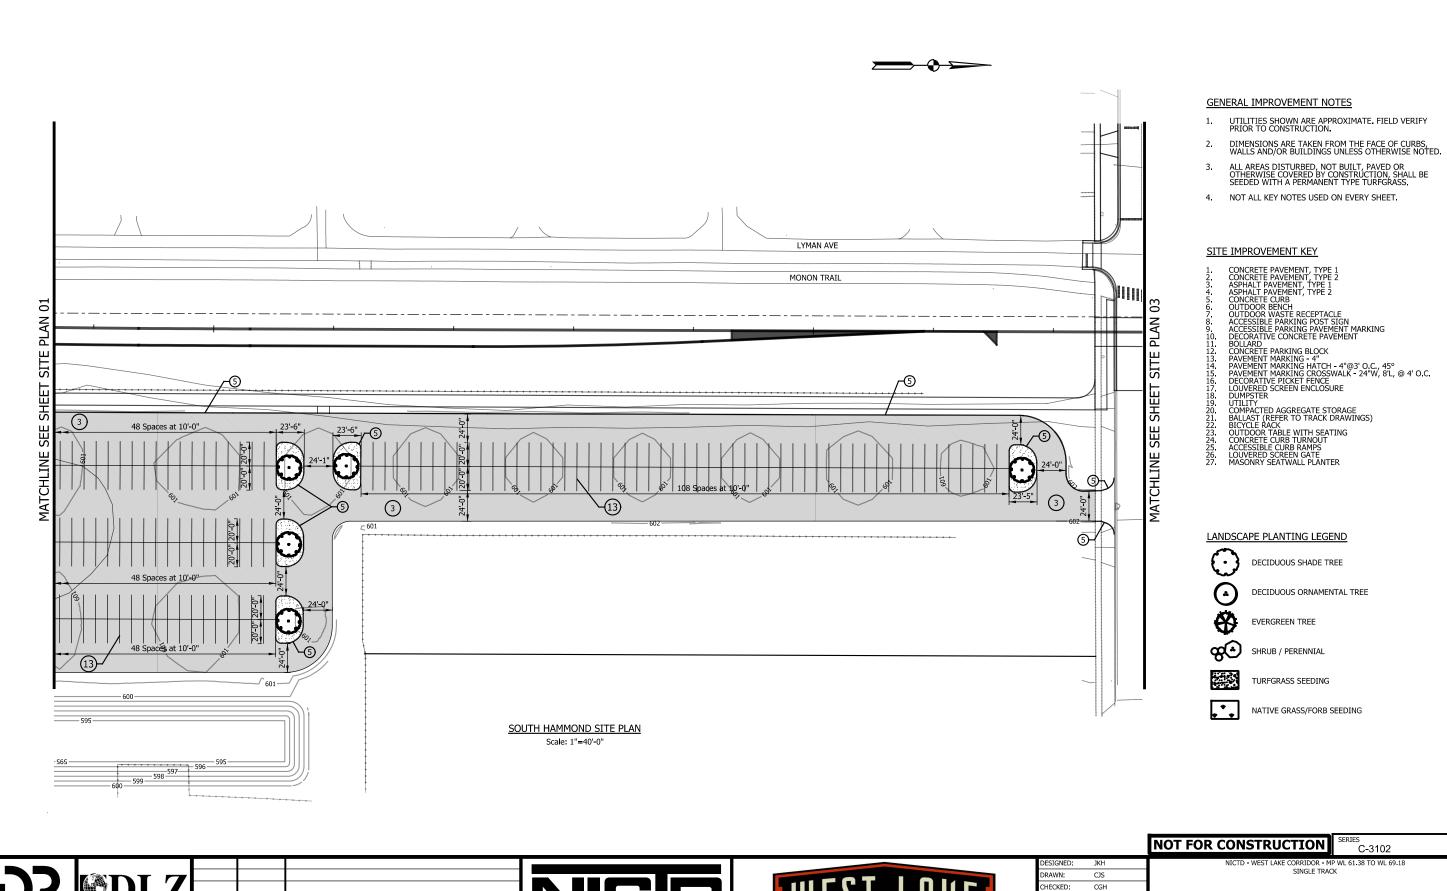
DLZ Indiana, LLC 2211 E. Jefferson Boulevard South Bend, IN 46615 www.hdrinc.com

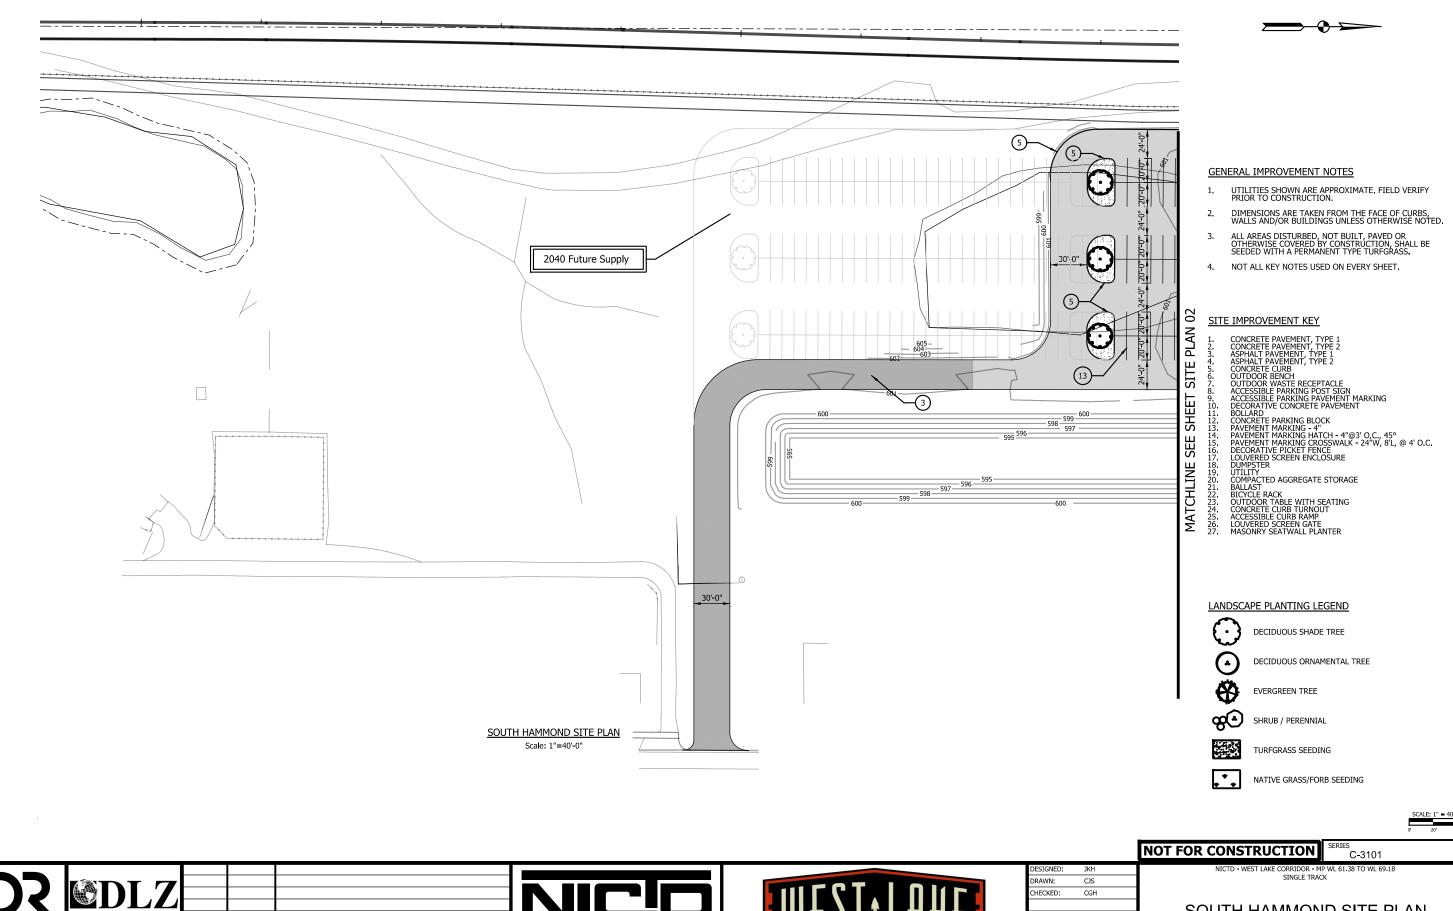NORTHERN INDIANA COMMUTER TRANSPORTATION DISTRICT 33 East Highway 12 Chesterton, Indiana 46304



	JKH	DESIGNED:
	CJS	DRAWN:
	CGH	CHECKED:
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SOUTH HAMMOND SITE PLAN **FACILITY** SHT_WL_FA_SHS_PL_01.dgn



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SOUTH HAMMOND SITE PLAN


FACILITY

SHT_WL_FA_SHS_PL_02.dgn SCALE

116 OF

361



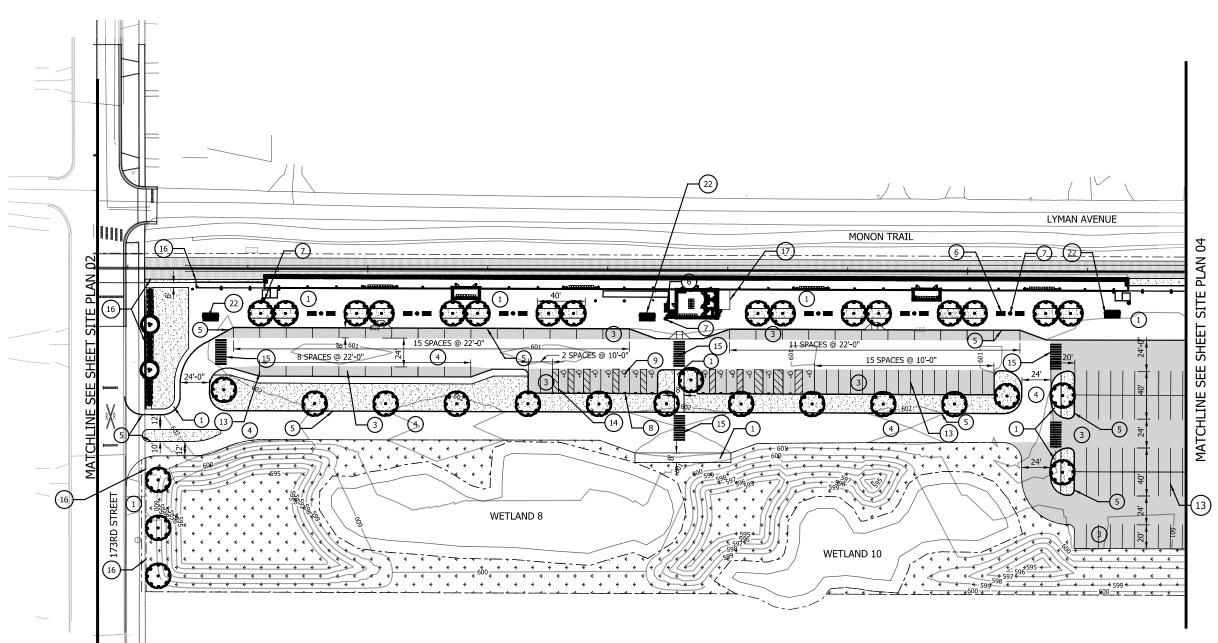

SOUTH HAMMOND SITE PLAN Scale: 1"=40'-0"

GENERAL IMPROVEMENT NOTES

- UTILITIES SHOWN ARE APPROXIMATE. FIELD VERIFY PRIOR TO CONSTRUCTION.
- DIMENSIONS ARE TAKEN FROM THE FACE OF CURBS, WALLS AND/OR BUILDINGS UNLESS OTHERWISE NOTED.
- ALL AREAS DISTURBED, NOT BUILT, PAVED OR OTHERWISE COVERED BY CONSTRUCTION, SHALL BE SEEDED WITH A PERMANENT TYPE TURFGRASS.
- 4. NOT ALL KEY NOTES USED ON EVERY SHEET.

SITE IMPROVEMENT KEY

CONCRETE PAVEMENT, TYPE 1
CONCRETE PAVEMENT, TYPE 1
CONCRETE PAVEMENT, TYPE 2
ASPHALT PAVEMENT, TYPE 1
ASPHALT PAVEMENT, TYPE 2
CONCRETE CURB
OUTDOOR BENCH
OUTDOOR WASTE RECEPTACLE
ACCESSIBLE PARKING POST SIGN
ACCESSIBLE PARKING PAVEMENT MARKING
DECORATIVE CONCRETE PAVEMENT
BOLLARD
DECORATIVE CONCRETE PAVEMENT
BOLLARD
CONCRETE PARKING BLOCK
PAVEMENT MARKING - 4"
PAVEMENT MARKING - 4"
PAVEMENT MARKING CROSSWALK - 24"W, 8"L, @ 4" O.C.
DECORATIVE PICKET FENCE
LOUVERED SCREEN ENCLOSURE
DUMPSTER
UTILITY
COMPACTED AGGREGATE STORAGE DUMPS LEX UTILITY COMPACTED AGGREGATE STORAGE BALLAST (REFER TO TRACK DRAWINGS) BICYCLE RACK OUTDOOR TABLE WITH SEATING CONCRETE CURB TURNOUT ACCESSIBLE CURB RAMPS LOUVERED SCREEN GATE

LANDSCAPE PLANTING LEGEND




DECIDUOUS SHADE TREE



DECIDUOUS ORNAMENTAL TREE



EVERGREEN TREE

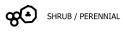



TURFGRASS SEEDING



NATIVE GRASS/FORB SEEDING

NOT FOR CONSTRUCTION

NICTD - WEST LAKE CORRIDOR - MP W SINGLE TRACK

SOUTH HAMMOND SITE PLAN

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RAWN:

DATE:

HECKED:

CJS

CGH

07/21/17



GENERAL IMPROVEMENT NOTES

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ASPHALT PAVEMENT, TYPE 1
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ASPHALT PAVEMENT, TYPE 2
CONCRETE CURB
OUTDOOR WASTE RECEPTACLE
ACCESSIBLE PARKING POST SIGN
ACCESSIBLE PARKING PAVEMENT MARKING
DECORATIVE CONCRETE PAVEMENT
BOLLARD
CONCRETE PARKING BLOCK
PAVEMENT MARKING - 4"
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PAVEMENT MARKING CAOSSWALK - 24"W, 8'L, @ 4' O.C.
DECORATIVE PICKET FENCE
LOUVERED SCREEN ENCLOSURE
DUMPSTER
UTILITY
COMPACTED AGGREGATE STORAGE
BALLAST (REFER TO TRACK DRAWINGS)
BICYCLE RACK
OUTDOOR TABLE WITH SEATING
CONCRETE CURB TURNOUT
ACCESSIBLE CURB RAMP
LOUVERED SCREEN GATE

LANDSCAPE PLANTING LEGEND



DECIDUOUS SHADE TREE



DECIDUOUS ORNAMENTAL TREE



EVERGREEN TREE





TURFGRASS SEEDING



NOT FOR CONSTRUCTION

NATIVE GRASS/FORB SEEDING





01 PLAN

SITE

SHEET

MATCHLINE

4

25 SPACES @ 10'-0"

26 SPACES @ 10'-0"

25 SPACES @ 10'-0"

5-60



SOUTH HAMMOND SITE PLAN



LYMAN AVENUE MONON TRAIL


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33 SPACES @ 10'-0"

33 SPACES @ 10'-0"

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CHECKED:	CGH		
DATE:	07/21/17		
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		FILENAME	
		SCALE	

	NICTD - WEST LAKE CORRIDOR - MP WL 61.38 TO WL 69.18 SINGLE TRACK			
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LENAME	SHT_WL_FA_SHS_PL_04.dgn	SHEET		
SCALE	AS NOTED	118	OF	361



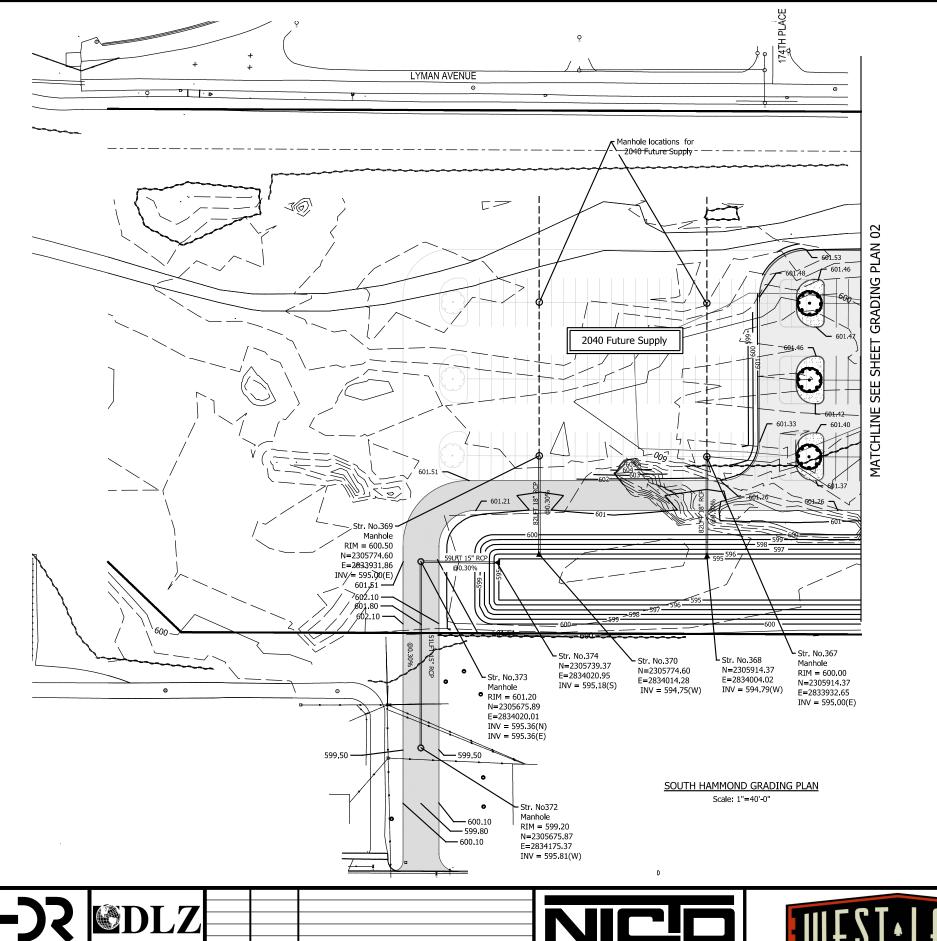

- PROPOSED GRADES AND SLOPES SHALL MATCH EXISTING GRADES AND SLOPES AT CONSTRUCTION LIMITS OR AS SHOWN ON DRAWING, TYP.
- UTILITIES AND UNDERGROUND OBSTACLES SHOWN ARE APPROXIMATE, FIELD VERIFTY UTILITY LOCATION PRIOR TO COMMENCEMENT OF EARTHWORK AND/OR UTILITY ACTIVITIES. THE CONTRACTOR SHALL BE RESPONSIBLE FOR ANY DAMAGE TO OBSTRUCTIONS AND UTILITY LINES ENCOUNTERED DURING CONSTRUCTION.
- PROPOSED FINISHED GRADES SHALL PROVIDE FOR POSITIVE DRAINAGE TO A DRAINAGE STRUCTURE OR DETENTION POND.
- NO OPEN TRENCHES WILL BE ALLOWED IN THE EVENING AFTER DAILY CONSTRUCTION OPERATIONS. CONTRACTOR TO PROVIDE CONSTRUCTION FORCING AROUND ANY TRENCHING AREA FOR PUBLIC SAFETY.
- CONTRACTOR SHALL FILL LOW/DEPRESSIONAL GRADES WHICH MAY OCCUR THROUGH REQUIRED DEMOLITION, AS WELL AS, ANY AREA WITHIN THE GRADING LIMITS, SO AS TO PROVIDE CONSTANT UNIFORM SLOPES WHICH MEET THE REQUIREMENTS.

GRADING LEGEND

New Drainage Pipe

New Drainage Inlet

New Drainage End Section

New Drainage Manhole

Proposed Contours

Existing Contours

BOTTOM OF CURB Spot Elevations

XXX.XX Spot Elevations

NOT FOR CONSTRUCTION

DPH

CGH

07/21/17

RAWN: HECKED:

DATE:

NICTD - WEST LAKE CORRIDOR - MP W SINGLE TRACK

SOUTH HAMMOND GRADING **FACILITY**

SHT_WL_FA_SHS_GD_01.dgn


119 OF 361

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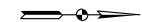







E: 7/19/2017

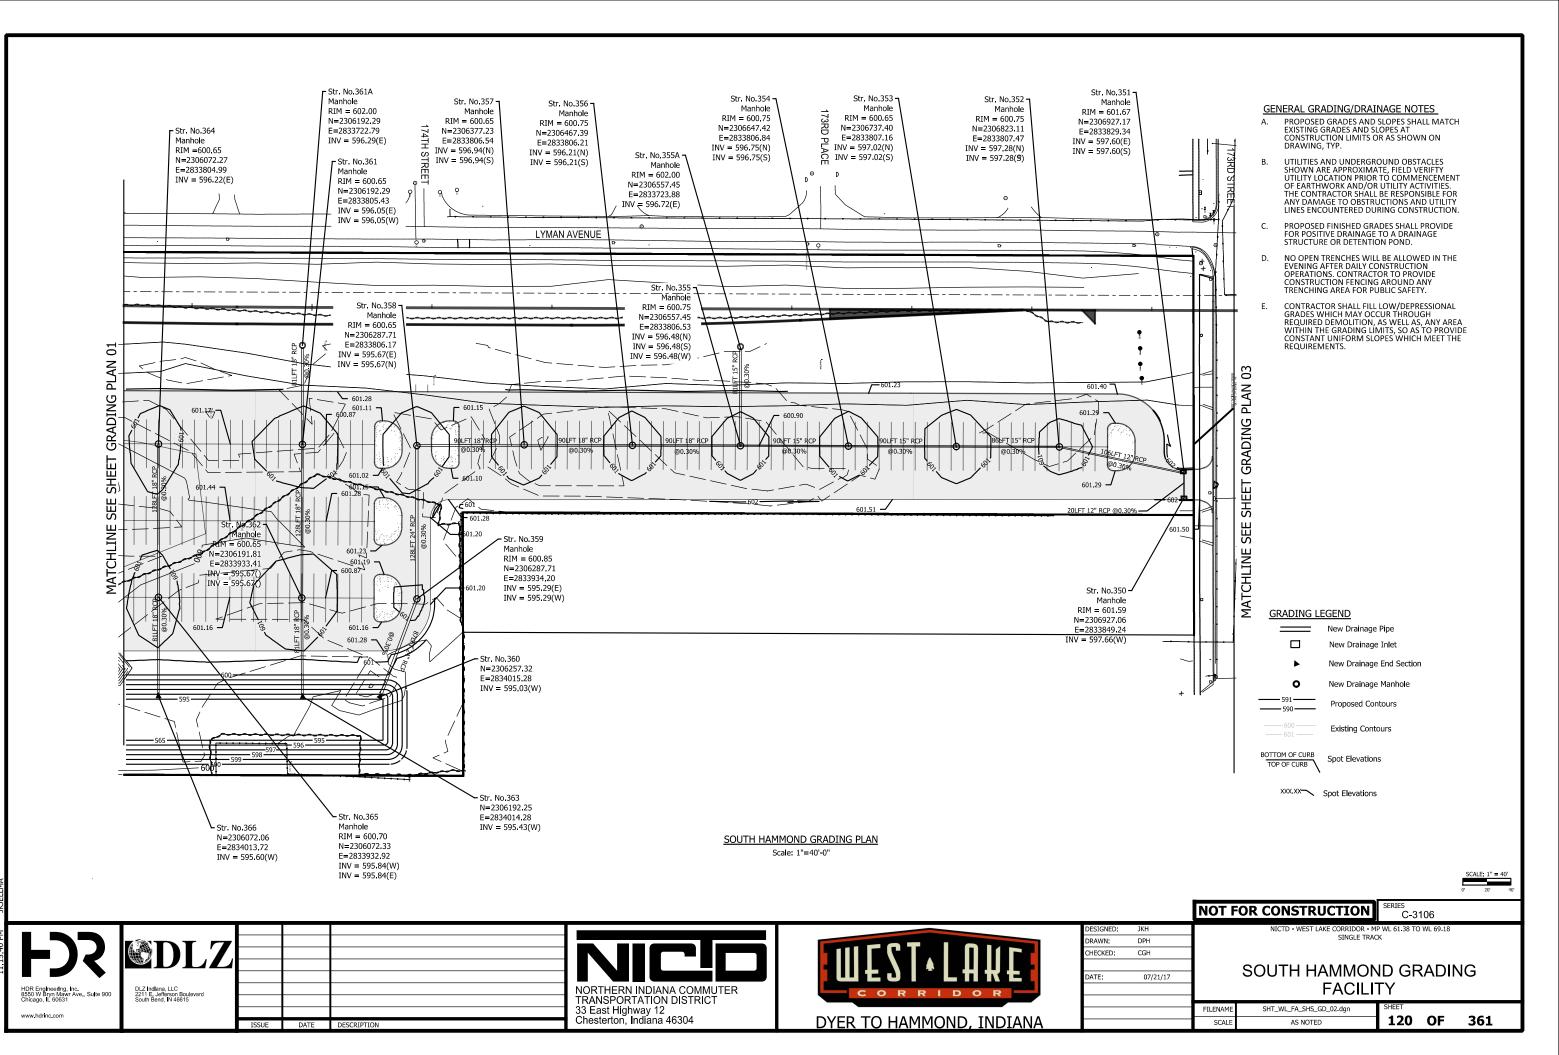LOT DATE: 7/19/201



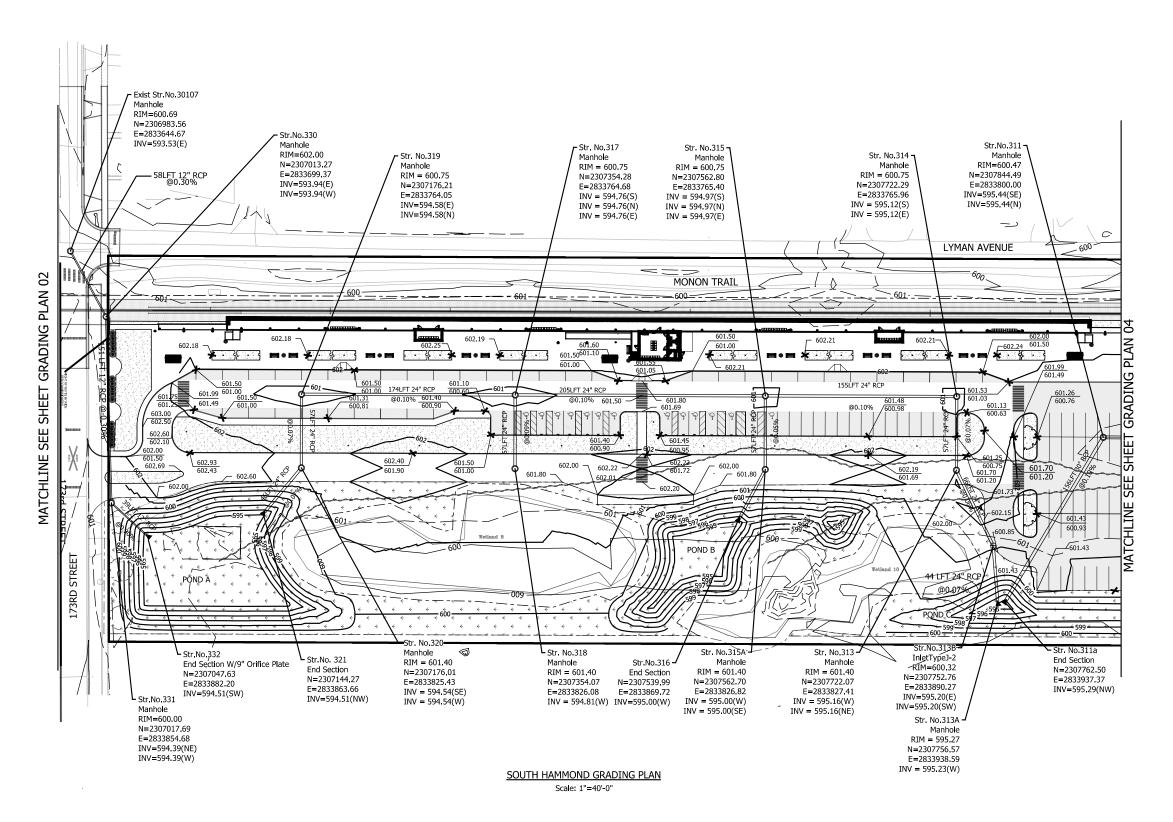

GENERAL GRADING/DRAINAGE NOTES

- PROPOSED GRADES AND SLOPES SHALL MATCH EXISTING GRADES AND SLOPES AT CONSTRUCTION LIMITS OR AS SHOWN ON
- UTILITIES AND UNDERGROUND OBSTACLES SHOWN ARE APPROXIMATE, FIELD VERIFTY UTILITY LOCATION PRIOR TO COMMENCEMENT OF EARTHWORK AND/OR UTILITY ACTIVITIES. THE CONTRACTOR SHALL BE RESPONSIBLE FOR ANY DAMAGE TO OBSTRUCTIONS AND UTILITY
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GRADING LEGEND

New Drainage Inlet

New Drainage End Section

New Drainage Manhole

Proposed Contours

Existing Contours

BOTTOM OF CURB Spot Elevations TOP OF CURB

XXX.XX Spot Elevations

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Chesterton, Indiana 46304



DESIGNED:	JKH	
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DATE:	07/21/17	
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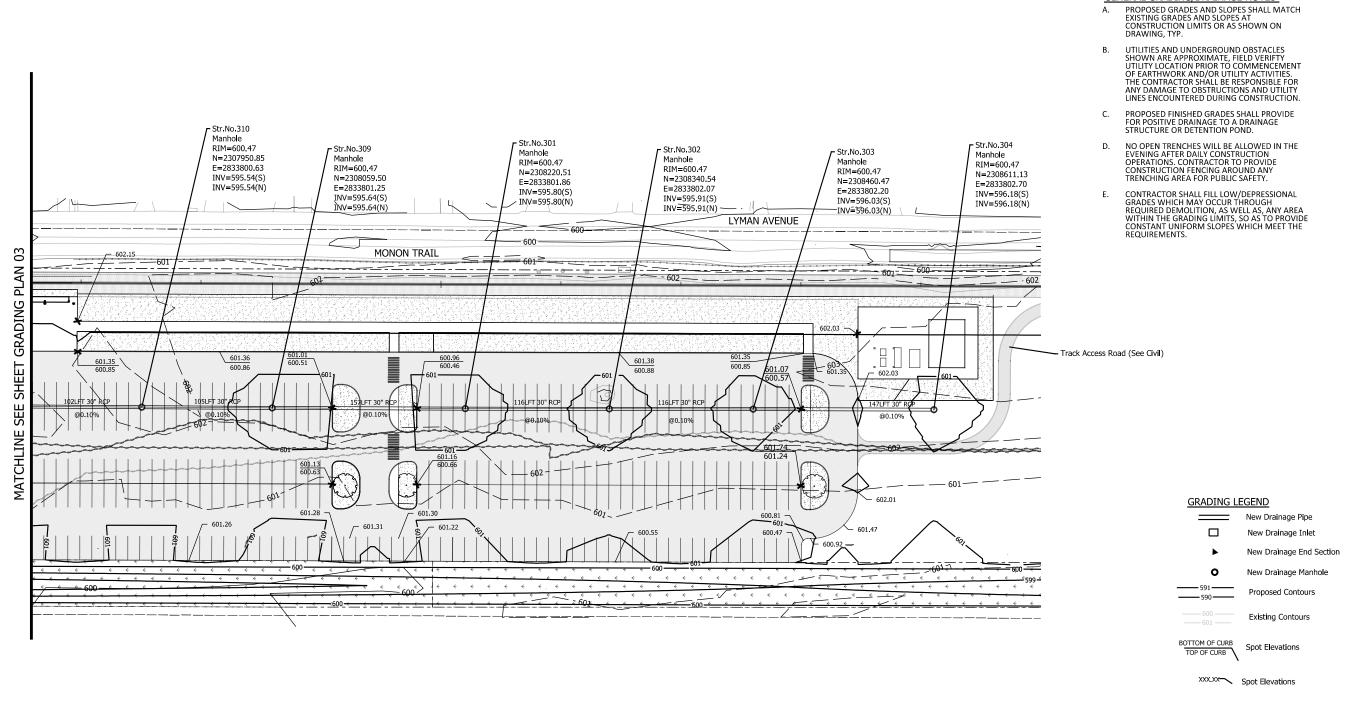
SINGLE TRACK
SOUTH HAMMOND GRADING
FACILITY

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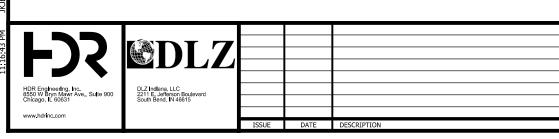
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GENERAL GRADING/DRAINAGE NOTES



SOUTH HAMMOND GRADING PLAN Scale: 1"=40'-0"



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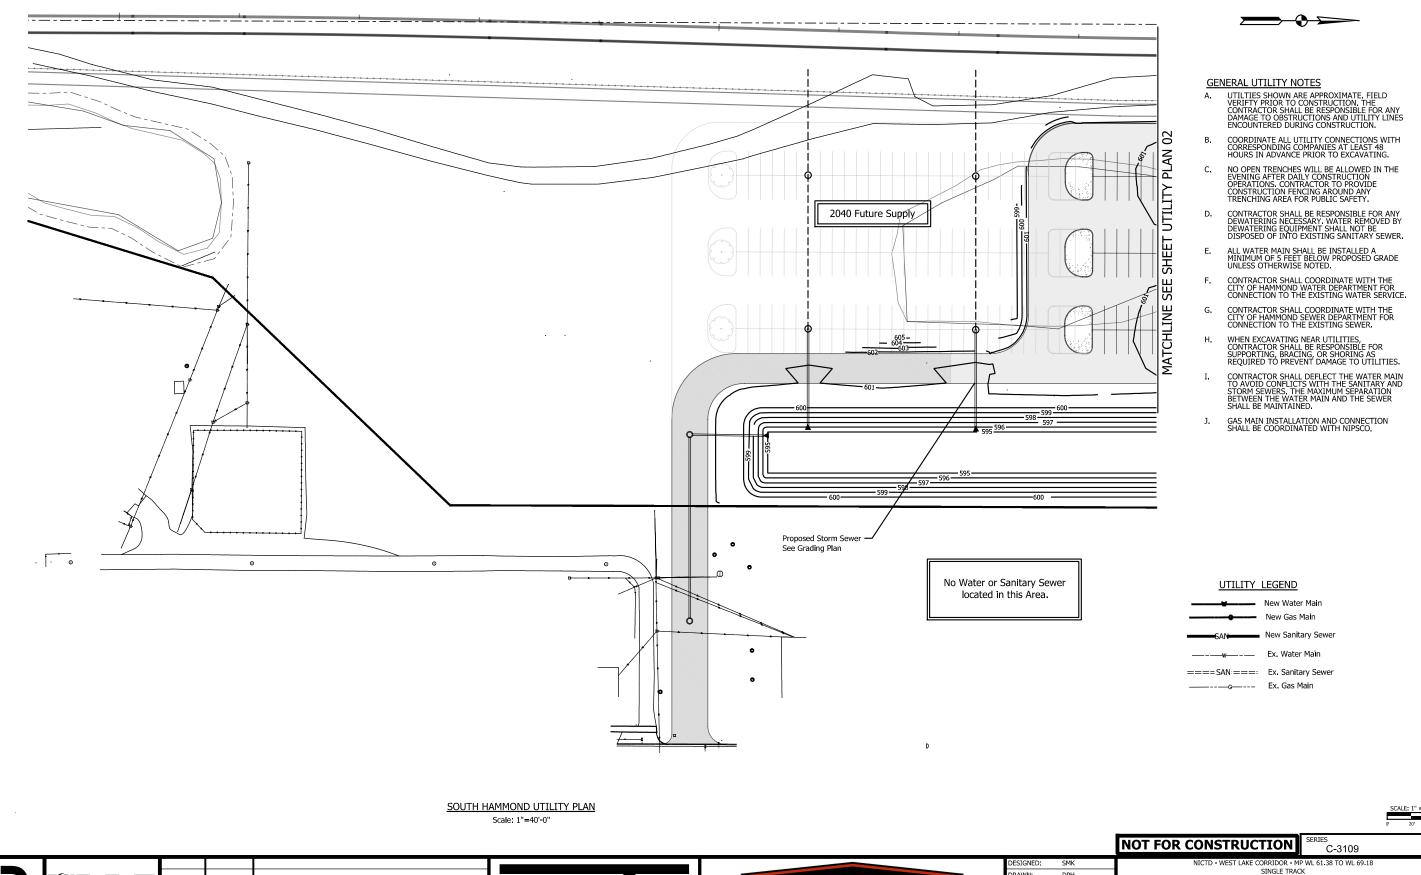


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NICTD - WEST LAKE CORRIDOR - MP W SINGLE TRACK SOUTH HAMMOND GRADING **FACILITY**

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SOUTH HAMMOND UTILITY PLAN

FACILITY

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SHEET

SEE

MATCHLINE

DPH

CGH

07/21/17

RAWN: HECKED:

DATE:

GENERAL UTILITY NOTES

- UTILITIES SHOWN ARE APPROXIMATE. FIELD VERIFTY PRIOR TO CONSTRUCTION. THE CONTRACTOR SHALL BE RESPONSIBLE FOR ANY DAMAGE TO OBSTRUCTIONS AND UTILITY LINES ENCOUNTERED DURING CONSTRUCTION.
- COORDINATE ALL UTILITY CONNECTIONS WITH CORRESPONDING COMPANIES AT LEAST 48 HOURS IN ADVANCE PRIOR TO EXCAVATING.
- NO OPEN TRENCHES WILL BE ALLOWED IN THE EVENING AFTER DAILY CONSTRUCTION OPERATIONS, CONTRACTOR TO PROVIDE CONSTRUCTION FACURE ON ANY TRENCHING AREA FOR PUBLIC SAFETY.
- CONTRACTOR SHALL BE RESPONSIBLE FOR ANY DEWATERING NECESSARY. WATER REMOVED BY DEWATERING EQUIPMENT SHALL NOT BE DISPOSED OF INTO EXISTING SANITARY SEWER.
- ALL WATER MAIN SHALL BE INSTALLED A MINIMUM OF 5 FEET BELOW PROPOSED GRADE UNLESS OTHERWISE NOTED.
- CONTRACTOR SHALL COORDINATE WITH THE CITY OF HAMMOND WATER DEPARTMENT FOR CONNECTION TO THE EXISTING WATER SERVICE.
- CONTRACTOR SHALL COORDINATE WITH THE CITY OF HAMMOND SEWER DEPARTMENT FOR CONNECTION TO THE EXISTING SEWER.
- WHEN EXCAVATING NEAR UTILITIES, CONTRACTOR SHALL BE RESPONSIBLE FOR SUPPORTING, BRACING, OR SHORING AS REQUIRED TO PREVENT DAMAGE TO UTILITIES.
- CONTRACTOR SHALL DEFLECT THE WATER MAIN TO AVOID CONFLICTS WITH THE SANITARY AND STORM SEWERS. THE MAXIMUM SEPARATION BETWEEN THE WATER MAIN AND THE SEWER SHALL BE MAINTAINED.
- GAS MAIN INSTALLATION AND CONNECTION SHALL BE COORDINATED WITH NIPSCO.

UTILITY LEGEND

New Water Main New Gas Main New Sanitary Sewer

— Ex. Water Main

==== SAN:===: Ex. Sanitary Sewer ——g——— Ex. Gas Main

SOUTH HAMMOND UTILITY PLAN Scale: 1"=40'-0"

No Water or Sanitary Sewer

located in this Area.

LYMAN AVENUE


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NICTD - WEST LAKE CORRIDOR - MP W SINGLE TRACK

SOUTH HAMMOND UTILITY PLAN **FACILITY**

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124 OF 361




NORTHERN INDIANA COMMUTER TRANSPORTATION DISTRICT 33 East Highway 12 Chesterton, Indiana 46304

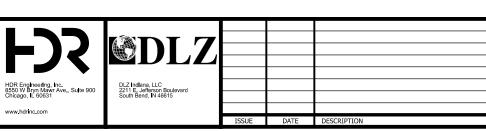See Grading Plan




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GENERAL UTILITY NOTES

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New Water Main

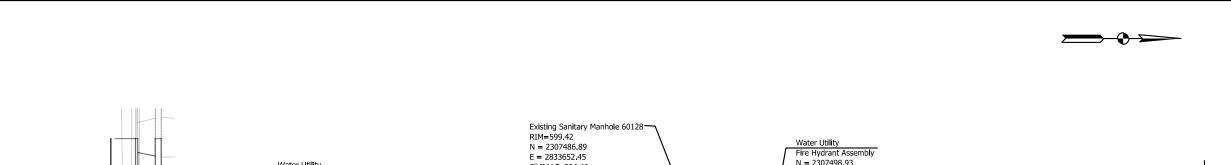New Gas Main New Sanitary Sewe

UTILITY LEGEND

Ex. Water Main ====SAN:===: Fx. Sanitary Sewer

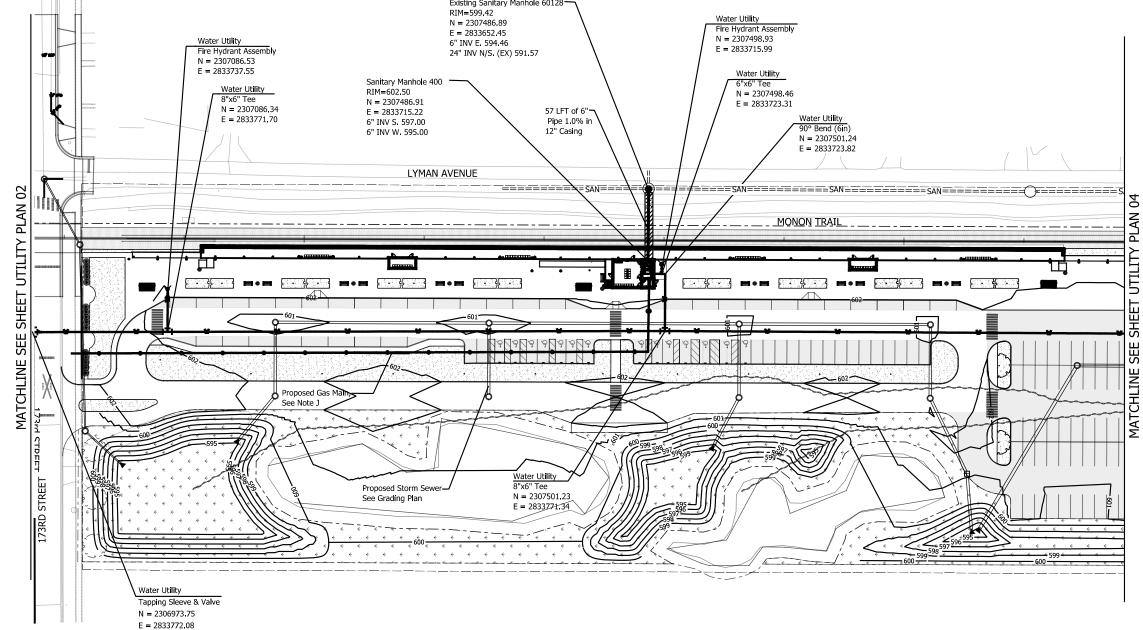SOUTH HAMMOND UTILITY PLAN







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CHECKED:	CGH	
DATE:	07/21/17	
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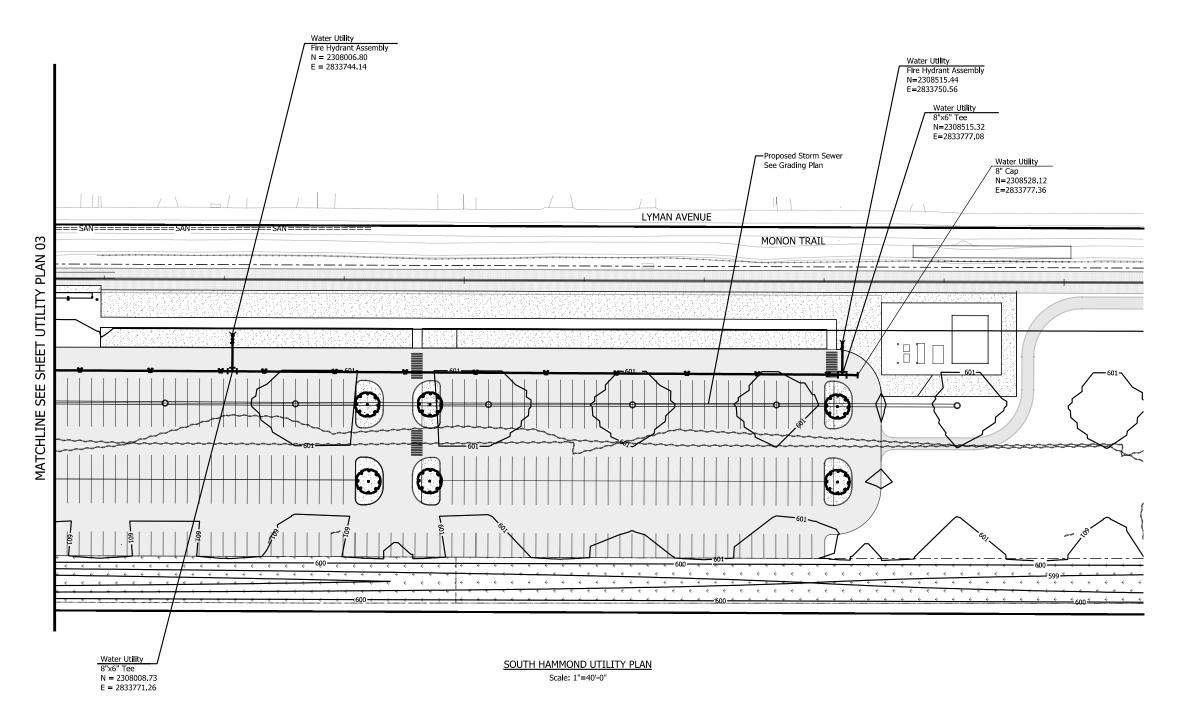
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SOUTH HAMMOND UTILITY PLAN **FACILITY**

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GENERAL UTILITY NOTES


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Ex. Water Main

--- Ex. Gas Main

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DESIGNED:	JKH	
DRAWN:	DPH	
CHECKED:	CGH	
DATE:	07/21/17	,
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NICTD - WEST LAKE CORRIDOR - MP W SINGLE TRACK


SOUTH HAMMOND UTILITY PLAN **FACILITY**


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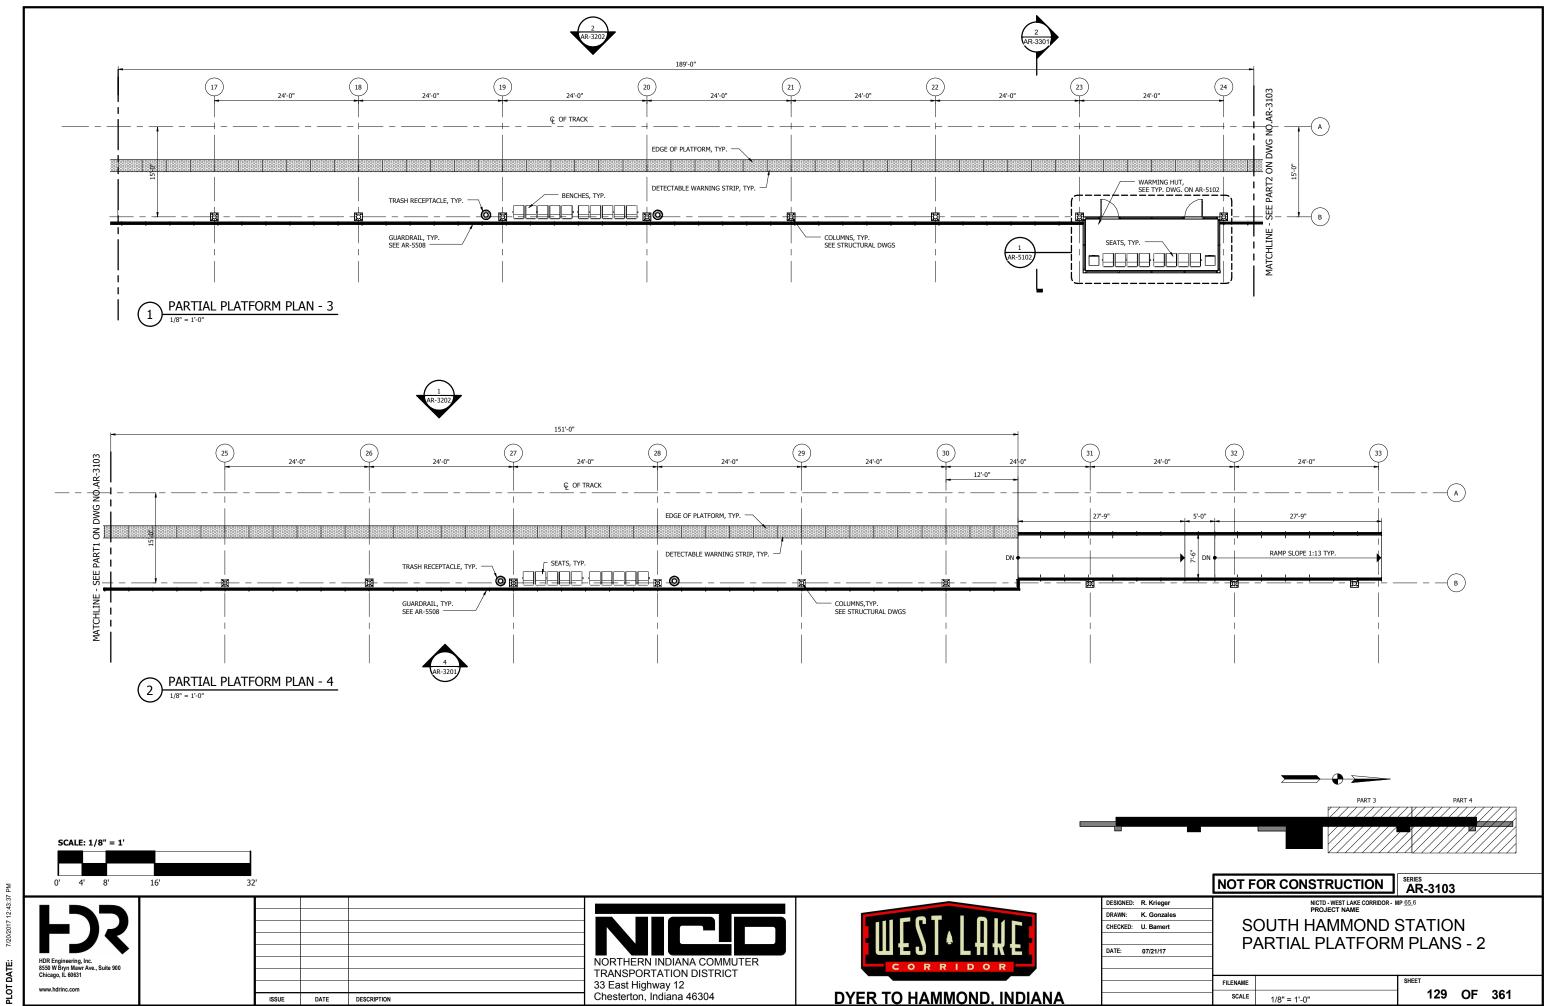
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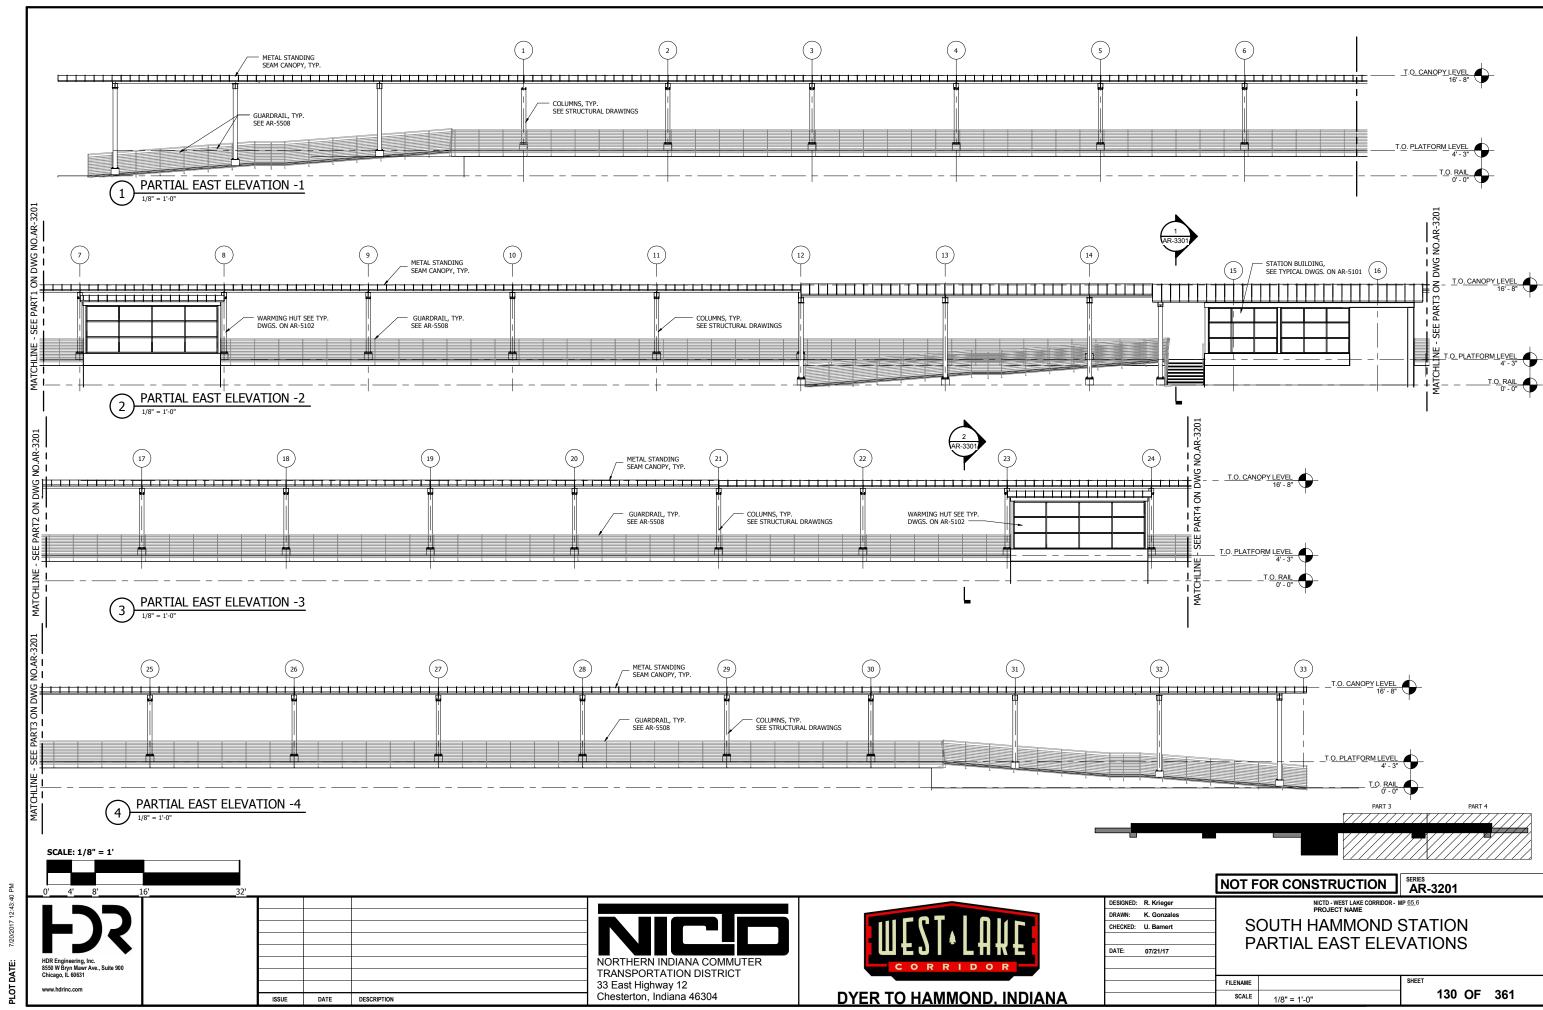
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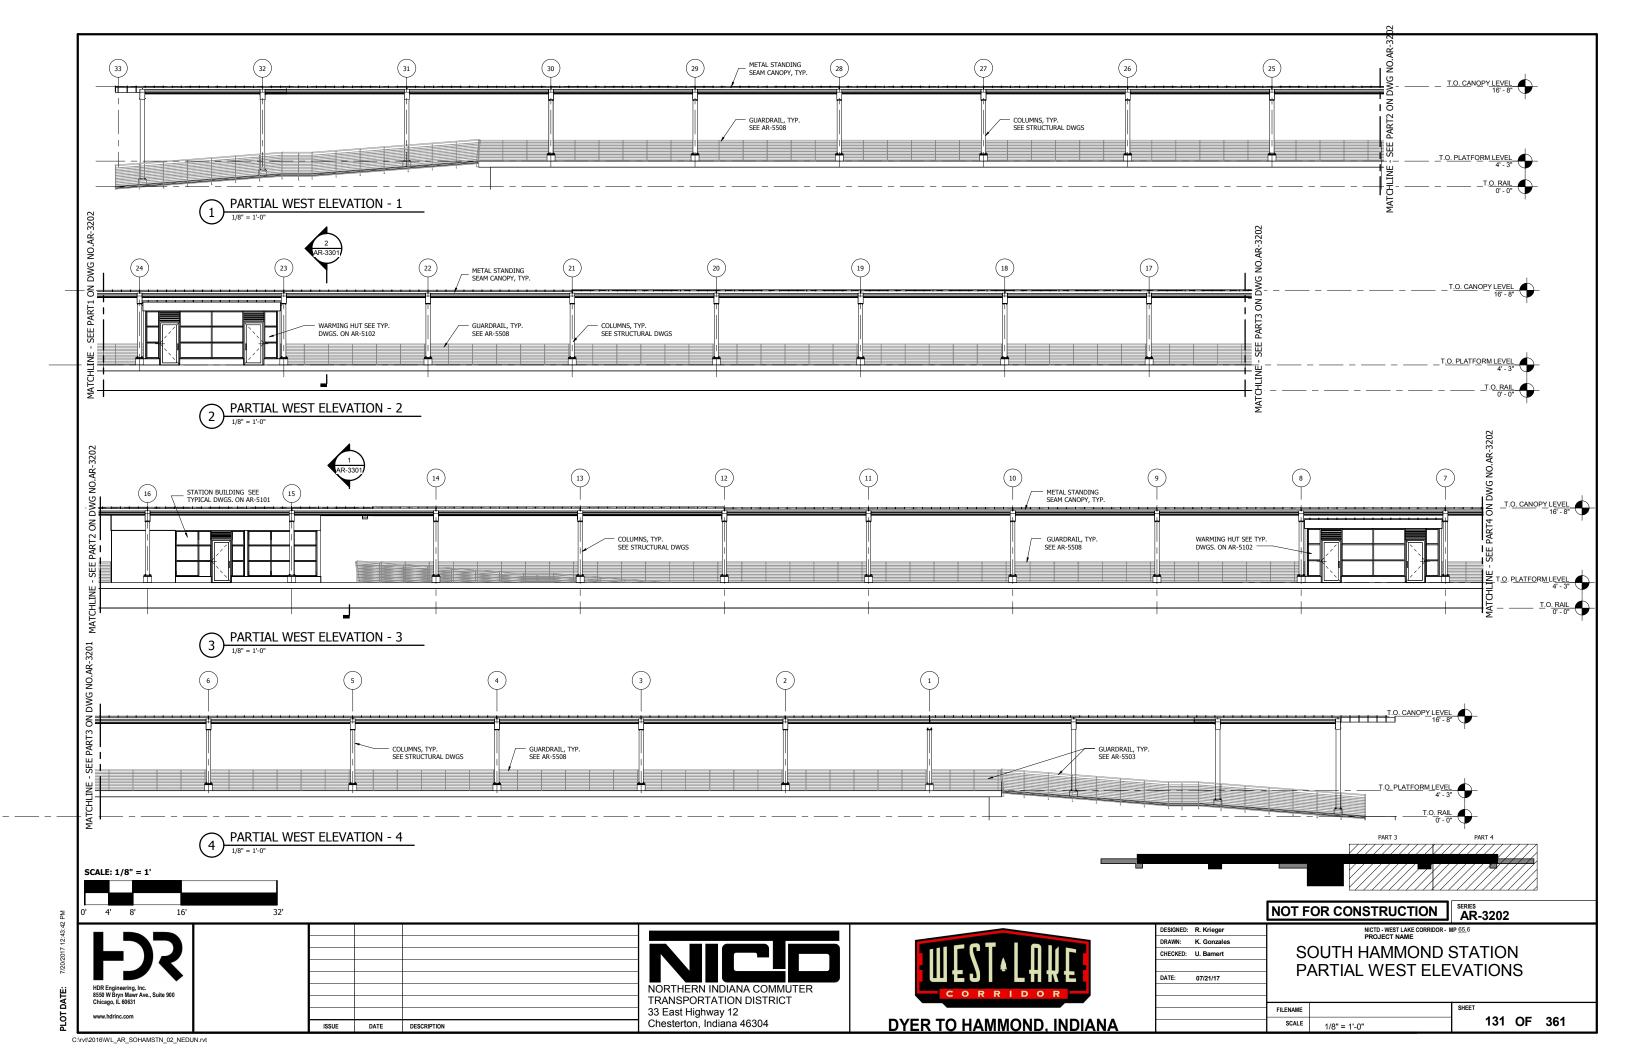
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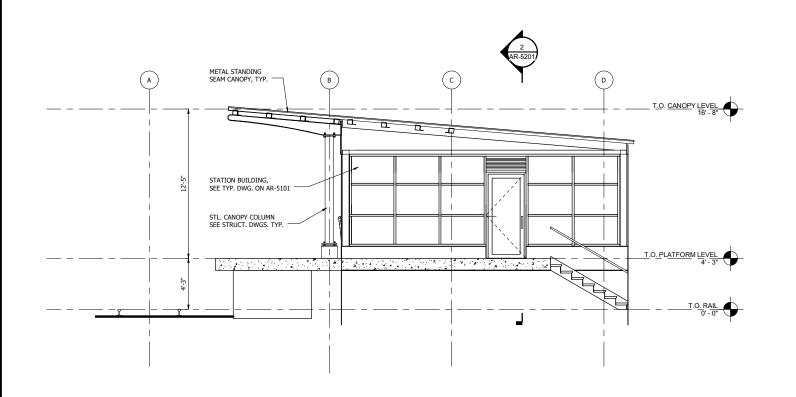


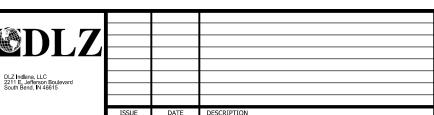






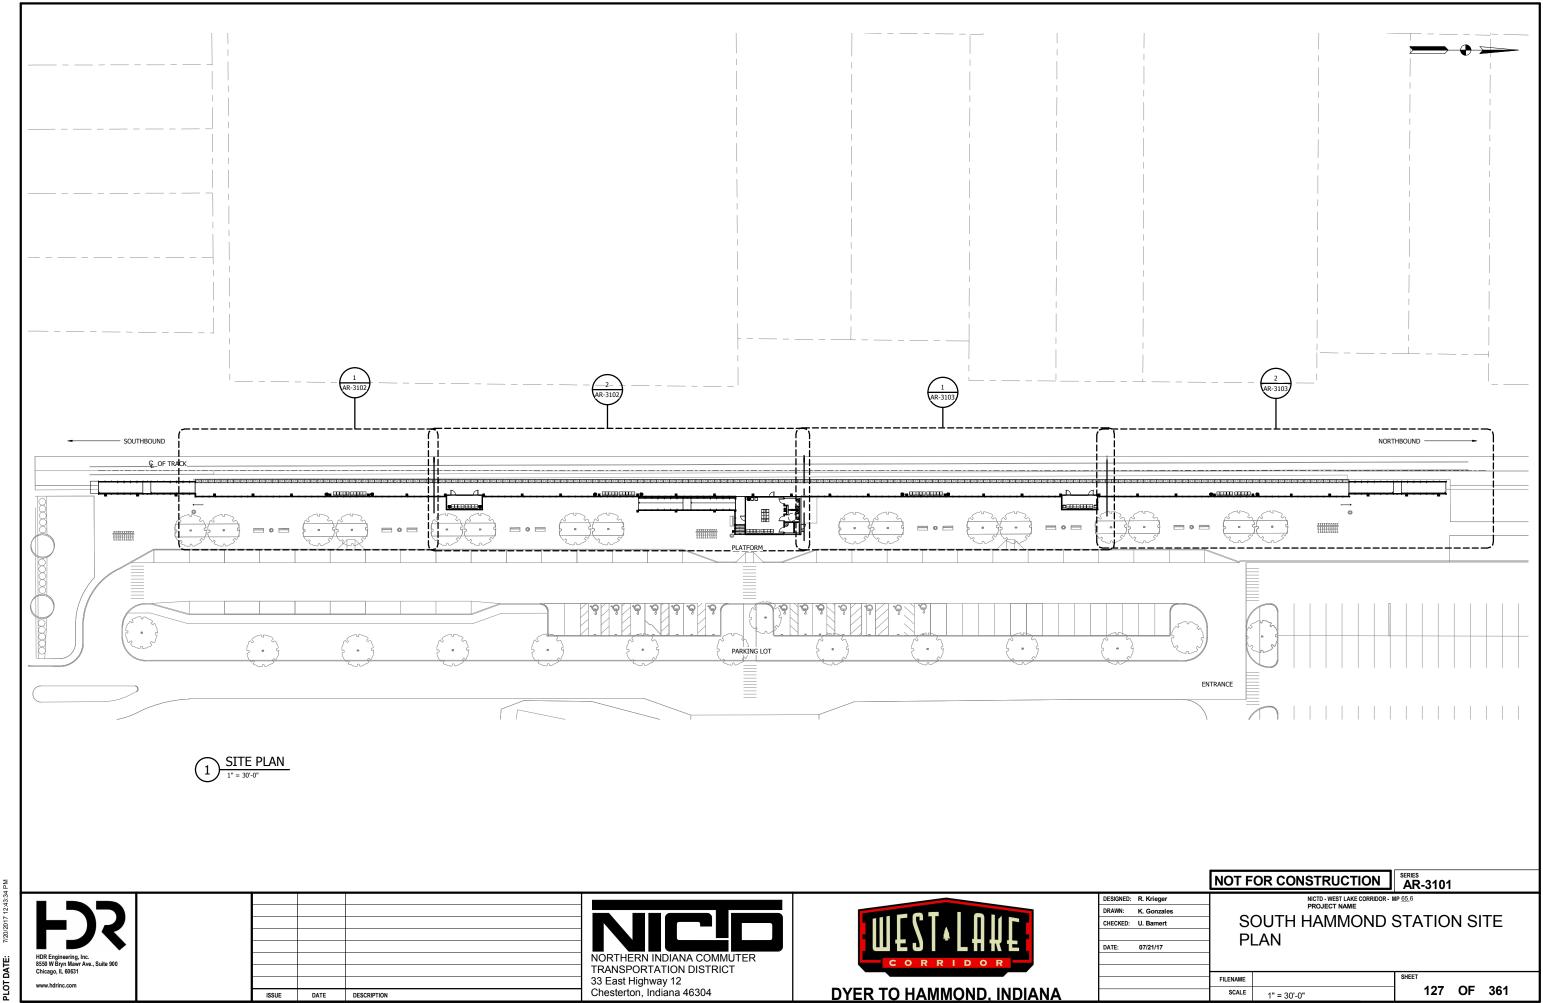

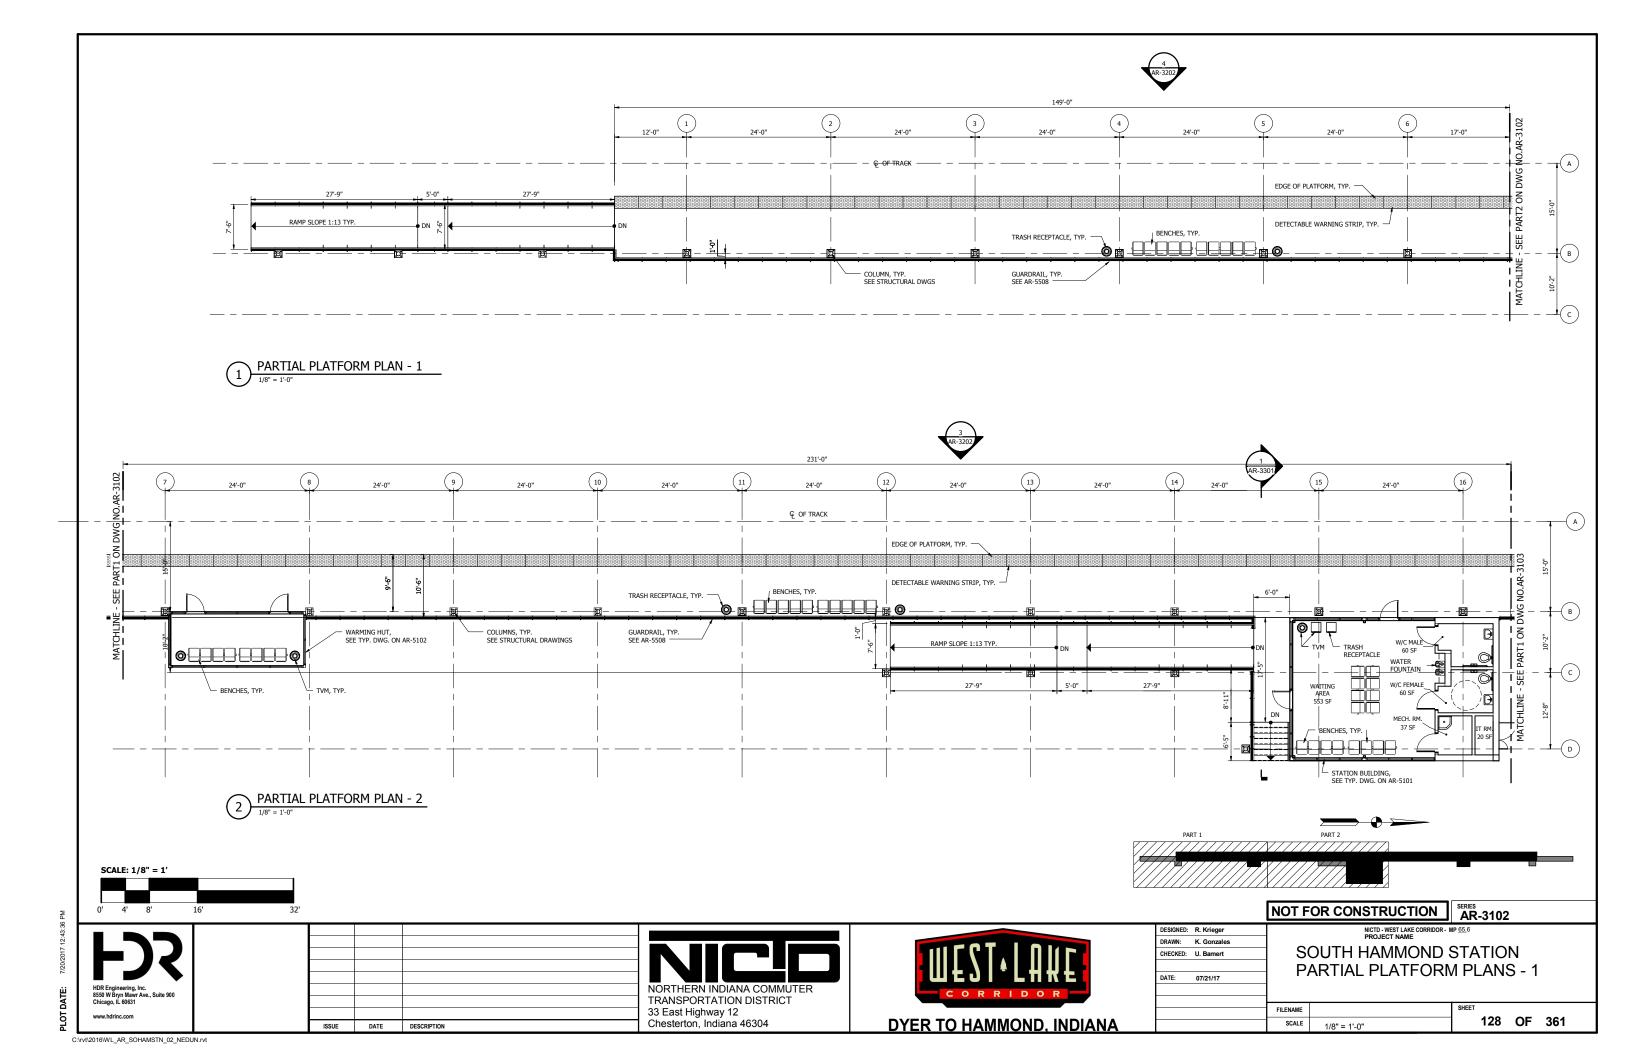

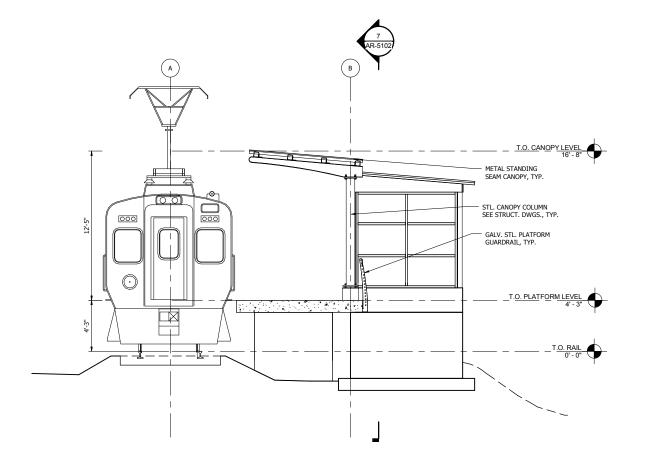

STATION SECTION 1

ISSUE DATE DESCRIPTION

PLATFORM CROSS SECTION

1/4" = 1'-0"

NOTES
1. FOR ELEVATIONS AND GRADE, SEE CIVIL DRAWINGS.

132 OF 361

0' 2' 4' 8'

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Chicago, IL 80631
www.hdrinc.com

SCALE: 1/4" = 1'

NORTHERN INDIANA COMMUTER TRANSPORTATION DISTRICT 33 East Highway 12 Chesterton, Indiana 46304



DESIGNED: R. Krieger
DRAWN: K. Gonzales
CHECKED: U. Barnert

DATE: 07/21/17

NICTD - WEST LAKE CORRIDOR - MP 65.6
PROJECT NAME


SOUTH HAMMOND STATION
CROSS SECTIONS

FILENAME

SHEET

1/4" = 1'-0"

SCALE

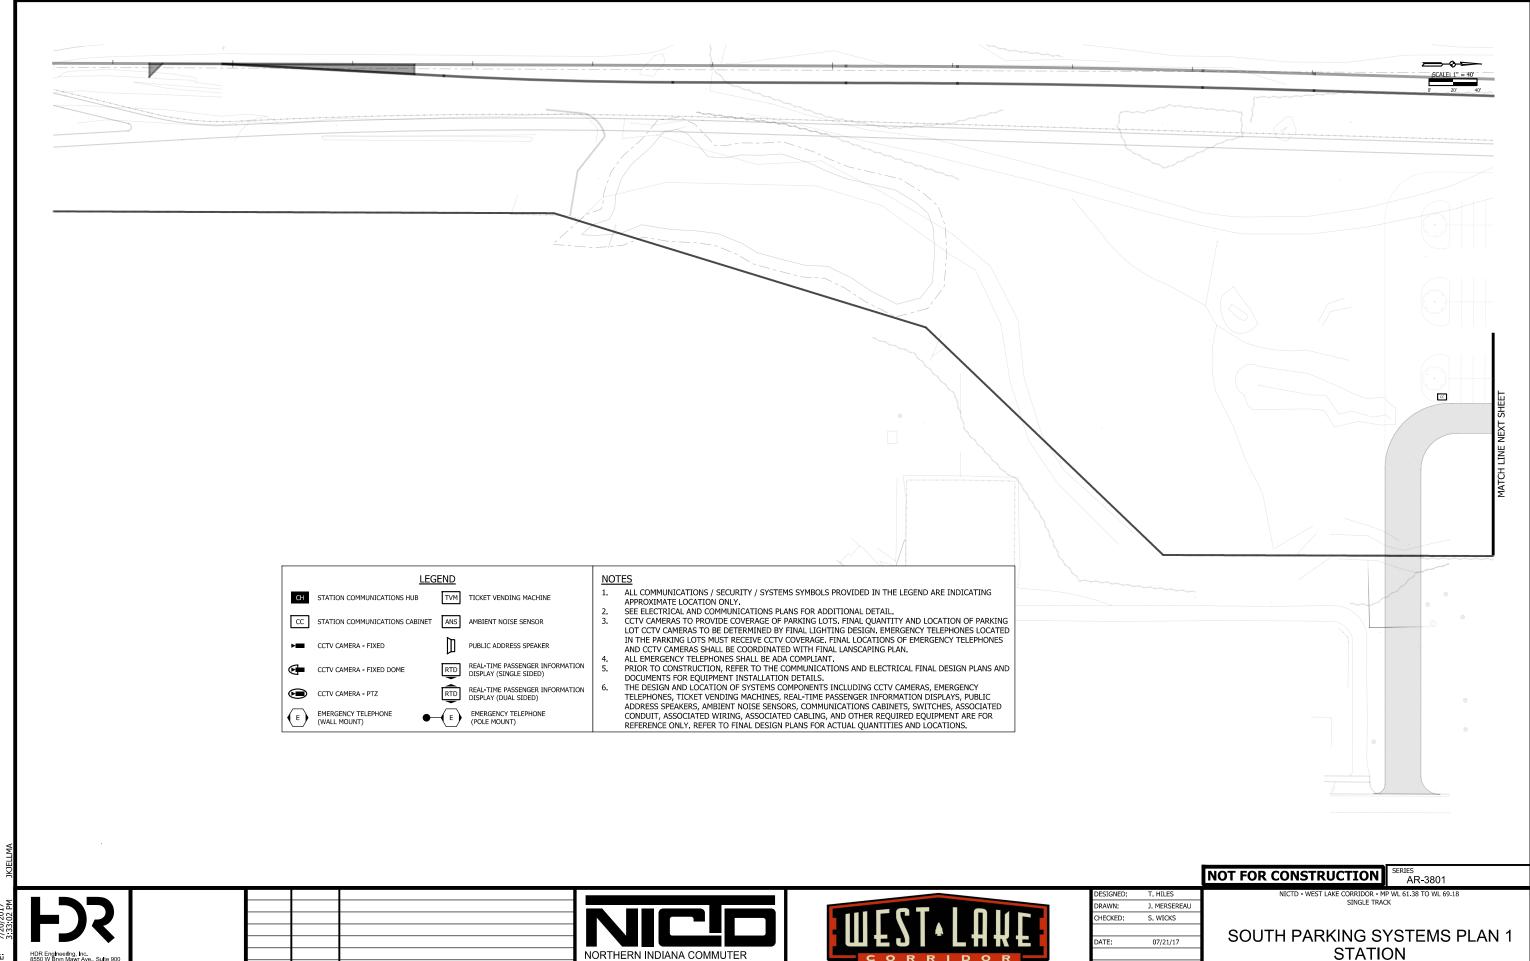









		NO
DESIGNED:	T. HILES	
DRAWN:	J. MERSEREAU	
CHECKED:	S. WICKS	
DATE:	07/21/17	`
		FILENA

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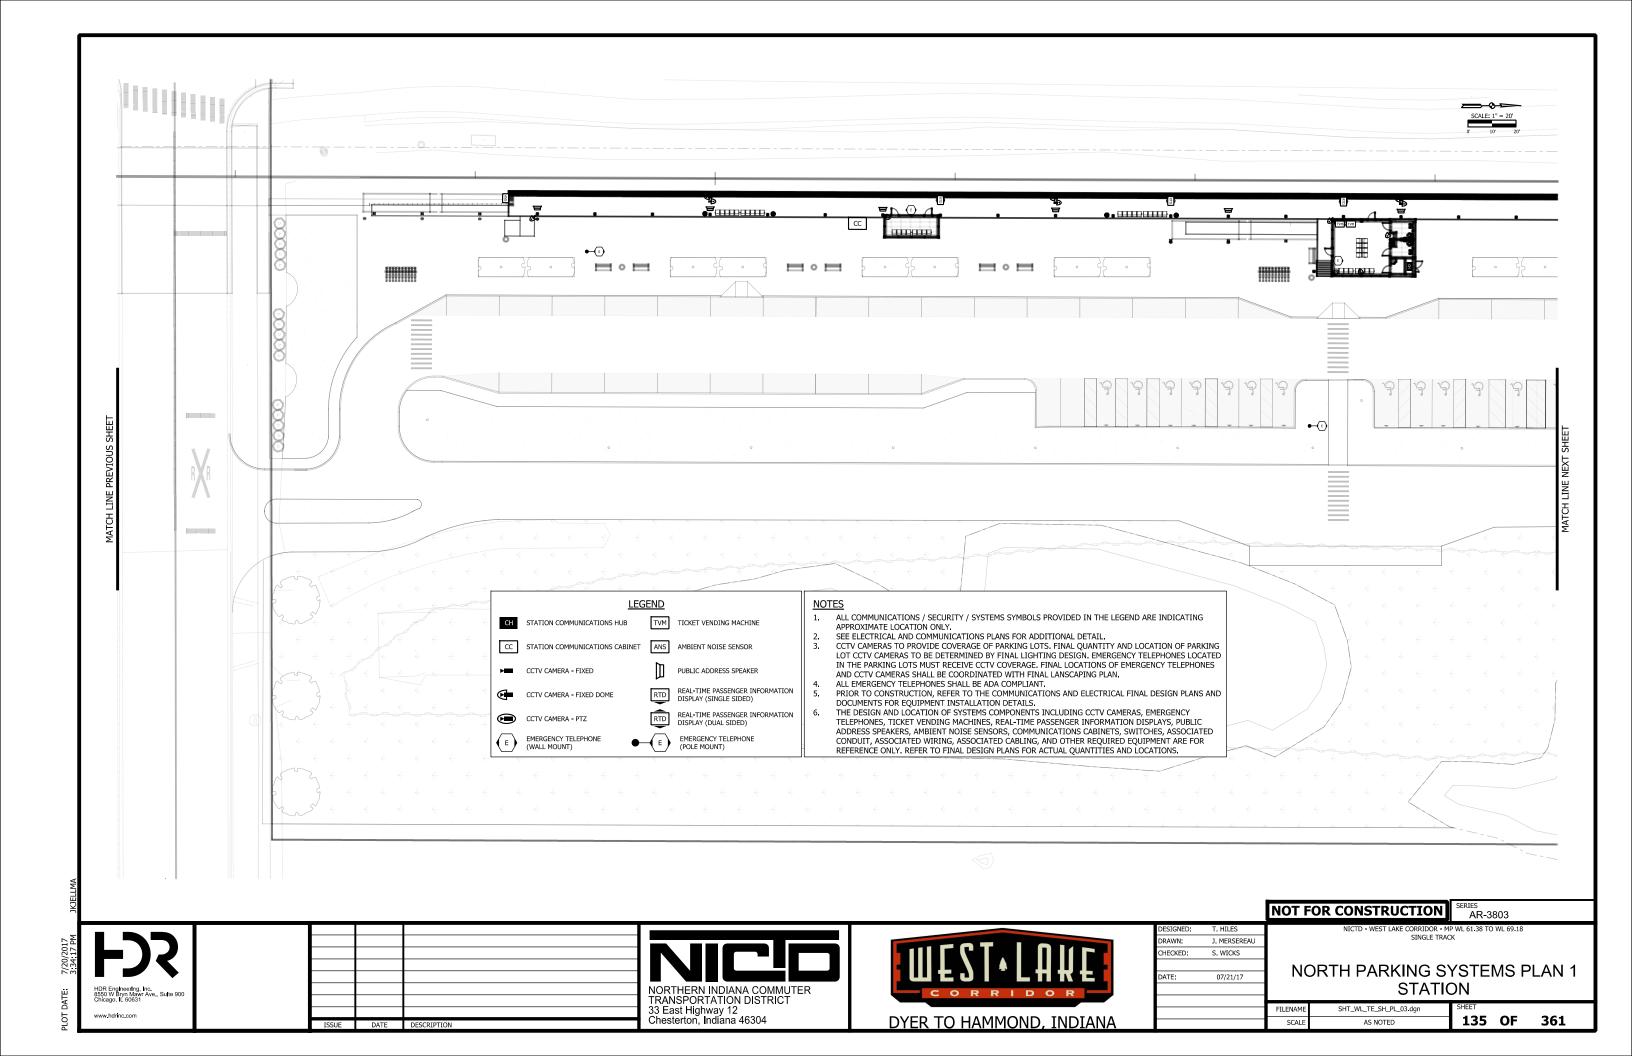


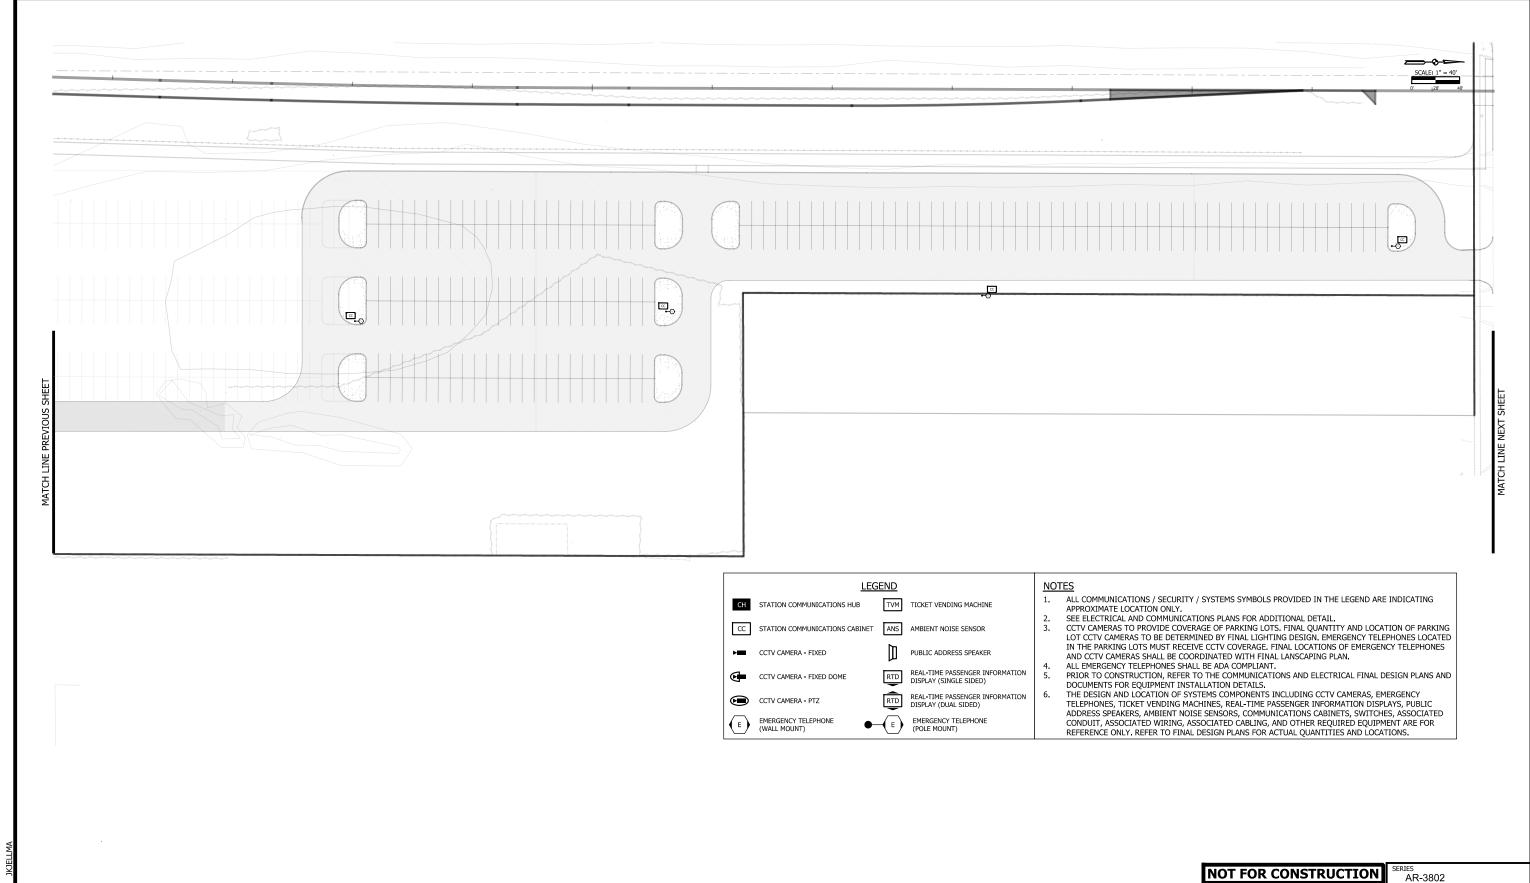
		LIA.
DESIGNED:	T. HILES	
DRAWN:	J. MERSEREAU	
CHECKED:	S. WICKS	
DATE:	07/21/17	

AR-3802 VICTD - WEST LAKE CORRIDOR - MP WL 61.38 TO WL 69.18 SINGLE TRACK

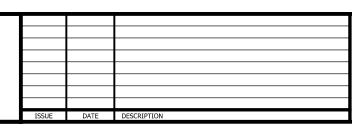SOUTH PARKING SYSTEMS PLAN 2 **STATION**

SHT_WL_TE_SH_PL_02.dgn



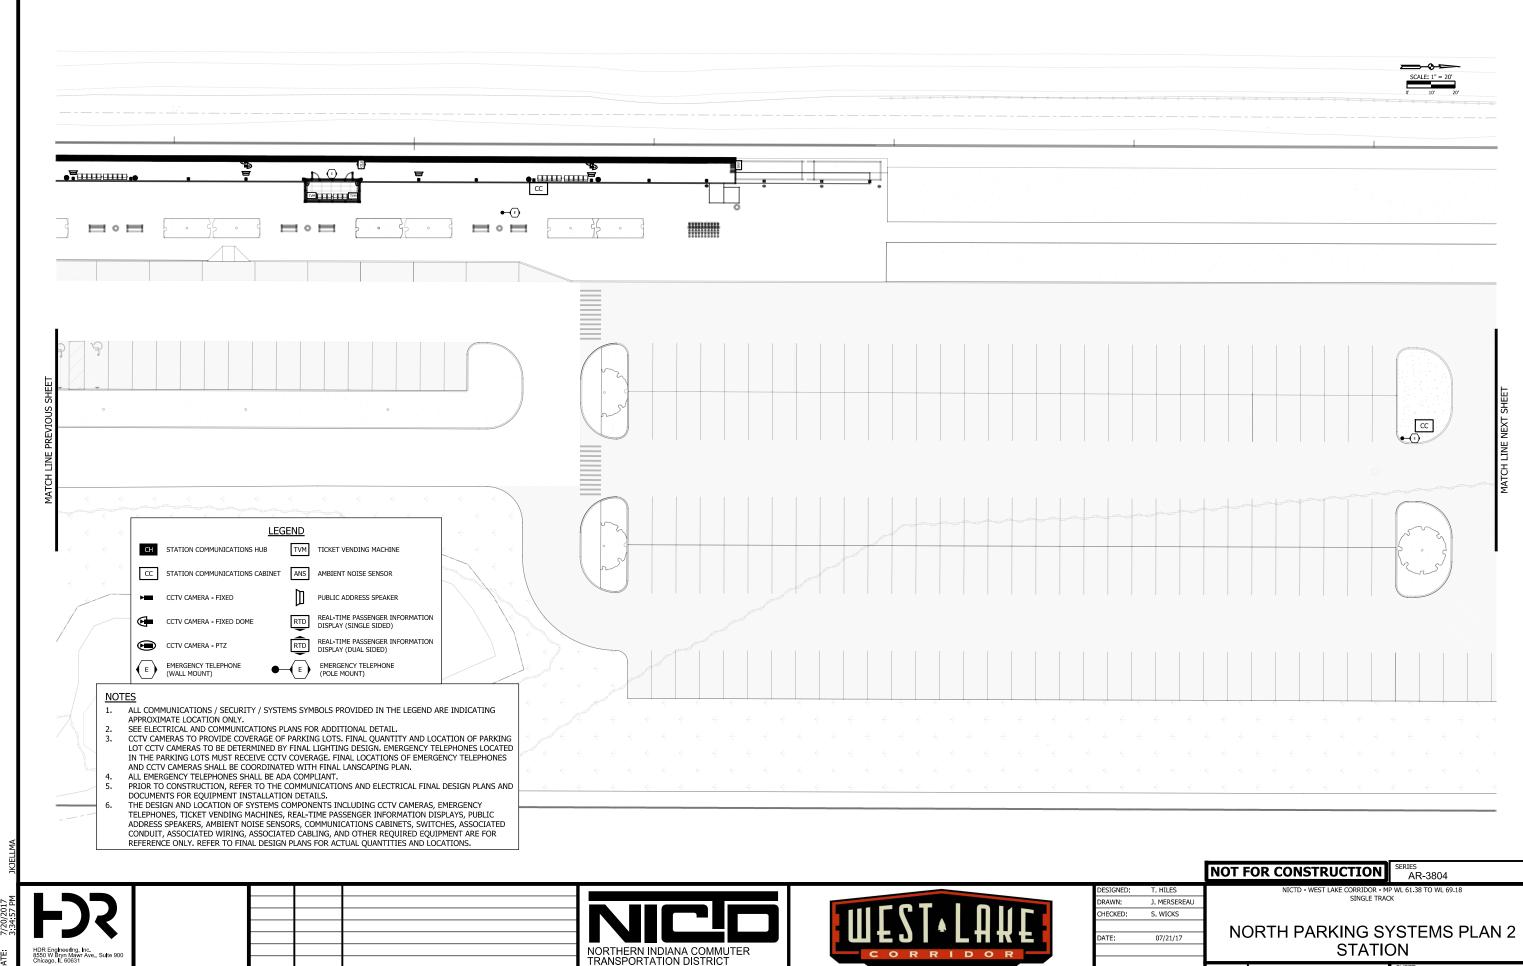


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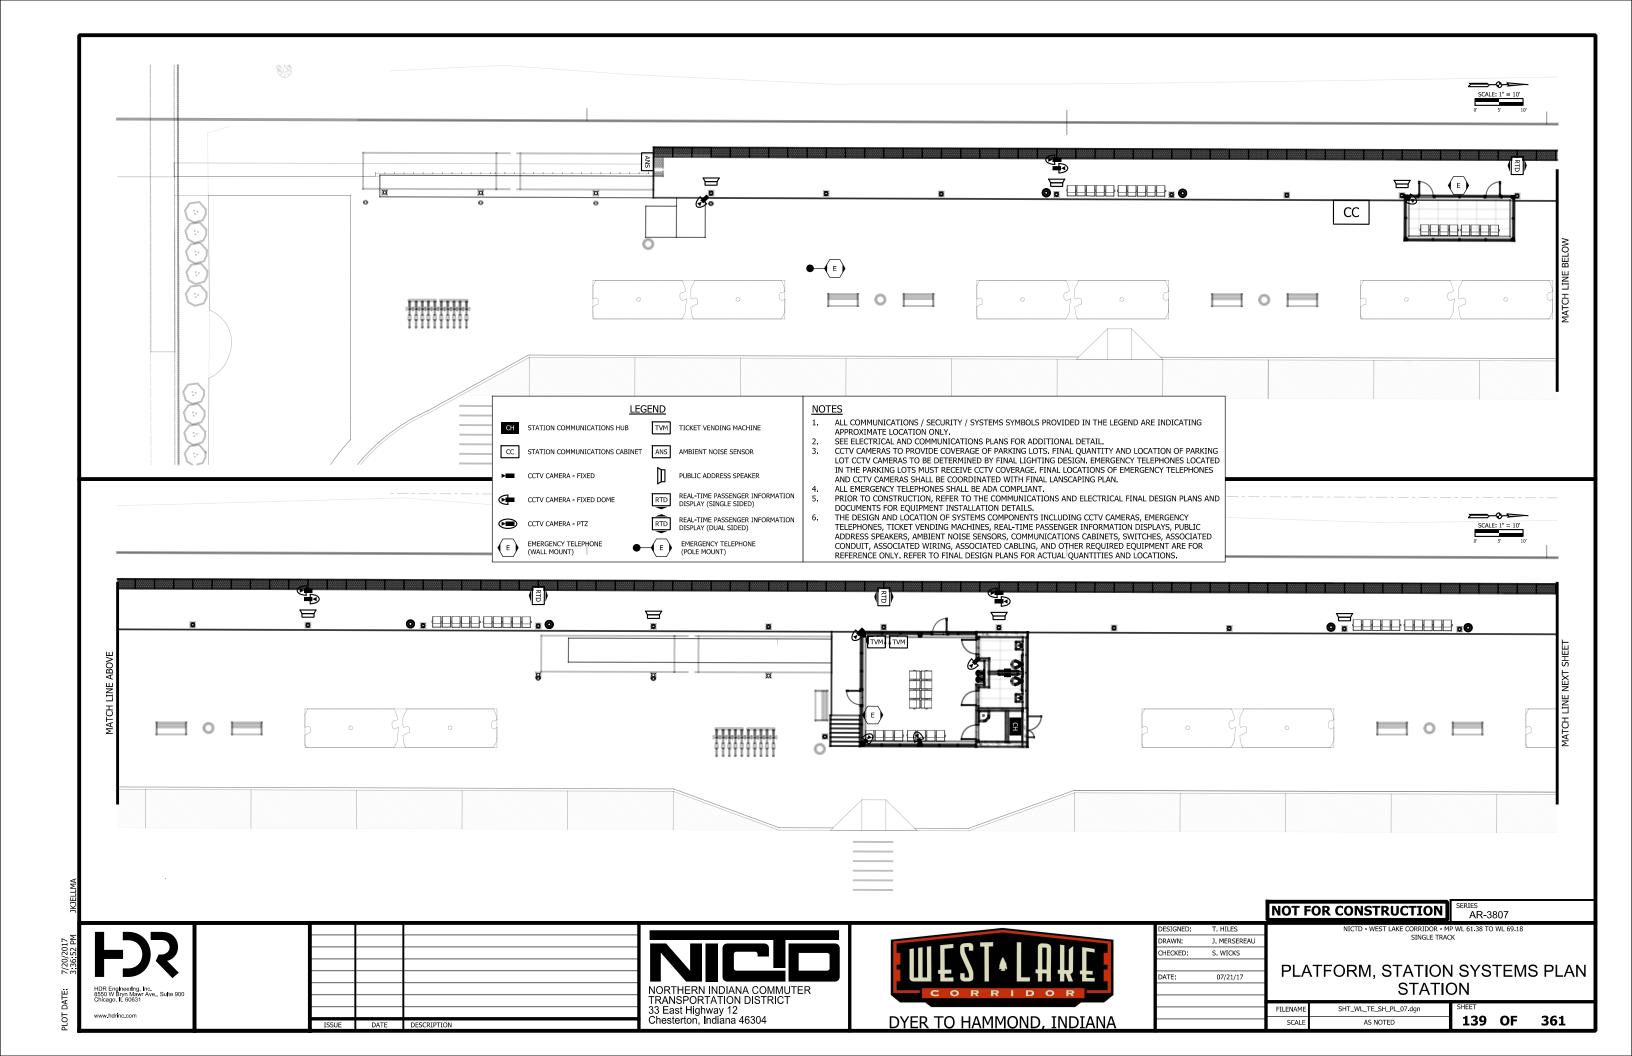



		110
DESIGNED:	T. HILES	
DRAWN:	J. MERSEREAU	
CHECKED:	S. WICKS	
		l i
DATE:	07/21/17	' ا
		ETLEN


NOT FOR CONSTRUCTION SERIES AR-3806 NICTD - WEST LAKE CORRIDOR - MP WL 61.38 TO WL 69.18 SINGLE TRACK

NORTH PARKING SYSTEMS PLAN 4 STATION

SHT_WL_TE_SH_PL_06.dgn

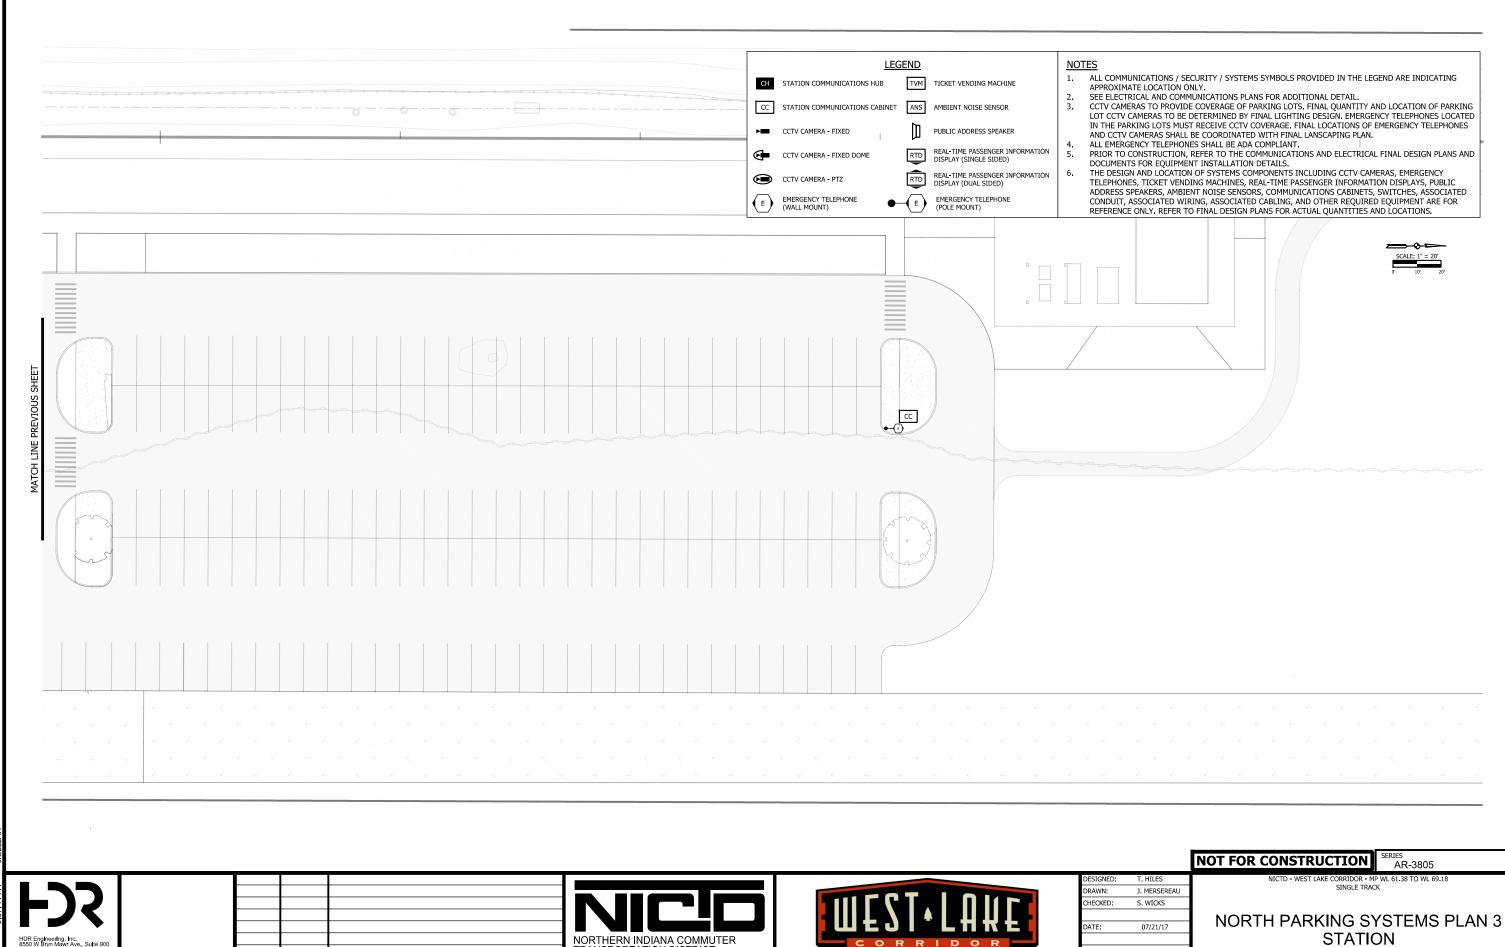

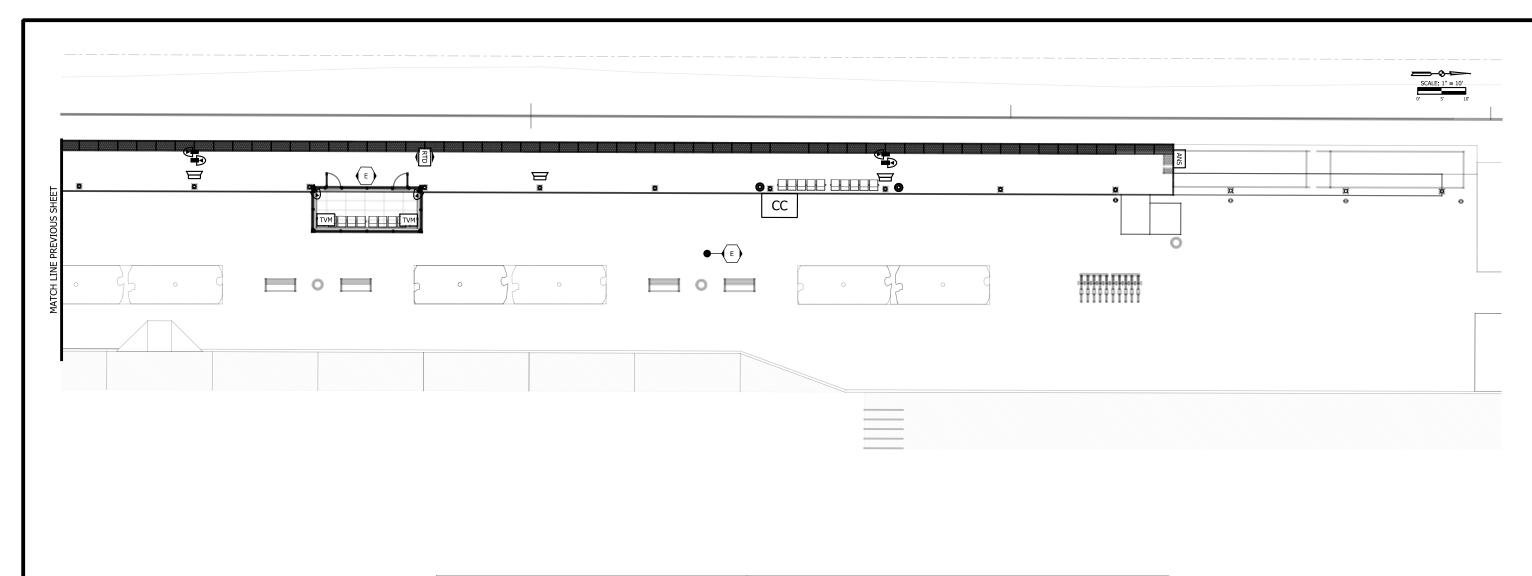

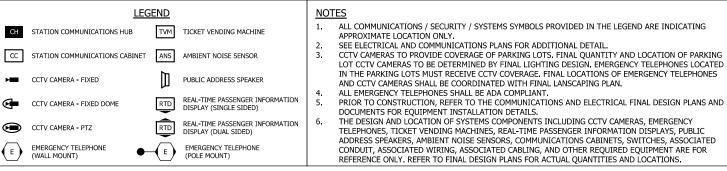

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		NOT FOR CONSTRUCTION
DESIGNED:	T. HILES	NICTD - WEST LAKE CORRIDOR - M
DRAWN:	J. MERSEREAU	SINGLE TRAC
CHECKED:	S. WICKS	
		PLATFORM SYS
DATE:	07/21/17	,
		STATIO


NICTD - WEST LAKE CORRIDOR - MP WL 61.38 TO WL 69.18 SINGLE TRACK

PLATFORM SYSTEMS PLAN **STATION**


SHT_WL_TE_SH_PL_08.dgn

140 OF 361


SERIES AR-3808

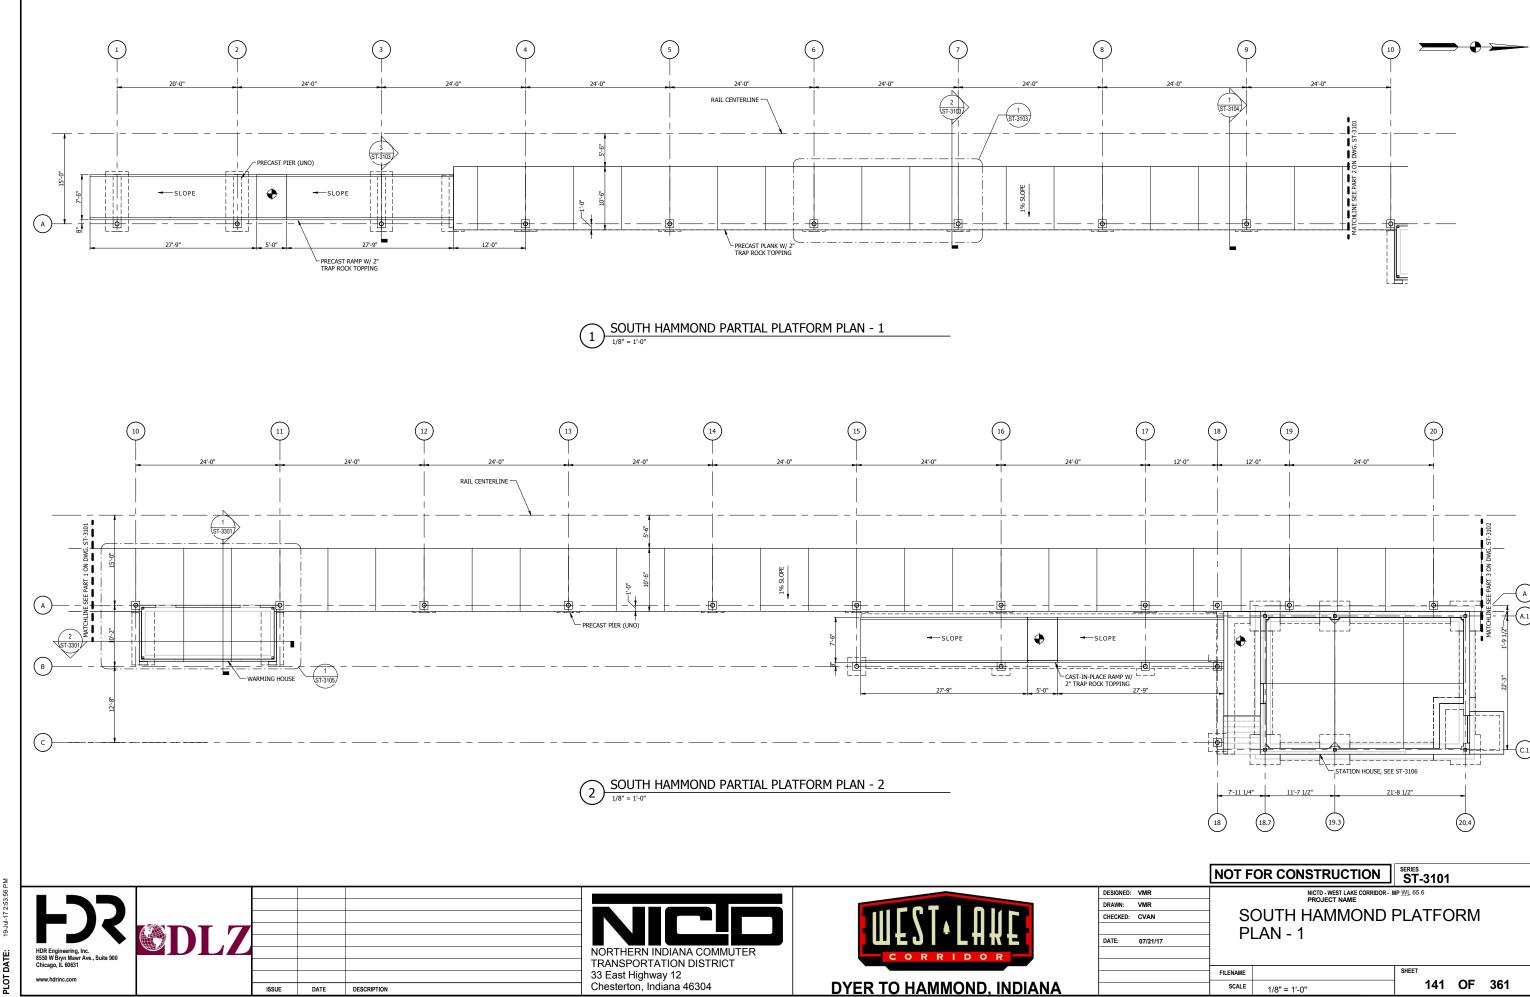




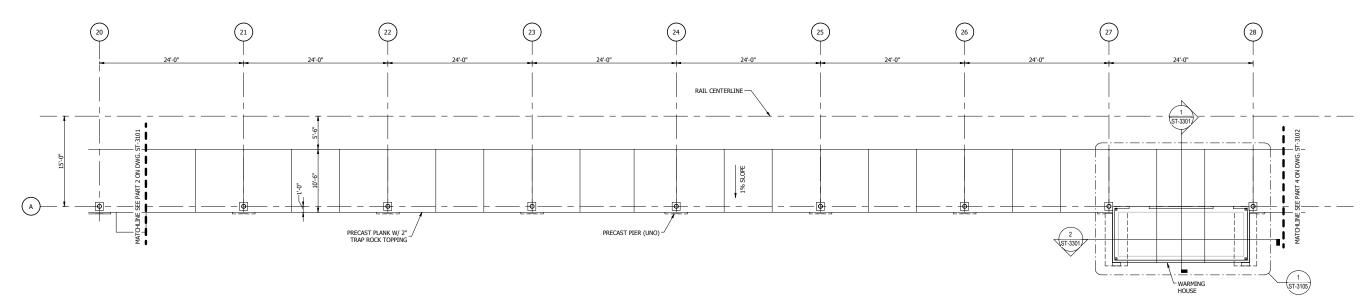

SOUTH HAMMOND PARTIAL PLATFORM PLAN - 3

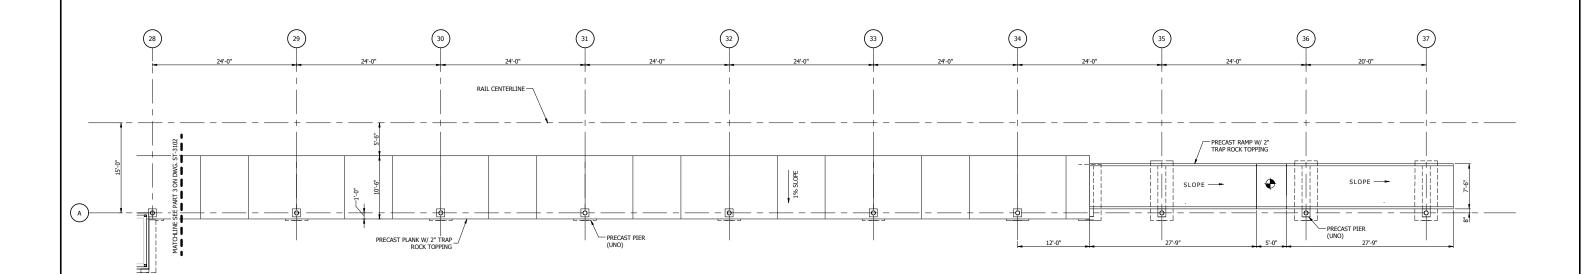


2 SOUTH HAMMOND PARTIAL PLATFORM PLAN - 4

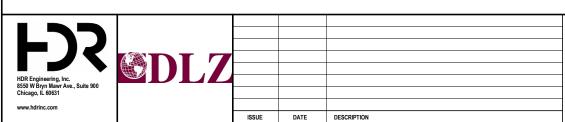






		NOT F	OR CONSTRUCTION	ST-3102			
	DESIGNED: VMR		NICTD - WEST LAKE CORRIDOR - I	MP <u>WL</u> 65.6			
	DRAWN: VMR	l _	***************************************				
	CHECKED: CVAN] S	SOUTH HAMMOND PLATFORM				
		PLAN - 2					
F	DATE: 07/21/17						
F							
F		FILENAME		SHEET			
F		SCALE	1/8" - 1' 0"	142	OF	361	

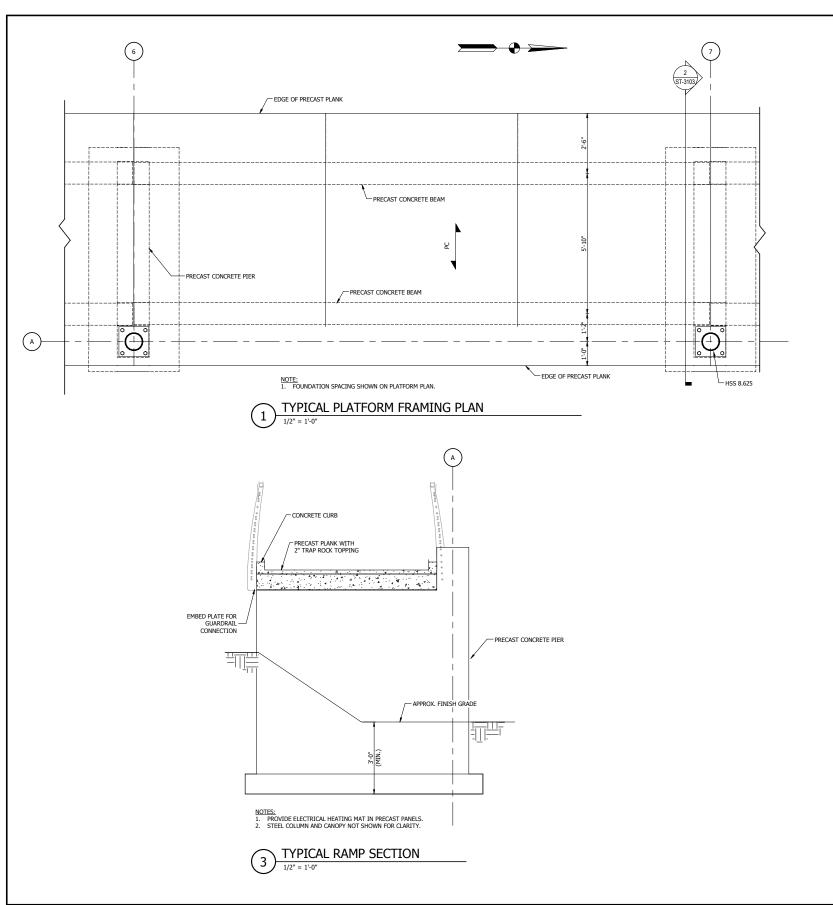

ISSUE DATE DESCRIPTION

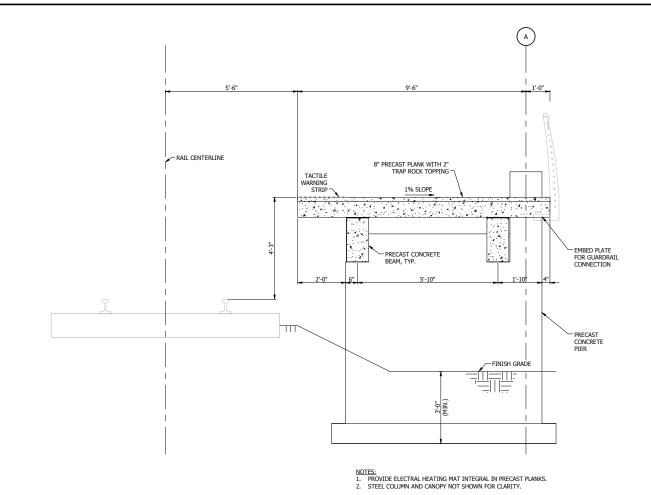

2 TYPICAL PLATFORM SECTION
1/2" = 1'-0"

DESIGNED: VMR DRAWN: VMR

DATE:

NOT FOR CONSTRUCTION SFRIES ST-3103

143 OF 361

SOUTH HAMMOND PLATFORM

CHECKED: CVAN FRAMING PLAN


1/2" = 1'-0"


SCALE


DYER TO HAMMOND, INDIANA

TRANSPORTATION DISTRICT 33 East Highway 12 Chesterton, Indiana 46304



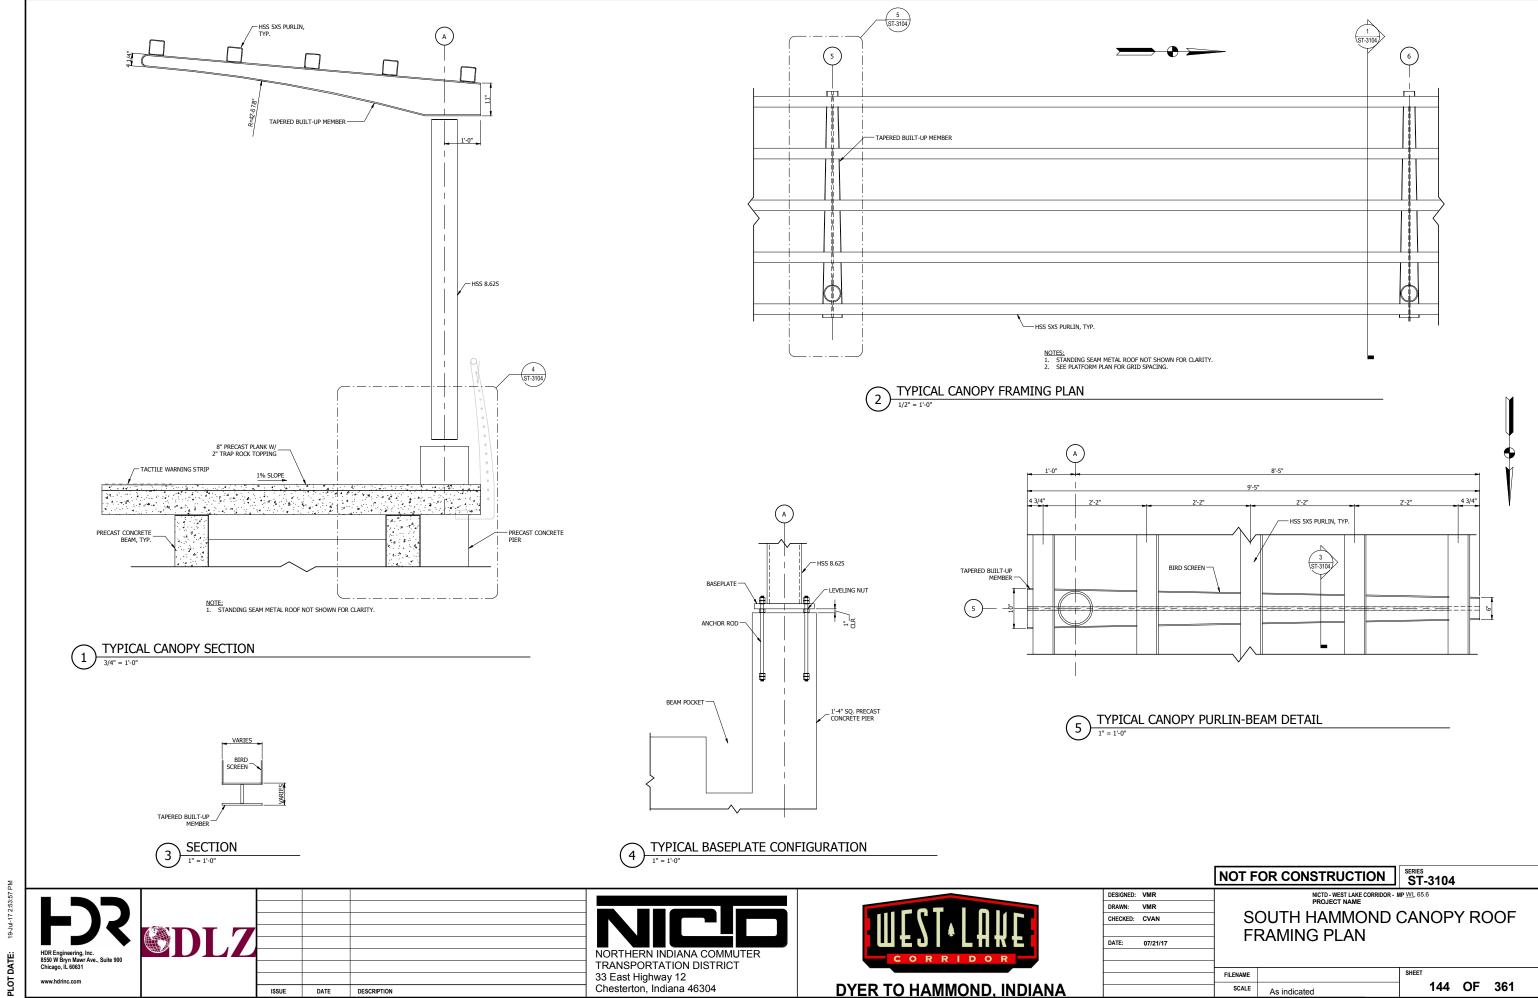

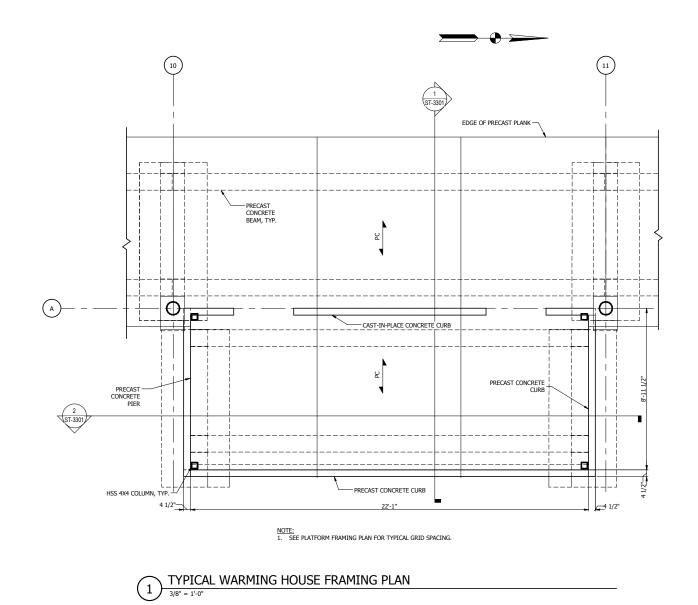

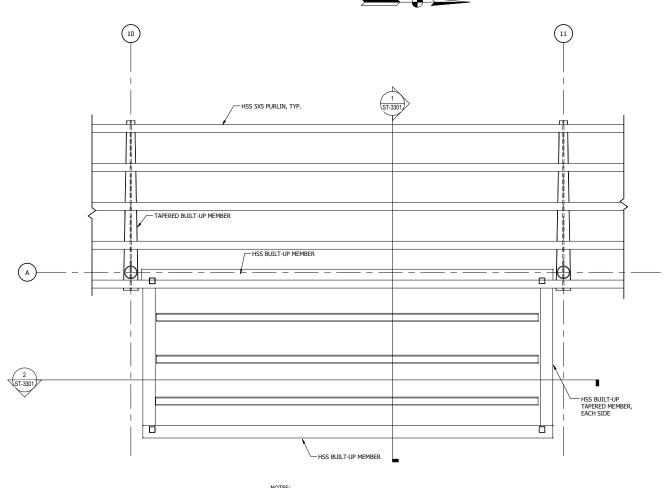


NOTES:

1. STANDING SEAM METAL ROOF NOT SHOWN FOR CLARITY.

2. SEE PLATFORM FRAMING PLAN FOR TYPICAL GRID SPACING.


TYPICAL WARMING HOUSE ROOF FRAMING PLAN
3/8" = 1'-0"

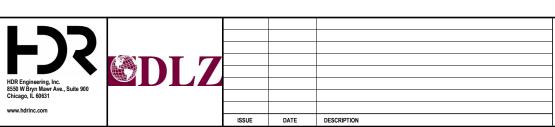


NORTHERN INDIANA COMMUTER TRANSPORTATION DISTRICT 33 East Highway 12 Chesterton, Indiana 46304



		NOT F	OR CONSTRUCTION	ST-3	105			
DESIGNED:	VMR		NICTD - WEST LAKE CORRIDOR - I	MP <u>WL</u> 65.6				
DRAWN:	VMR							
CHECKED:	CVAN	S	OUTH HAMMOND \	WAR	MIN	١G		
		ш.	OUSE PLAN					
DATE:	07/21/17		OUSE PLAIN					
		FILENAME		SHEET				
		SCALE	2/01 - 41 01	1 1	45	OF	361	

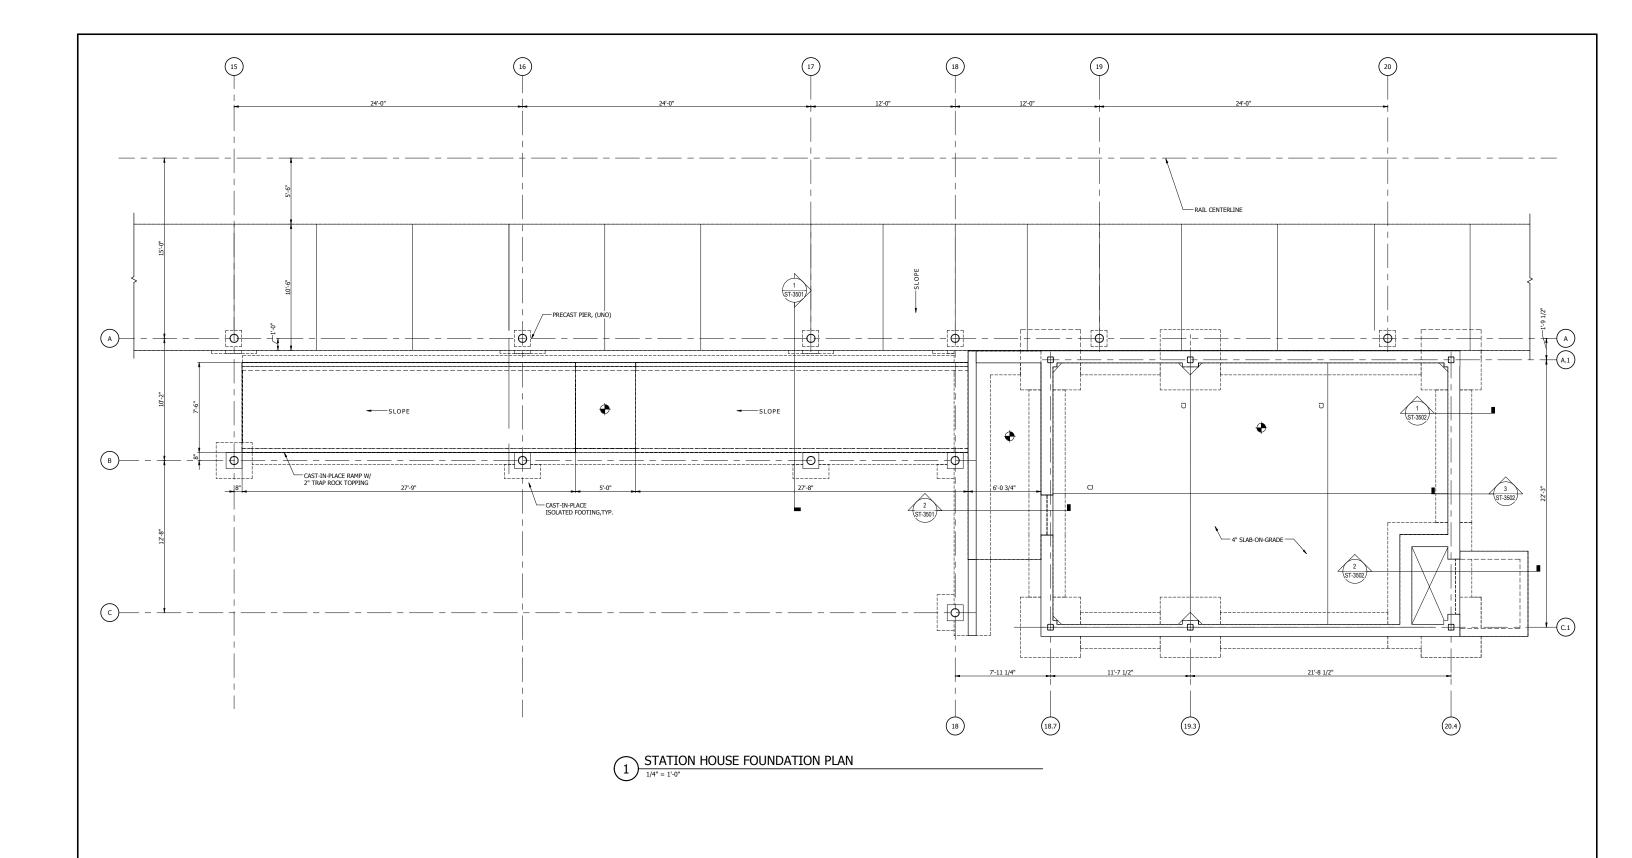

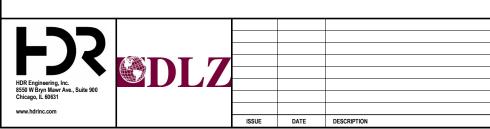


NORTHERN INDIANA COMMUTER TRANSPORTATION DISTRICT 33 East Highway 12 Chesterton, Indiana 46304



		NOT F	OR CONSTRUCTION	ST-	3106				
ESIGNED:	VMR		NICTD - WEST LAKE CORRIDOR -	MP WL 65.	3				
RAWN:	VMR	_							
HECKED:	CVAN	S	SOUTH HAMMOND STATION						
		HOUSE FOUNDATION PLAN							
ATE:	07/21/17	1 1	HOUSE I CONDATION FLAIN						
			_						
		FILENAME		SHEET					
		SCALE	1/4" = 1'-0"		146	OF	361		

SCALE 1/4" = 1'-0"

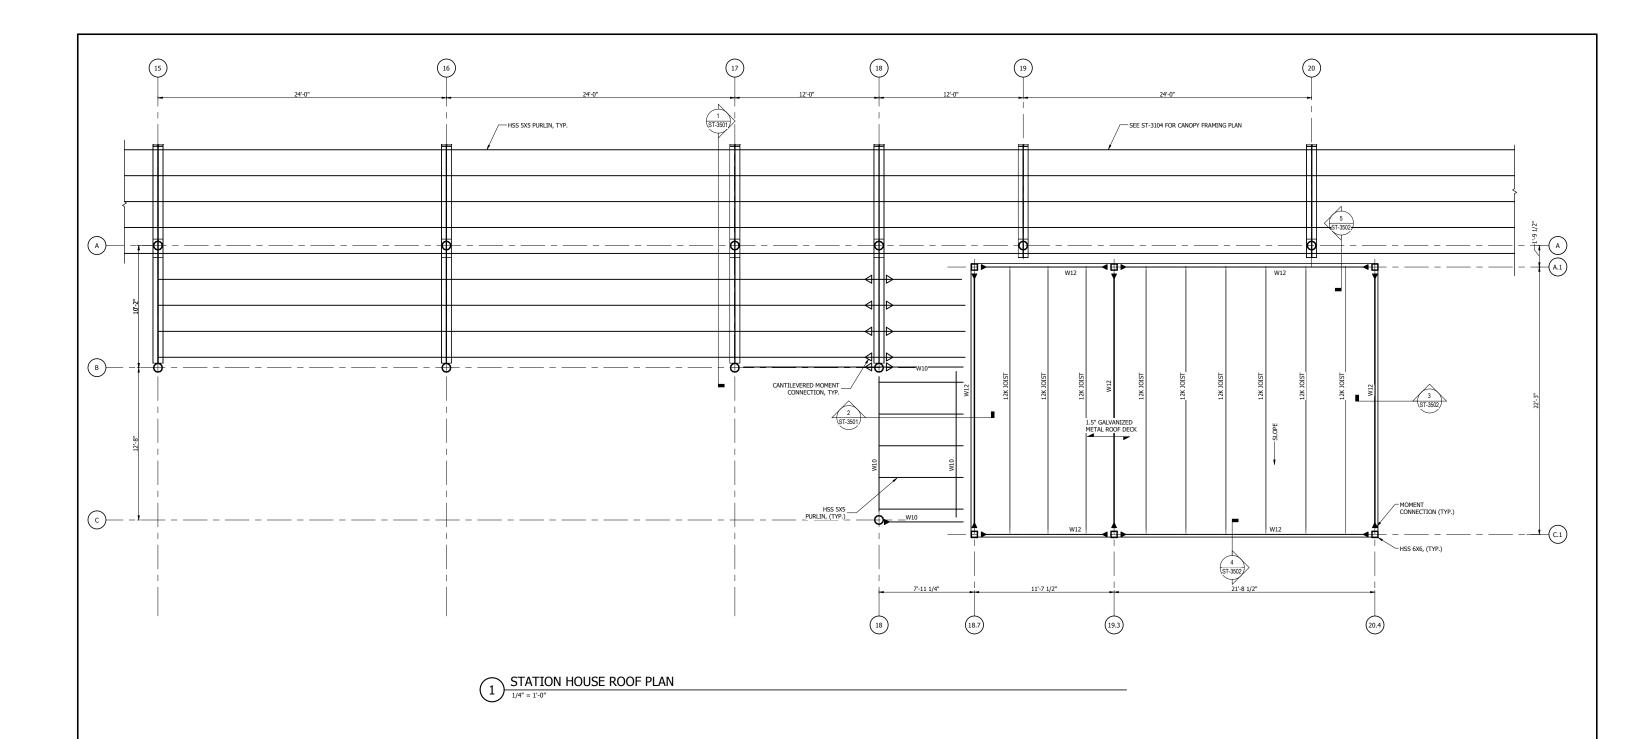


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8550 W Bryn Mawr Ave., Suite 900
Chicago, IL 60631

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NORTHERN INDIANA COMMUTER TRANSPORTATION DISTRICT 33 East Highway 12 Chesterton, Indiana 46304



		NOT F	OR CONSTRUCTION	ST-310	7			
DESIGNED:	VMR		NICTD - WEST LAKE CORRIDOR - M	P WL 65.6			_	
DRAWN:	VMR							
CHECKED:	CVAN	SOUTH HAMMOND STATION						
		HOUSE ROOF FRAMING PLAN						
DATE: 07/21/17		HOUSE ROOF FRAMING PLAN						
		FILENAME		SHEET				
		SCALE	1/4" - 1' 0"	147	OF	361		

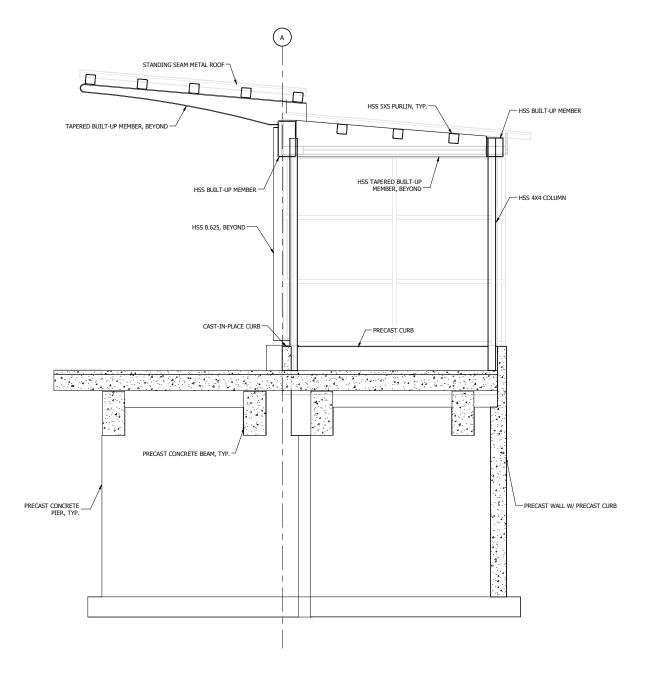


STANDING SEAM METAL ROOF HSS TAPERED BUILT-UP MEMBER HSS 5X5 PURLIN PRECAST CURB -8" PRECAST PLANKS 2" TRAP ROCK TOPPING PRECAST CONCRETE PIER pa 44 4.4 4.4 PRECAST WALL, BEYOND

TYPICAL WARMING HOUSE SECTION


1/2" = 1'-0"

2 TYPICAL WARMING HOUSE SECTION
1/2" = 1'-0"

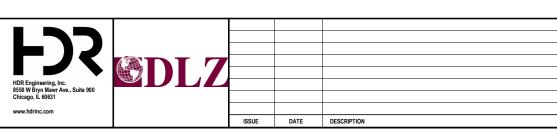



	NOT F	OR CONSTRUCTION	SERIES ST-3	301			
DESIGNED: VMR DRAWN: VMR CHECKED: CVAN DATE: 07/21/17		NICTO-WEST LAKE CORRIDOR - I PROJECT NAME OUTH HAMMOND V OUSE SECTIONS		RMIN	ΝG		
	FILENAME		SHEET				
	SCALE	1/2" = 1'-0"	1	148	OF	361	

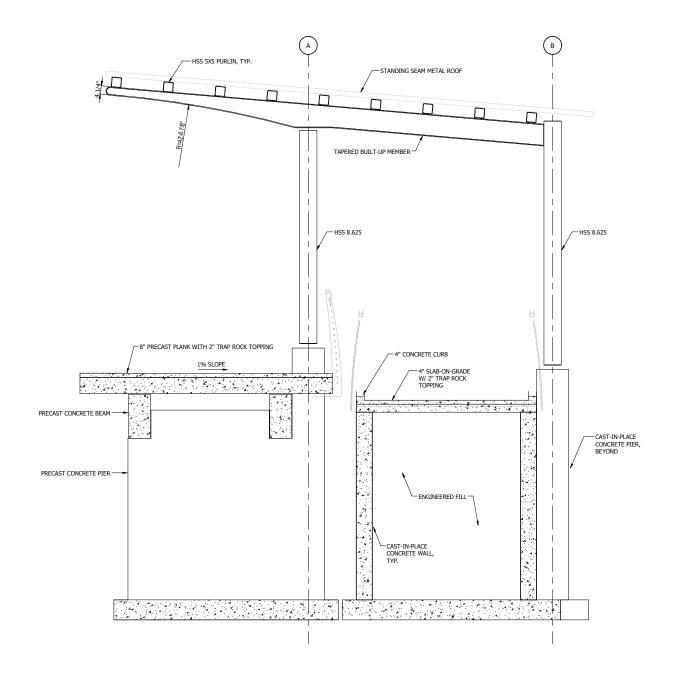


_ 1 1/2" METAL ROOF DECK W10 BEAM, TYP. - 4" SLAB-ON-GRADE W/ 2" TRAP ROCK TOPPING SLAB-ON-GRADE FINISH GRADE -

BUILDING ENTRANCE RAMP SECTION


BUILDING ENTRANCE LANDING SECTION


1/2" = 1'-0"

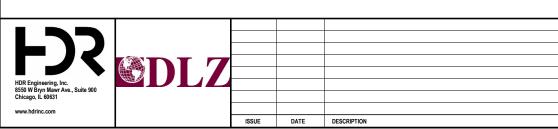



	NOT F	OR CONSTRUCTION	ST-3501					
DESIGNED: VMR		NICTD - WEST LAKE CORRIDOR -	MP <u>WL</u> 65.6					
DRAWN: VMR								
CHECKED: CVAN	S	OUTH HAMMOND	PLAIFC)RM				
	D	AMP DETAILS						
DATE: 07/21/17	'\	AIVIF DETAILS						
	1							
		I	T					
	FILENAME		SHEET					
	SCALE	1/2" = 1'-0"	149	OF	361			

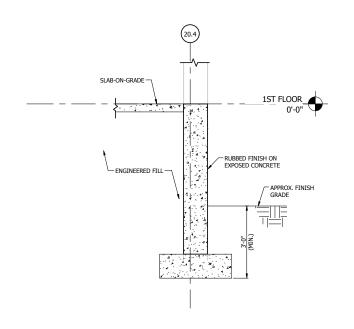

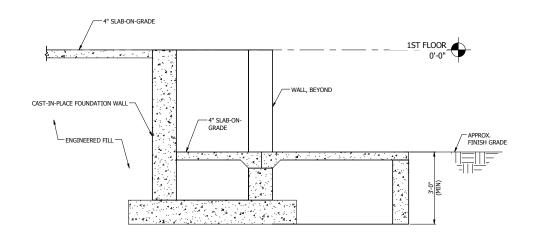



TYPICAL FOUNDATION DETAIL


1/2" = 1'-0"

2 IT CLOSET STOOP

1/2" = 1'-0"

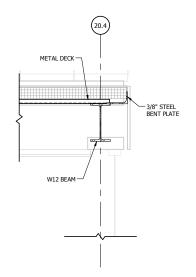

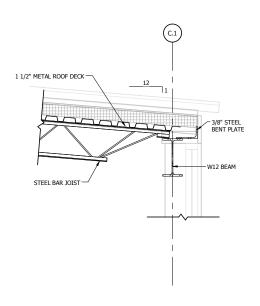

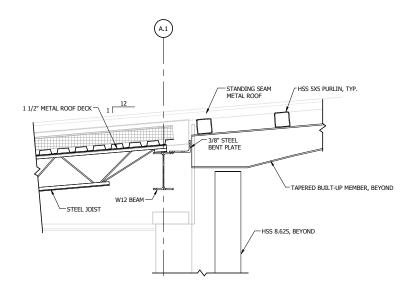


3 TYPICAL DECK BEARING ROOF DETAIL

TYPICAL JOIST BEARING DETAIL

3/4" = 1'-0"


JOIST BEARING AT WEST

3/4" = 1'-0"

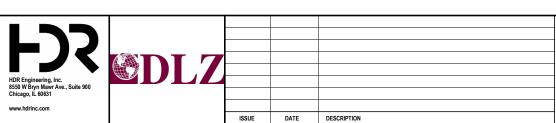



	NOT F	OR CONSTRUCTION	SERIES ST-3	3502			
DESIGNED: VMR		NICTD - WEST LAKE CORRIDOR - I	MP <u>WL</u> 65.6				
DRAWN: VMR		******					
CHECKED: CVAN] S	SOUTH HAMMOND STATION					
		OUSE DETAILS					
DATE: 07/21/17		OUSE DETAILS					
	FILENAME		SHEET				
	SCALE	As indicated	1 '	150	OF	361	

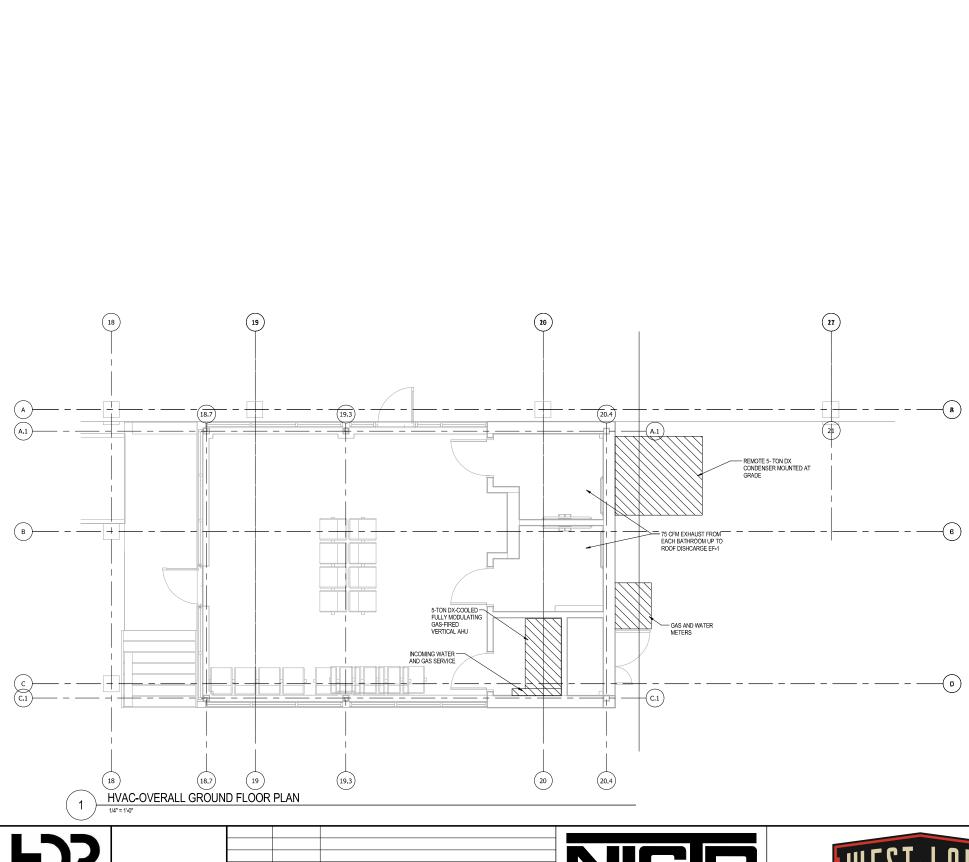

DYER TO HAMMOND, INDIANA

DRAWN: ZEA CHECKED: ESA DATE: 07/21/2017 PLAN

SOUTH HAMMOND HVAC-OVERALL GROUND FLOOR


NOT FOR CONSTRUCTION

SERIES M-3101

151 **OF** 361 SCALE 1/4" = 1'-0"

TRANSPORTATION DISTRICT 33 East Highway 12 Chesterton, Indiana 46304

DATE DESCRIPTION

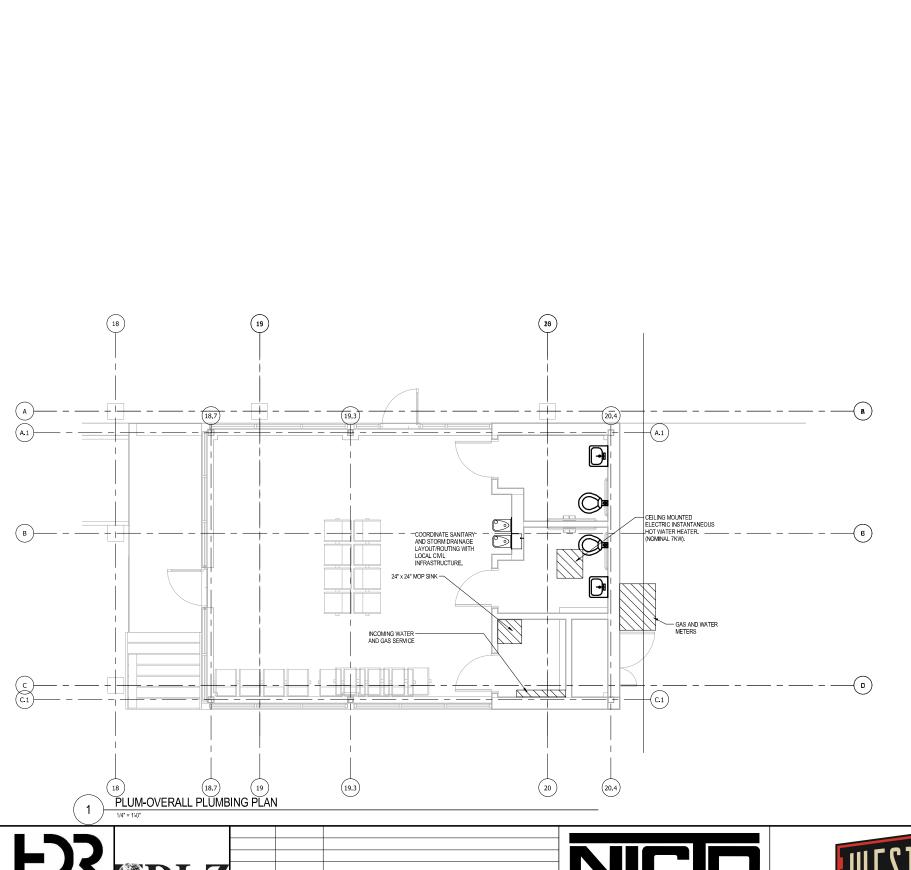

NOT FOR CONSTRUCTION

SERIES MP-3101

152 **OF** 361

SOUTH HAMMOND PLUMBING-OVERALL GROUND FLOOR PLAN

FILENAME

DATE: 07/21/2017 SCALE 1/4" = 1'-0"


DRAWN: ZEA

CHECKED: ESA


DATE DESCRIPTION

NORTHERN INDIANA COMMUTER TRANSPORTATION DISTRICT 33 East Highway 12 Chesterton, Indiana 46304

DYER TO HAMMOND, INDIANA

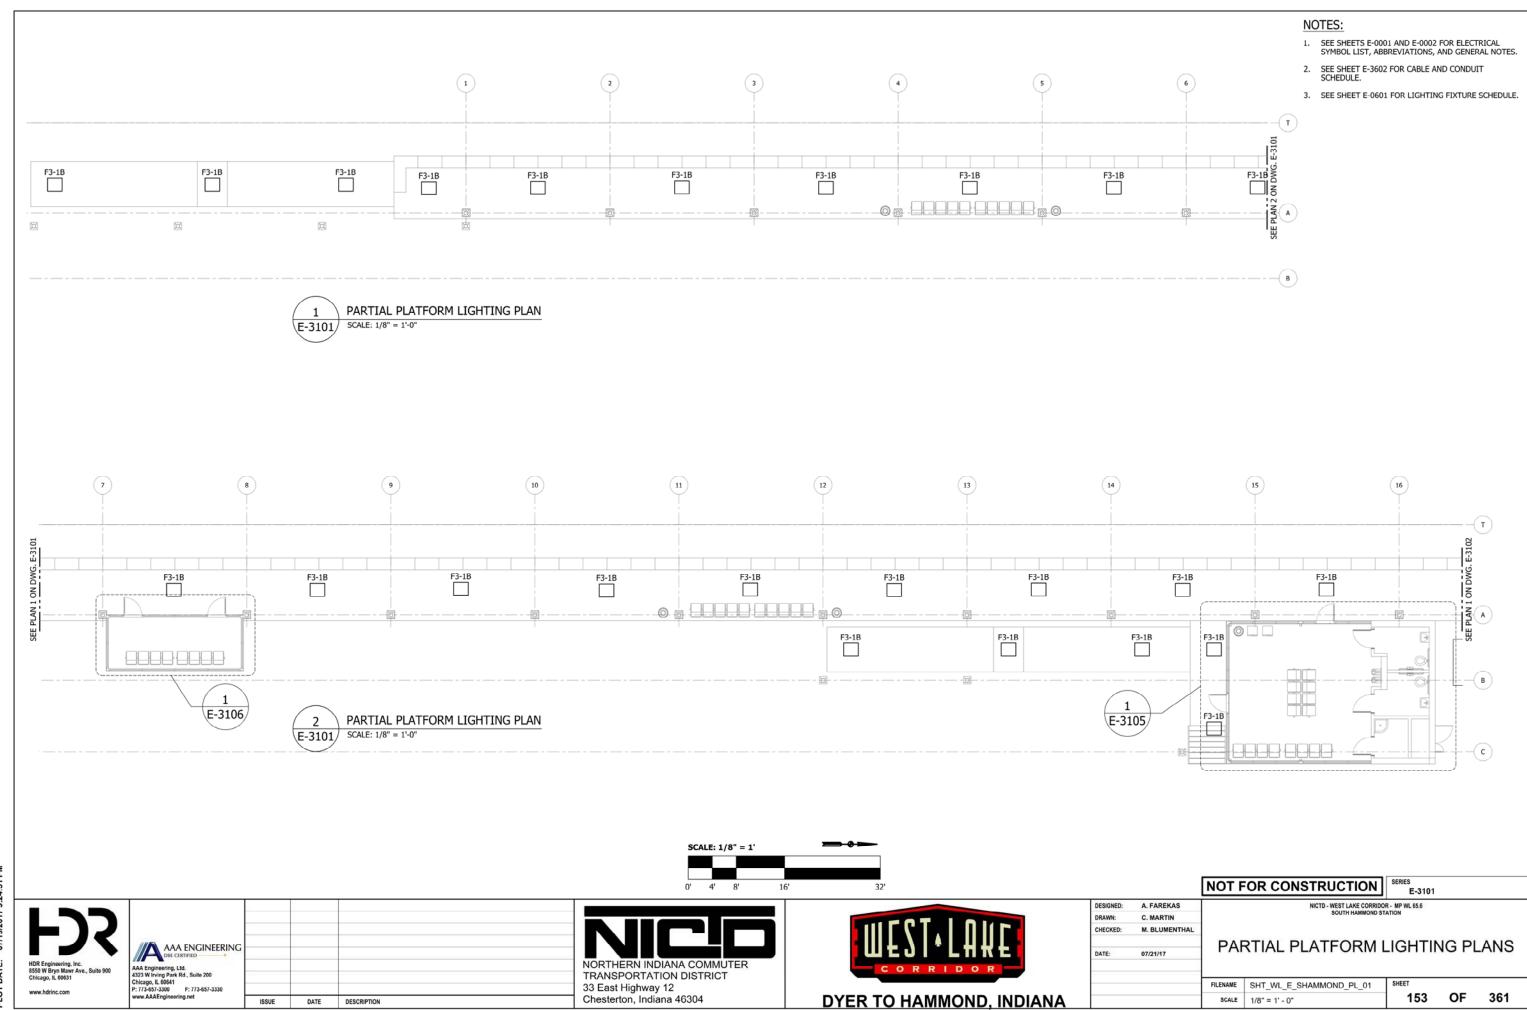

OT DATE: 07/19/2017 9

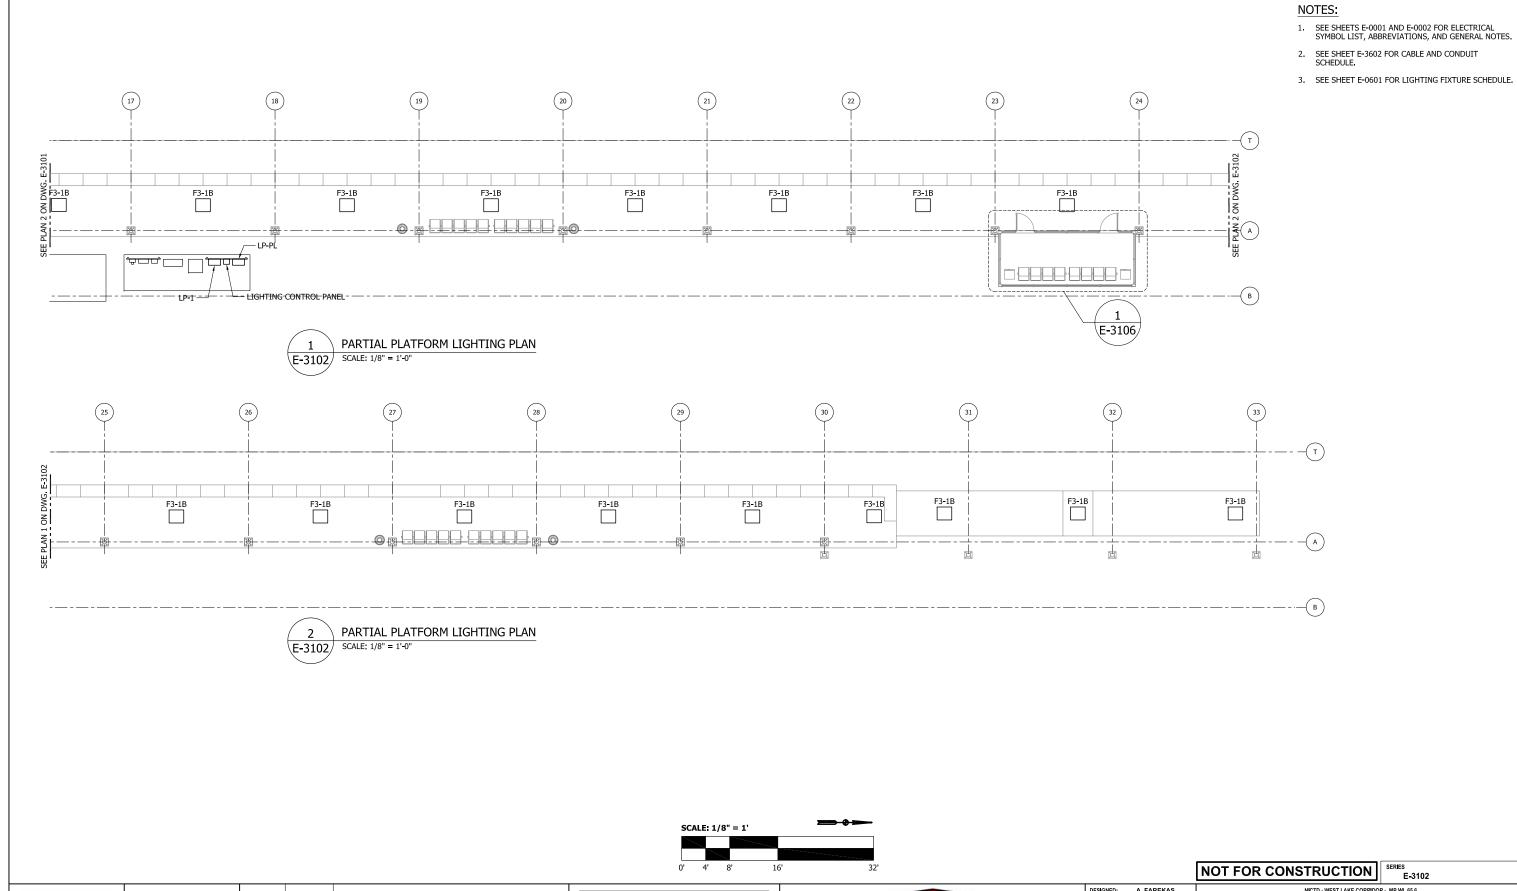

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NORTHERN INDIANA COMMUTER TRANSPORTATION DISTRICT 33 East Highway 12 Chesterton, Indiana 46304



DESIGNED:	A. FAREKAS	
DRAWN:	C. MARTIN	1
CHECKED:	M. BLUMENTHAL	1
] _D /
DATE:	07/21/17]


NICTD - WEST LAKE CORRIDOR - MP WL 65.6 SOUTH HAMMOND STATION

PARTIAL PLATFORM LIGHTING PLANS


FILENAME SHT_WL_E_SHAMMOND_PL_02 SCALE 1/8" = 1' - 0"

154 OF 361

DATE DESCRIPTION

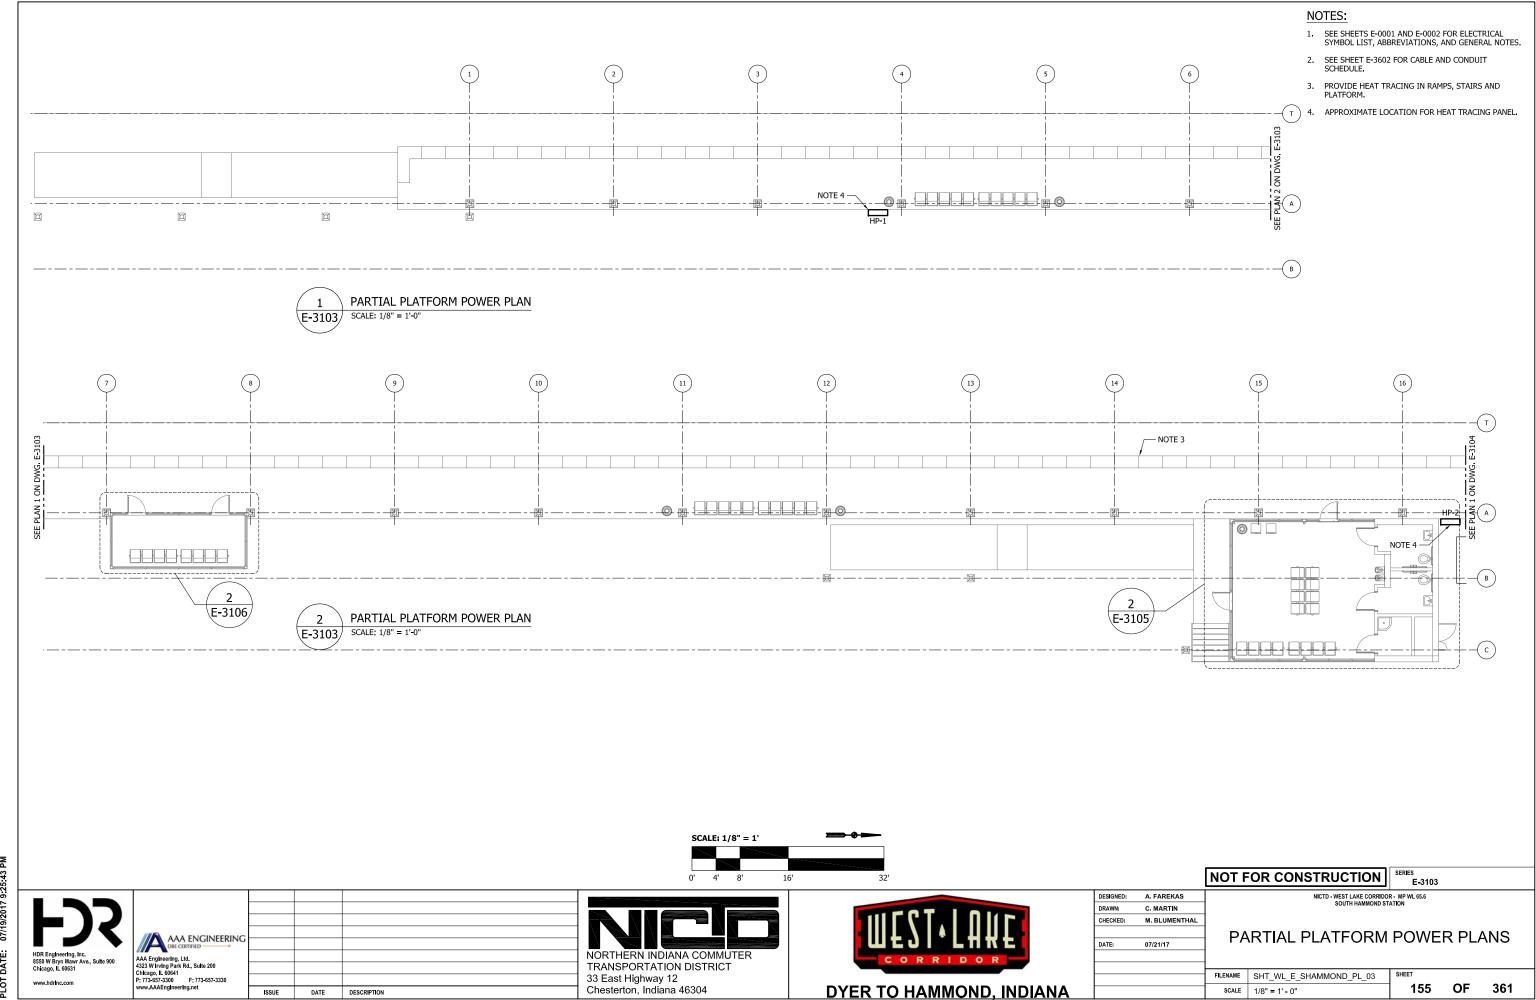



M:5050 NICTD WEST LAKE PROJECT/04 - CADD FILES/04 - SHEET FILES/SOUTH HAMMOND STATION/SHT_WL_E_SHAMMOND_PL_03.DWG

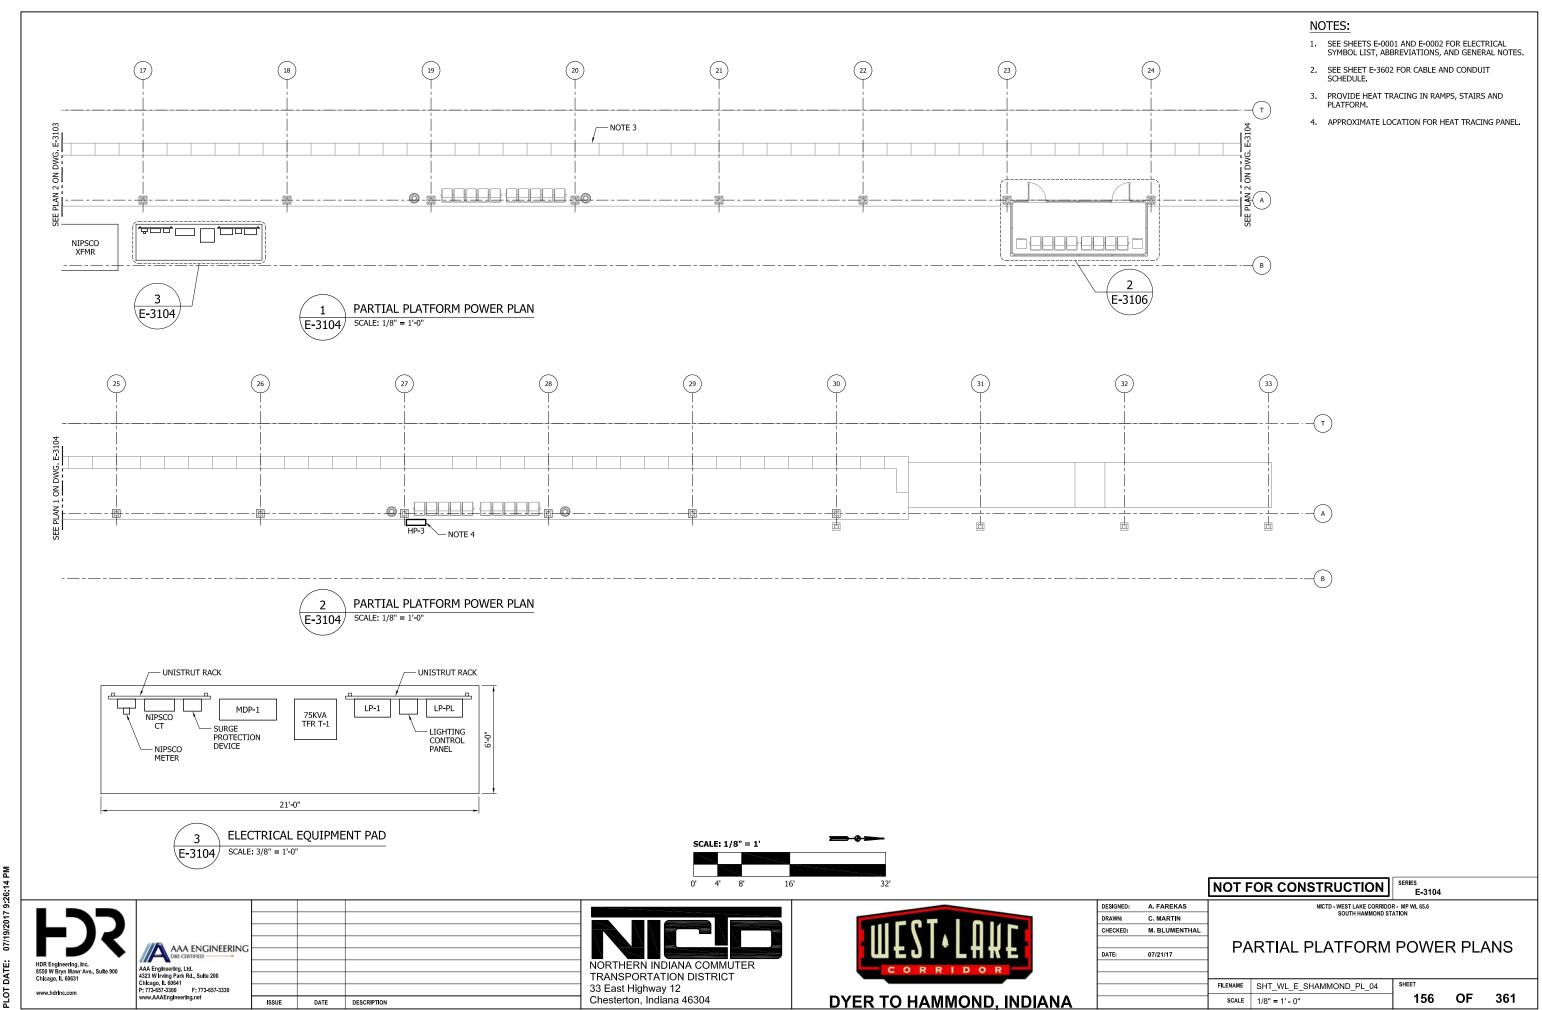

M:15050 NICTD WEST LAKE PROJECT/04 - CADD FILES/04 - SHEET FILES/SOUTH HAMMOND STATION/SHT_WL_E_SHAMMOND_PL_04.DWG


- SEE SHEETS E-0001 AND E-0002 FOR ELECTRICAL SYMBOL LIST, ABBREVIATIONS, AND GENERAL NOTES.
- 2. SEE SHEET E-3602 FOR CABLE AND CONDUIT SCHEDULE.
- 3. SEE SHEET E-0601 FOR LIGHTING FIXTURE SCHEDULE.
- 4. CEILING MOUNTED MOTION SENSOR.

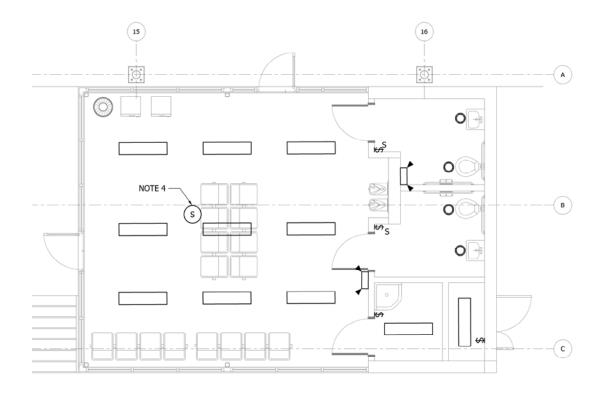

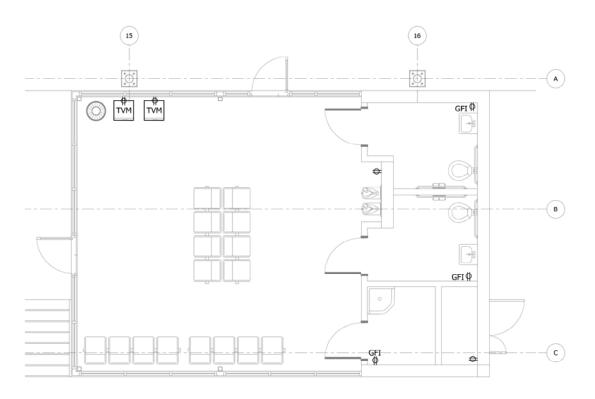





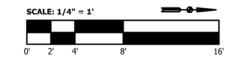



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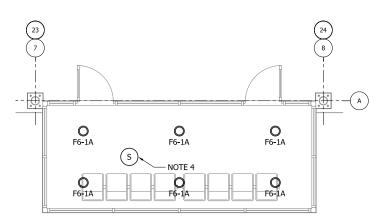


		NOT FOR CONSTRUCTION	SERIES E-3105				
DESIGNED:	A. FAREKAS	NICTD - WEST LAKE CORRIDO					
DRAWN:	C. MARTIN	SOUTH HAMMOND STATION					
CHECKED:	M. BLUMENTHAL						
		STATION BUILD	ING DI				
DATE:	07/21/17	STATION BOILD	INGFLA				


STATION BUILDING PLANS

FILENAME SHT_WL_E_SHAMMOND_PL_05 157 OF 361 SCALE 1/4" = 1' - 0"

- SEE SHEETS E-0001 AND E-0002 FOR ELECTRICAL SYMBOL LIST, ABBREVIATIONS, AND GENERAL NOTES.
- 2. SEE SHEET E-3602 FOR CABLE AND CONDUIT SCHEDULE.
- 3. SEE SHEET E-0601 FOR LIGHTING FIXTURE SCHEDULE.
- 4. CEILING MOUNTED MOTION SENSOR.
- 5. INFRARED HEATERS.
- 6. SIZE DISCONNECT SWITCHES FOR INFRARED HEATER SIZE.





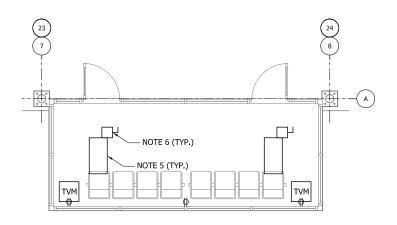

TYPICAL WARMING HUT POWER PLAN E-3106 SCALE: 1/4" = 1'-0"



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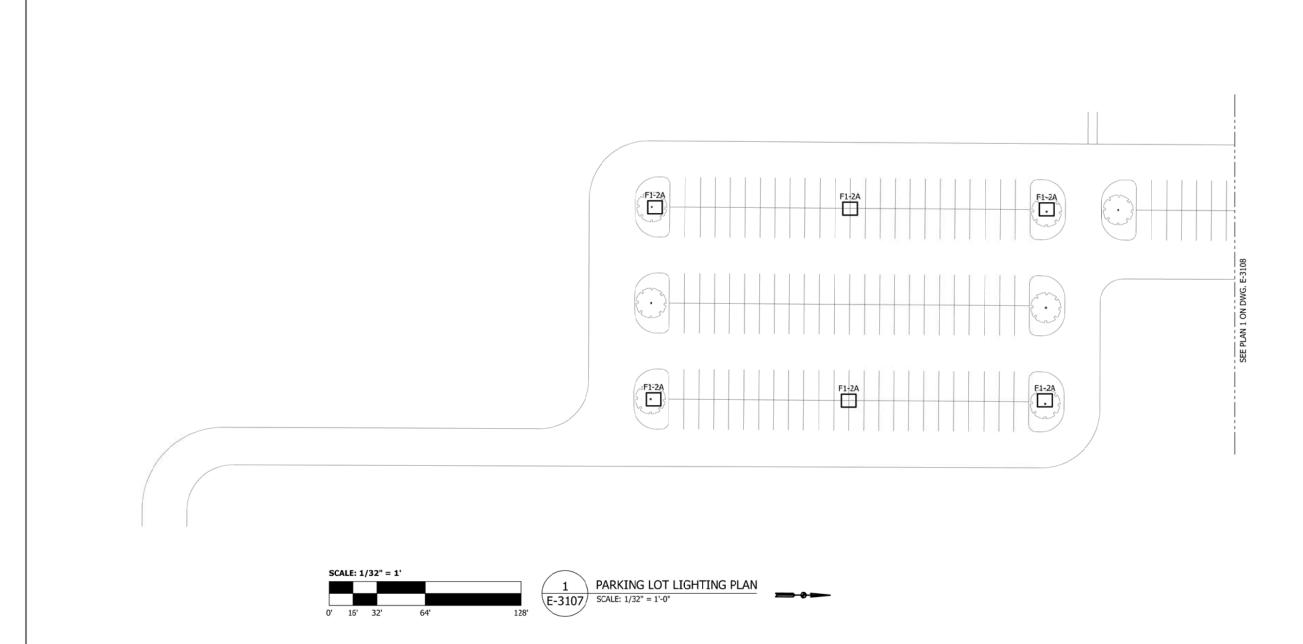
		NOT F	OR CONSTRUCTION	SERIES E-3106
DESIGNED:	A. FAREKAS		NICTD - WEST LAKE CORRID	
DRAWN:	C. MARTIN		SOUTH HAMMOND S	TATION
CHECKED:	M. BLUMENTHAL			
			TYPICAL WARMIN	CHIT
DATE:	07/21/17		I II ICAL WAINWIIN	011011

TYPICAL WARMING HUT PLANS

FILENAME SHT_WL_E_SHAMMOND_PL_06 SCALE 1/4" = 1' - 0"

158 OF 361

M:5050 NICTD WEST LAKE PROJECT/04 - CADD FILES/04 - SHEET FILES/SOUTH HAMMOND STATION/SHT_WL_E_SHAMMOND_PL_06.DWG



- SEE SHEETS E-0001 AND E-0002 FOR ELECTRICAL SYMBOL LIST, ABBREVIATIONS, AND GENERAL NOTES.
- 2. SEE SHEET E-3602 FOR CABLE AND CONDUIT SCHEDULE.
- 3. SEE SHEET E-0601 FOR LIGHT FIXTURE SCHEDULE.



KEY PLAN


AAA ENGINEERING HDR Engineering, Inc. 8550 W Bryn Mawr Ave., Suite 900 Chicago, IL 60631 AAA Engineering, Ltd. 4323 W Irving Park Rd., Suite 200 Chicago, IL 60641 P: 773-657-3300 F: 773-657-3330 www.AAAEngineering.net 33 East Highway 12 Chesterton, Indiana 46304 ISSUE DATE DESCRIPTION





		NOT F	OR CONSTRUCTION	SERIES E-3107		
DESIGNED:	A. FAREKAS		NICTD - WEST LAKE CORRIDO			
DRAWN:	C. MARTIN		SOUTH HAMMOND ST	ATION		
CHECKED:	M. BLUMENTHAL					
			PARKING LOT LIG	HTING	DI AN	d
DATE:	07/21/17		PARKING LOT LIG	IIIIIII		V
		FILENAME	SHT WL E SHAMMOND PL 07	SHEET		_
		SCALE	1/32" = 1' - 0"	159	OF	3

159 OF 361

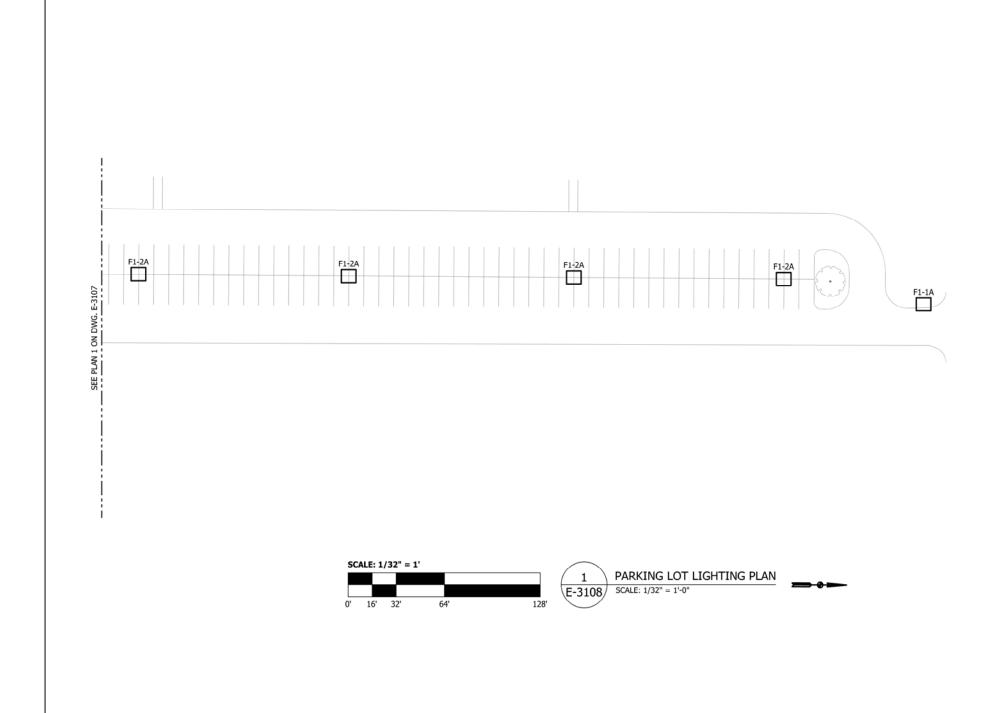

- SEE SHEETS E-0001 AND E-0002 FOR ELECTRICAL SYMBOL LIST, ABBREVIATIONS, AND GENERAL NOTES.
- 2. SEE SHEET E-3602 FOR CABLE AND CONDUIT SCHEDULE.
- 3. SEE SHEET E-0601 FOR LIGHT FIXTURE SCHEDULE.



KEY PLAN



AAA ENGINEERING AAA Engineering, Ltd. 4323 W Irving Park Rd., Suite 200 Chicago, IL 60641 P: 773-657-3300 F: 773-657-3330 www.AAAEngineering.net ISSUE DATE DESCRIPTION


NORTHERN INDIANA COMMUTER TRANSPORTATION DISTRICT 33 East Highway 12 Chesterton, Indiana 46304



		NOT F	OR CONSTRUCTION	SERIES E-3108				
DESIGNED:	A. FAREKAS		NICTD - WEST LAKE CORRIDO					
DRAWN:	C. MARTIN		SOUTH HAMMOND ST					
CHECKED:	M. BLUMENTHAL							
			PARKING LOT LIG					
DATE:	07/21/17		PARKING LOT LIGI	THING				
		FILENAME	SHT WL E SHAMMOND PL 08	SHEET				

PARKING LOT LIGHTING PLANS

LENAME SHT_WL_E_SHAMMOND_PL_08 160 OF 361 SCALE 1/32" = 1' - 0"

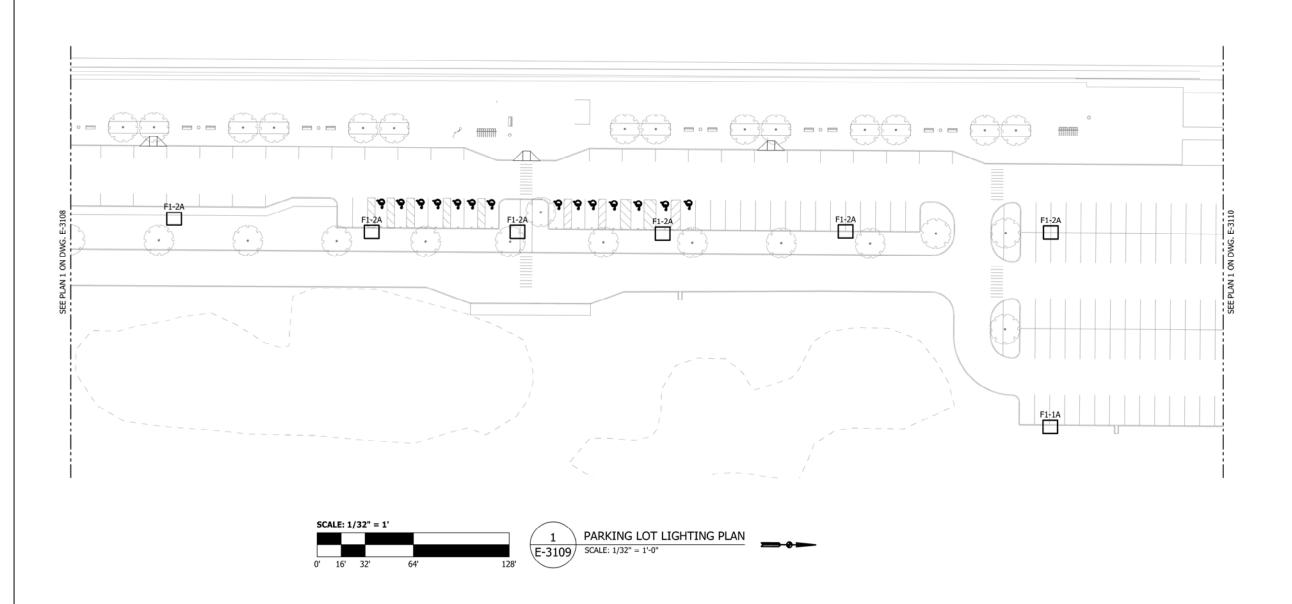

- SEE SHEETS E-0001 AND E-0002 FOR ELECTRICAL SYMBOL LIST, ABBREVIATIONS, AND GENERAL NOTES.
- 2. SEE SHEET E-3602 FOR CABLE AND CONDUIT SCHEDULE.
- 3. SEE SHEET E-0601 FOR LIGHT FIXTURE SCHEDULE.





NORTHERN INDIANA COMMUTER TRANSPORTATION DISTRICT 33 East Highway 12 Chesterton, Indiana 46304



		NOT F	OR CON	STRUCT	ION	SERIES E-3109
DESIGNED:	A. FAREKAS			NICTO - WEST LA		
DRAWN:	C. MARTIN	SOUTH HAMMOND STATION				
CHECKED:	M. BLUMENTHAL					
			PARKIN	GLOT	LICI	ATING I
DATE:	07/21/17		LAMM	G LO	LIGI	THING

PARKING LOT LIGHTING PLANS


FILENAME SHT_WL_E_SHAMMOND_PL_09 161 OF 361

SCALE 1/32" = 1' - 0"

ISSUE DATE DESCRIPTION M:5050 NICTD WEST LAKE PROJECT/04 - CADD FILES/04 - SHEET FILES/SOUTH HAMMOND STATION/SHT_WL_E_SHAMMOND_PL_09.DWG

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Chicago, IL 60641
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KEY PLAN



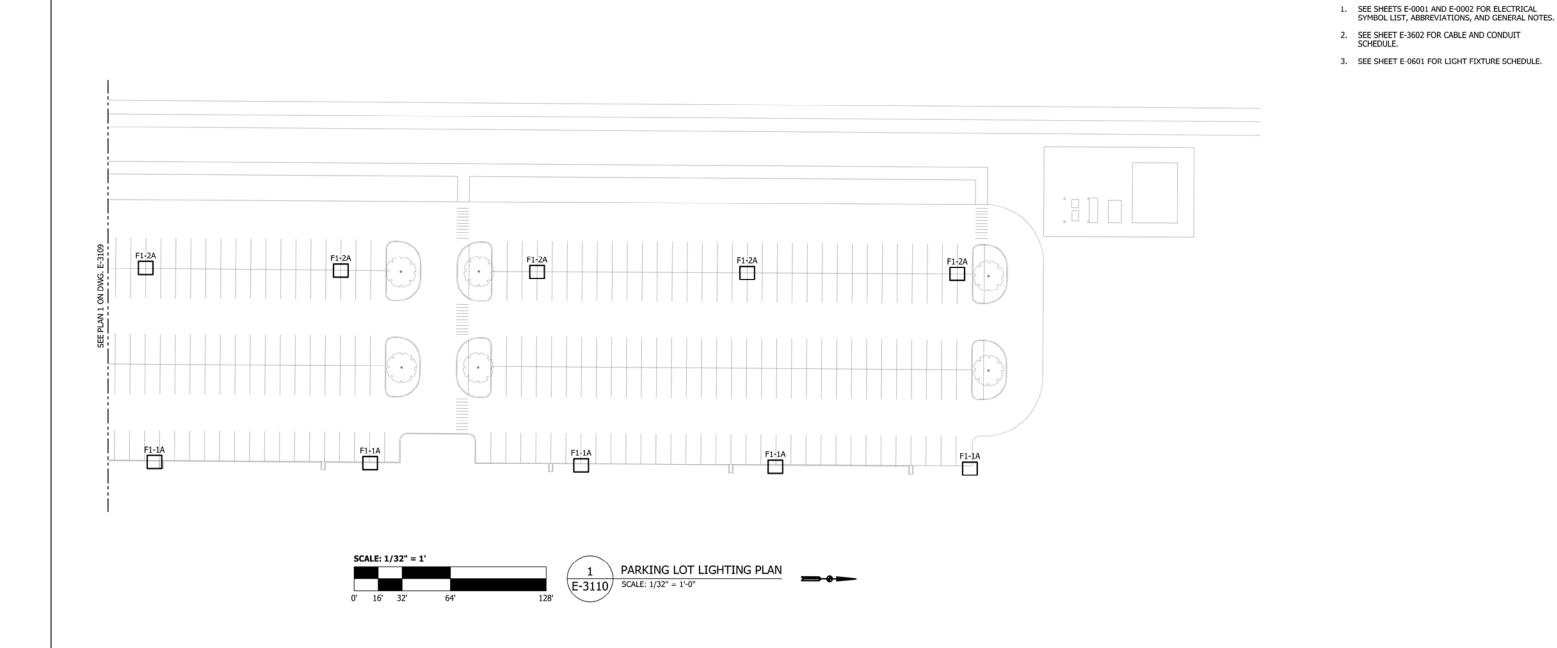

NORTHERN INDIANA COMMUTER TRANSPORTATION DISTRICT 33 East Highway 12 Chesterton, Indiana 46304




		NOT F	OR CONSTRUCTION	SERIES E-3110			
DESIGNED:	A. FAREKAS		NICTD - WEST LAKE CORRIDO				
DRAWN:	C. MARTIN	SOUTH HAMMOND STATION					
CHECKED:	M. BLUMENTHAL						
DATE:	07/21/17		PARKING LOT LIGI	HTING F			
		FILENAME	SHT WL E SHAMMOND PL 10	SHEET			

NOTES:

PARKING LOT LIGHTING PLANS

NAME SHT_WL_E_SHAMMOND_PL_10 162 OF 361 SCALE 1/32" = 1' - 0"

M:5050 NICTD WEST LAKE PROJECT/04 - CADD FILES/04 - SHEET FILES/SOUTH HAMMOND STATION/SHT_WL_E_SHAMMOND_PL_10.DWG

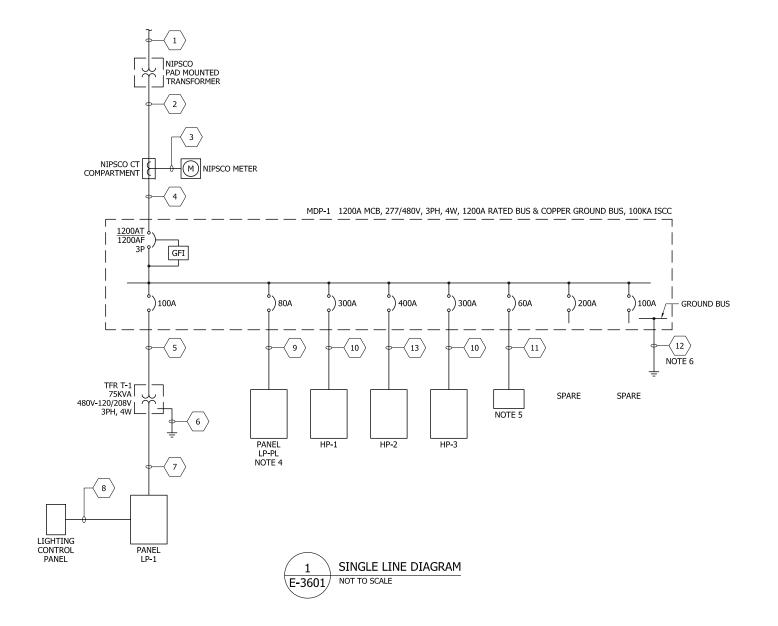

SEE SHEETS E-0001 AND E-0002 FOR ELECTRICAL SYMBOL LIST, ABBREVIATIONS, AND GENERAL NOTES.

2. ALL PANELBOARDS AND TRANSFORMERS IN STAINLESS STEEL ENCLOSURES, NEMA 3R, GASKETED WITH HEATERS. ALL PANELBOARDS AND TRANSFORMERS

4. REMOTE MOUNTED PARKING LOT LIGHT CONTROLLER. 5. SURGE PROTECTION DEVICE. 400KA PER PHASE. 6. GROUND CABLE GROUNDED TO TRIAD OF 3-10 FOOT LONG, 3/4" DIA. STAINLESS STEEL GROUNDING RODS. 7. MDP-1 SHALL BE SERVICE ENTRANCE RATED AND UL

ALL EQUIPMENT SHALL BE MOUNTED ON CONCRETE FOUNDATION/BASE, EXTENDING 6" PAST EQUIPMENT IN ALL DIRECTIONS AND 6" A.F.G.

ARE MOUNTED OUTSIDE. 3. ALL CIRCUIT BREAKERS ARE 3 POLE, UNO.

NOT FOR CONSTRUCTION E-3601

DESIGNED: A. FAREKAS C. MARTIN

M. BLUMENTHAL

07/21/17

DRAWN:

DATE:

361

SINGLE LINE DIAGRAM

FILENAME SHT_WL_E_SHAMMOND_GN_01 SCALE NONE

163 OF

AAA Engineering, Ltd. 4323 W Irving Park Rd., Suite 200 Chicago, IL 60641 P: 773-657-3300 F: 773-657-3330 ISSUE DATE DESCRIPTION

CABLE AND CONDUIT SCHEDULE							
LEGEND NUMBER	CABLE DESCRIPTION QUANTITY/SIZES	CONDUIT SIZE (INCHES)	NOTES				
1		(2) 4	2				
2	3 SETS 4 #600 KCMIL & 1 #250 KCMIL GRD	(3) 4	3				
3	10 #10 AWG	1	4				
4	3 SETS 4 #600 KCMIL & 1 #250 KCMIL GRD	(3) 4	4				
5	3 #2 AWG & 1 #8 AWG GRD	1½	4				
6	1 #2 AWG GRD	1	4, 5				
7	4 #4/0 AWG & 1 #2 AWG GRD	2½	4				
8	4 SETS 8 #8 AWG & 1 #10 AWG GRD	(4) 1½	4, 6				
9	4 #2 AWG & 1 #4 AWG GRD	2	3				
(10)	4 #500 KCMIL & 1 #3 AWG GRD	3½	4				
(11)	4 #6 AWG & 1 #8 AWG GRD	1	4				
12	1 #250 KCMIL GRD	2	4				
(13)	4 #600 KCMIL & 1 #2 AWG GRD	3½	4				
14							
(15)							

- SEE SHEETS E-0001 AND E-0002 FOR ELECTRICAL SYMBOL LIST, ABBREVIATIONS, AND GENERAL NOTES.
- 2-4" PVC SCHEDULE 40 CONDUITS TO NIPSCO POLE FOR PRIMARY TRANSFORMER FEEDER CABLE, CABLE FURNISHED AND INSTALLED BY NIPSCO.
- 3. CONDUIT, PVC SCHEDULE 40.
- 4. CONDUIT TO BE GRC.
- 5. GROUND CABLE GROUNDED TO 10 FOOT LONG, $3\!\!/\!_{\rm T}$ DIA. STAINLESS STEEL GROUNDING ROD.
- 6. 2 CONDUITS ARE FOR FUTURE.

NOT FOR CONSTRUCTION E-3602

ISSUE DATE DESCRIPTION

AAA Engineering, Ltd. 4323 W Irving Park Rd., Sulte 200 Chicago, IL 60641 P: 773-657-3300 F: 773-657-3330 www.AAAEngineering.net





		_
DESIGNED:	A. FAREKAS	
DRAWN:	C. MARTIN	
CHECKED:	M. BLUMENTHAL	
DATE:	07/21/17	
		<u> </u>

NICTD - WEST LAKE CORRIDOR - MP WL 65.6 SOUTH HAMMOND STATION

CABLE AND CONDUIT SCHEDULE

FILENAME SHT_WL_E_SHAMMOND_GN_02 SHEET SCALE NONE

164 OF 361

PANEL: LP-1 /OLTAGE: 120/208V, 3P, 4W ENCLOSURE: NEMA 3R									MAIN MOUNTING BUS	225A MC 250A WI	_	DUND BUS
	BREA	KERS		LOAD (VA)		1		LOAD (V.	A)	BREAK	(ERS	
CIRCUIT USE	TRIP	POLE	Α	В	С	CKT#	A	В	С	TRIP	POLE	CIRCUIT USE
PARE	20	1				1 2				20		SPARE
PARE	20	1				3 4				20		SPARE
PARE	20	1				5 6				20		SPARE
PARE	20	1				7 8				20		SPARE
PARE	20	1				9 10				20		SPARE
PARE	20	1				11 12				20		SPARE
PARE	20	1				13 14				20		SPARE
PARE	20	1				15 16				20		SPARE
PARE	20	1				17 18				20		SPARE
PARE	20	1				19 20				20		SPARE
PARE	20	1				21 22				20		SPARE
PARE	20	1				23 24				20		SPARE
PARE	20	1				25 26				20		SPARE
PARE	20	1				27 28				20		SPARE
SPARE	20	1				29 30		_		20		SPARE
PARE PARE	20	1				31 32				20		SPARE SPARE
SPARE	20 20	1				33 34 35 36				20		SPARE
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TOTALS		+ -	0	0	0		0	1 (0 0		- -	SFARE
HASE A		VA				-		· `	, , ,			
HASE B:		VA				1						
HASE C:		VA				1						
OTAL CONNECTED VA		VA				1						
MPS			CONNECT									

SEE SHEETS E-0001 AND E-0002 FOR ELECTRICAL SYMBOL LIST, ABBREVIATIONS, AND GENERAL NOTES.

NOT FOR CONSTRUCTION E-3603

DESIGNED: A. FAREKAS

DRAWN: CHECKED: C. MARTIN

07/21/17

M. BLUMENTHAL


NICTD - WEST LAKE CORRIDOR - MP WL 65.6 SOUTH HAMMOND STATION

PANELBOARD SCHEDULES

FILENAME SHT_WL_E_SHAMMOND_GN_03 SHEET 165 OF 361 SCALE NONE

AAA Engineering, Ltd. 4323 W Irving Park Rd., Sulte 200 Chicago, IL 60641 P: 773-657-3300 F: 773-657-3330 www.AAAEngineering.net ISSUE DATE DESCRIPTION



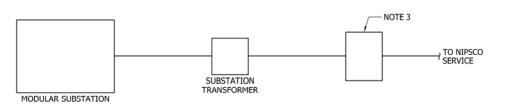

SUBSTATION SINGLE LINE DIAGRAM NOT TO SCALE E-3604/



PICTURE OF TYPICAL SWITCH E-3604 NOT TO SCALE

8550 W Bryn Mawr Ave., Suite 900 Chicago, IL 60631

AAA ENGINEERING AAA Engineering, Ltd. 4323 W Irving Park Rd., Suite 200 Chicago, IL 60641 P: 773-657-3300 F: 773-657-3330 www.AAAEngineering.net ISSUE DATE DESCRIPTION

NORTHERN INDIANA COMMUTER TRANSPORTATION DISTRICT 33 East Highway 12 Chesterton, Indiana 46304



		NOT F	OR CONSTRUCTION	SERIES E-3604			
DESIGNED:	A. FAREKAS		NICTD - WEST LAKE CORRIDO				
DRAWN:	C. MARTIN		SOUTH HAMMOND SUB	STATION			
CHECKED:	M. BLUMENTHAL		SOLITH HAN	MACNID			
		SOUTH HAMMOND					
DATE:	07/21/17		SUBSTATION	SERVIC			
			COBOTATION	02.			
		FILENAME	SHT WILE SHAMMOND ON OA	SHEET			

SOUTH HAMMOND SUBSTATION SERVICE

FILENAME SHT_WL_E_SHAMMOND_GN_04 SCALE NONE

NOTES:

SEE SHEETS E-0001 AND E-0002 FOR ELECTRICAL SYMBOL LIST, ABBREVIATIONS, AND GENERAL NOTES.

3. 69KV GROUND OPERATED VERTICAL BREAKER SWITCH.

PROVIDE FENCING AROUND SWITCH AND TRANSFORMER AND NIPSCO SWITCH AREA AHEAD OF SWITCH, COORDINATE EXACT AREA REQUIREMENTS WITH NIPSCO.

8. ALL DESIGNS MUST BE CERTIFIED BY STRUCTURAL

PROVIDE LIGHTS ON STRUCTURE UP/DOWN AND AREA WITH WEATHERPROOF LED FLOODLIGHTS.

2. SEE SHEET E-3602 FOR CABLE AND CONDUIT SCHEDULE.

 USE ALUMINUM WIRING FOR CONNECTION. 5. PROVIDE CONCRETE FOUNDATION FOR SWITCH.

7. PROVIDE TUBULAR I-BEAM SUPPORT STAND.

 NIPSCO BUS SUPPORT SHALL HAVE LIGHTNING PROTECTION. 11. SWITCH SHALL HAVE HAND OPERATED MANUAL AUXILIARY INLINE SWITCH.

12. STRUCTURE SHALL BE PROPERLY GROUNDED PER NIPSCO SPECIFICATIONS.


13. PROVIDE WEATHERPROOF OUTDOOR GFI SERVICE RECEPTACLES ON EACH SUPPORT LEG OF SWITCH. SWITCH SHALL BE VERTICAL BREAK SWITCH VBI BY EM SPEC OR APPROVED EQUAL. CONTACT MARK SNYDER, 734-645-2886.

15. COORDINATE EXACT LOCATION WITH ARCHITECTURAL SITE PLAN DRAWING.


166 OF

361


M:5050 NICTD WEST LAKE PROJECT:04 - CADD FILES:04 - SHEET FILES:SOUTH HAMMOND STATION:SHT_WL_E_SHAMMOND_GN_04.DWG

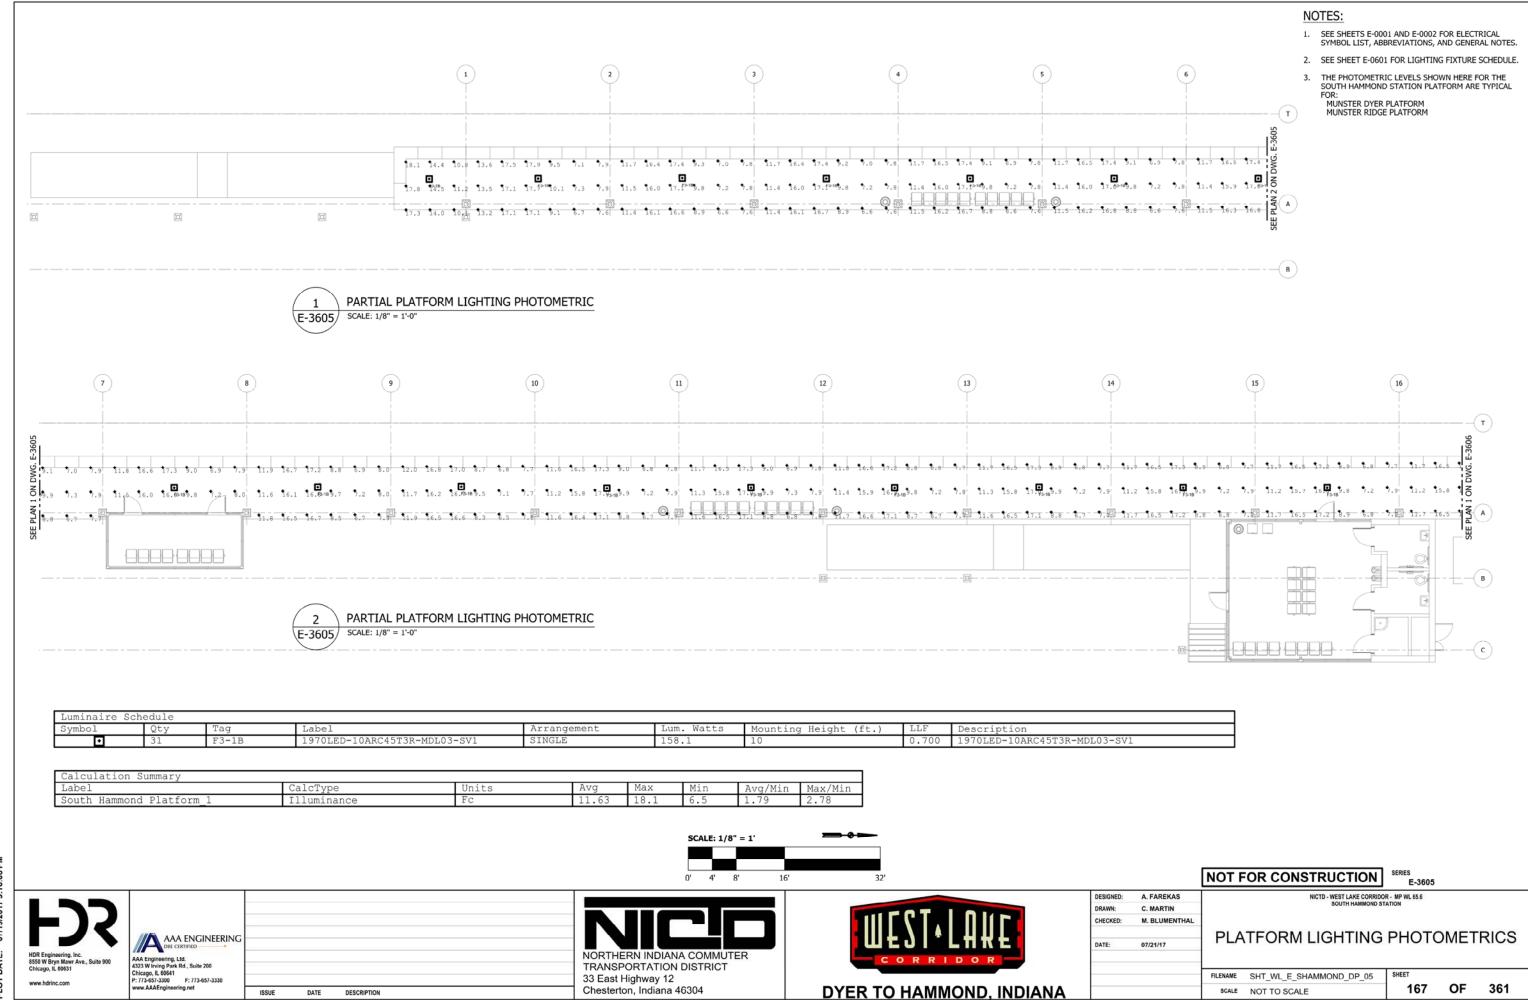

M:5050 NICTD WEST LAKE PROJECT:04 - CADD FILES:04 - SHEET FILES:SOUTH HAMMOND STATION:SHT_WL_E_SHAMMOND_DP_05.DWG

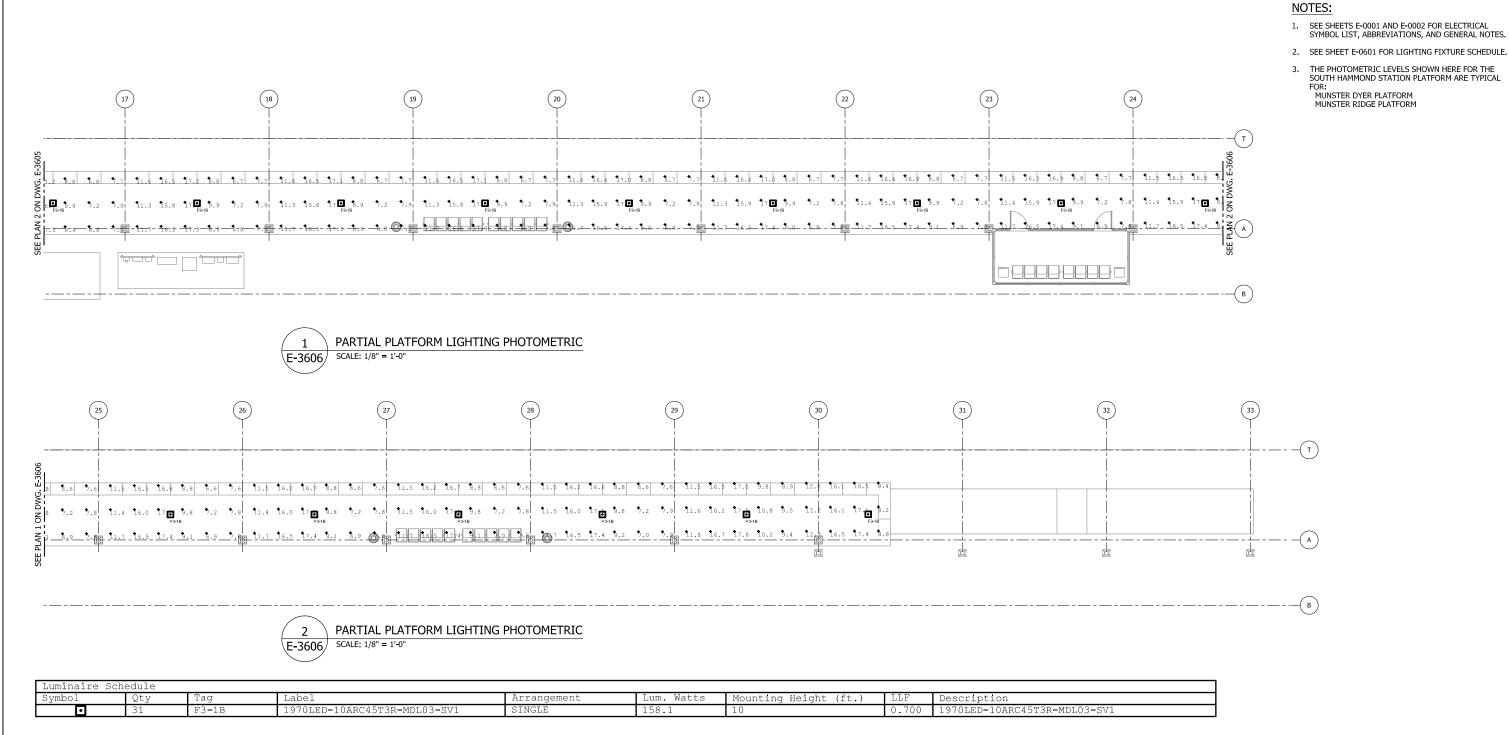


Calculation Summary							
Label	CalcType	Units	Avg	Max	Min	Avq/Min	Max/Min

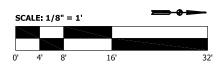



South Hammond Platform 1

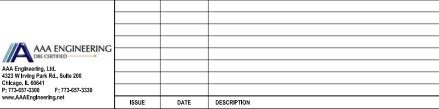

Illuminance





ESIGNED:	A. FAREKAS			_
RAWN:	C. MARTIN			
CHECKED:	M. BLUMENTHAL			
		ЫΛ	TFORM	
DATE:	07/21/17		III OIN	V
		FILENAME	SHT WLF	•

M LIGHTING PHOTOMETRICS

SHT_WL_E_SHAMMOND_DP_06 168 OF 361


NOT FOR CONSTRUCTION

 ${\tt M:15050\,NICTD\,WEST\,LAKE\,PROJECT:04-CADD\,FILES:04-SHEET\,FILES:SOUTH\,HAMMOND\,STATION:SHT_WL_E_SHAMMOND_DP_06.DWG}$

SCALE NOT TO SCALE



- SEE SHEETS E-0001 AND E-0002 FOR ELECTRICAL SYMBOL LIST, ABBREVIATIONS, AND GENERAL NOTES.
- 2. SEE SHEET E-0601 FOR LIGHTING FIXTURE SCHEDULE.

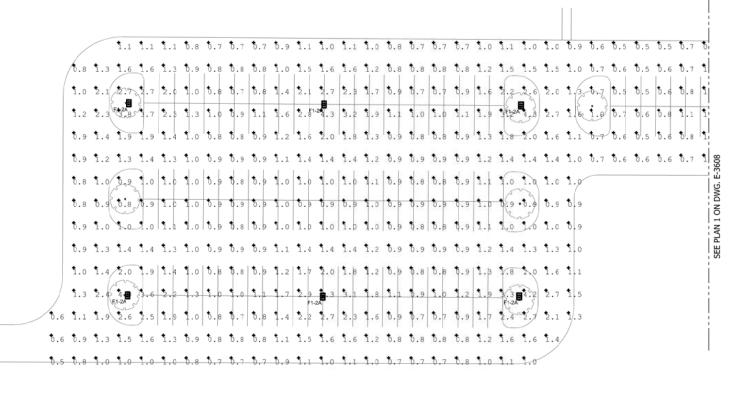

SCALE: 1/32" = 1'

PARKING LOT PARTIAL PHOTOMETRICS SCALE: 1/32" = 1'-0" E-3607/

Luminaire Schedule								
Symbol	Qty	Label	Arrangement	Tag	Lum. Watts	Mounting Height (ft.)	LLF	Description
-	7	DSX1_LED_40C_1000_40K_T4M_MV0	SINGLE	F1-1A	138	25	0.700	DSX1 LED 40C 1000 40K T4M MVOLT
#	22	DSX1 LED 40C 1000 40K T4M MVO 1	BACK-BACK	F1-2A	138	25	0.700	DSX1 LED 40C 1000 40K T4M MVOLT

Calculation Summary								
1	Label	CalcType	Units	Avg	Max	Min	Avg/Min	Max/Min
1	Central Parking Lot	Illuminance	FC	1.30	4.2	0.5	2.60	8.40
1	NorthParking Lot	Illuminance	FC	1.25	4.3	0.5	2.50	8.60
1	South Parking Lot	Illuminance	FC	1.10	4.3	0.5	2.20	8.60
1	Handicap Parking-Central A	Illuminance	FC	2.04	3.8	1.3	1.57	2.92
1	Handicap Parking-Central B	Illuminance	Fc	1.97	3.5	1.3	1.52	2.69



KEY PLAN

AAA ENGINEERING AAA Engineering, Ltd. 4323 W Irving Park Rd., Suite 200 Chicago, IL 60641 P: 773-657-3300 F: 773-657-3330 www.AAAEngineering.net ISSUE DATE DESCRIPTION

NORTHERN INDIANA COMMUTER TRANSPORTATION DISTRICT 33 East Highway 12 Chesterton, Indiana 46304





			NOT F	OR C	ONSTR	UCTION	SERIES E-36	607
	DESIGNED:	A. FAREKAS			NICTD -	WEST LAKE CORRI		
	DRAWN:	C. MARTIN				SOUTH HAMMOND	STATION	
	CHECKED:	M. BLUMENTHAL						
			DAD	PARKING LOT PARTIA				
	DATE:	07/21/17		PARKING LUT			PARTIAL PHO	
			FII FII 114	O. 17	E 011111111		QUEET	


RKING LOT PARTIAL PHOTOMETRICS

FILENAME SHT_WL_E_SHAMMOND_DP_07 169 OF 361 SCALE 1/32" = 1' - 0"

- SEE SHEETS E-0001 AND E-0002 FOR ELECTRICAL SYMBOL LIST, ABBREVIATIONS, AND GENERAL NOTES.
- 2. SEE SHEET E-0601 FOR LIGHTING FIXTURE SCHEDULE.

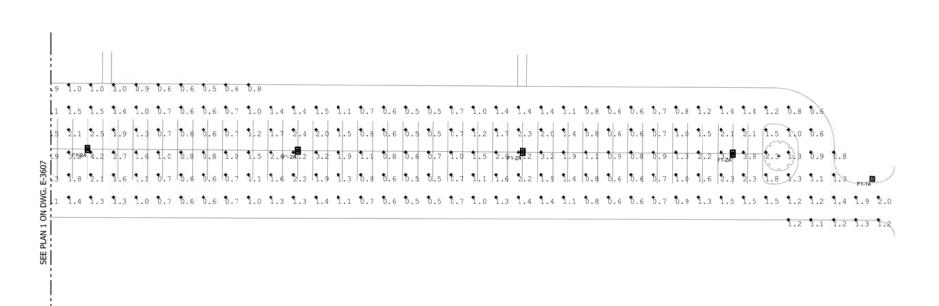

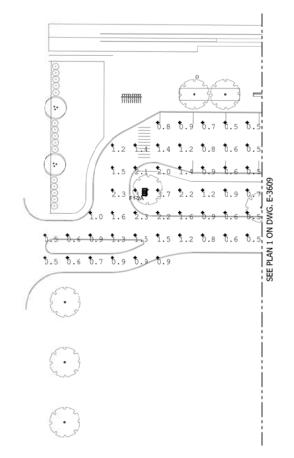

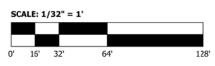



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Lumina	Luminaire Schedule								
Symbol		Qty	Label	Arrangement	Tag	Lum. Watts	Mounting Height (ft.)	LLF	Description
	→	7	DSX1_LED_40C_1000_40K_T4M_MV0	SINGLE	F1-1A	138	25	0.700	DSX1 LED 40C 1000 40K T4M MVOLT
<u> </u>	Đ.	22	DSX1 LED 40C 1000 40K T4M MVO 1	BACK-BACK	F1-2A	138	25	0.700	DSX1 LED 40C 1000 40K T4M MVOLT

Calculation Summary							
Label	CalcType	Units	Avg	Max	Min	Avg/Min	Max/Min
Central Parking Lot	Illuminance	FC	1.30	4.2	0.5	2.60	8.40
NorthParking Lot	Illuminance	Fc	1.25	4.3	0.5	2.50	8.60
South Parking Lot	Illuminance	FC	1.10	4.3	0.5	2.20	8.60
Handicap Parking-Central A	Illuminance	FC	2.04	3.8	1.3	1.57	2.92
Handicap Parking-Central B	Illuminance	FC	1.97	3.5	1.3	1.52	2.69

Generalismo O		
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KEY PLAN



AAA ENGINEERING
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AAA Engineering, Ltd.
432 W Irving Park Rd., Suite 200
Chicago, IL 60641
P. 173-547-3330
Www.AAAEngineering.net


ISSUE DATE DESCRIPTION





			NOT F	OR CONSTRUCTION	SERIES E-3608				
1	DESIGNED:	A. FAREKAS		NICTD - WEST LAKE CORRIDO					
	DRAWN:	C. MARTIN		SOUTH HAMMOND ST	ATION				
	CHECKED:	M. BLUMENTHAL							
			PARKING LOT PARTIAL PHOTOMETRICS						
ı	DATE:	07/21/17							
			FILENAME	SHT_WL_E_SHAMMOND_DP_08	SHEET				
			SCALE	1/32" = 1' - 0"	170	OF	361		

- SEE SHEETS E-0001 AND E-0002 FOR ELECTRICAL SYMBOL LIST, ABBREVIATIONS, AND GENERAL NOTES.
- 2. SEE SHEET E-0601 FOR LIGHTING FIXTURE SCHEDULE.

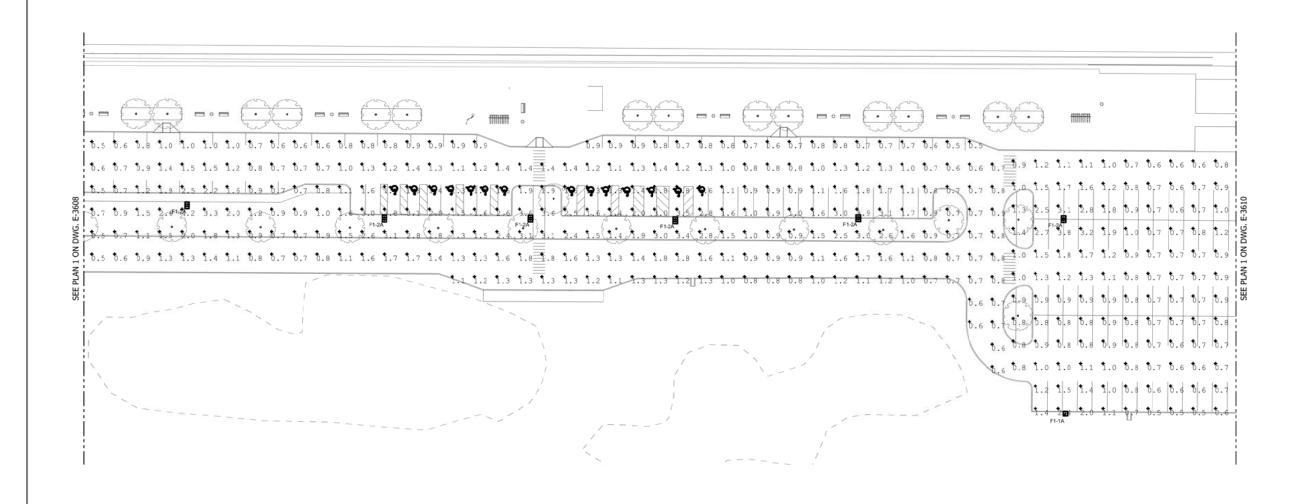

Luminaire Schedule								
Symbol	Qty	Label	Arrangement	Tag	Lum. Watts	Mounting Height (ft.)	LLF	Description
•	7	DSX1 LED 40C 1000 40K T4M MVO	SINGLE	F1-1A	138	25	0.700	DSX1 LED 40C 1000 40K T4M MVOLT
#	22	DSX1_LED 40C 1000 40K T4M MVO 1	BACK-BACK	F1-2A	138	25	0.700	DSX1 LED 40C 1000 40K T4M MVOLT

SCALE: 1/32" = 1'-0"

E-3609

Calculation Summary							
Label	CalcType	Units	Avg	Max	Min	Avg/Min	Max/Min
Central Parking Lot	Illuminance	Fc	1.30	4.2	0.5	2.60	8.40
NorthParking Lot	Illuminance	Fc	1.25	4.3	0.5	2.50	8.60
South Parking Lot	Illuminance	Fc	1.10	4.3	0.5	2.20	8.60
Handicap Parking-Central A	Illuminance	Fc	2.04	3.8	1.3	1.57	2.92
Handicap Parking-Central_B	Illuminance	Fc	1.97	3.5	1.3	1.52	2.69



KEY PLAN



AAA ENGINEERING AAA Engineering, Ltd. 4323 W Irving Park Rd., Suite 200 Chicago, IL 60641 P: 773-657-3300 F: 773-657-3330 www.AAAEngineering.net DATE DESCRIPTION

SCALE: 1/32" = 1'

NORTHERN INDIANA COMMUTER TRANSPORTATION DISTRICT 33 East Highway 12 Chesterton, Indiana 46304


PARKING LOT PARTIAL PHOTOMETRICS




		NOT F	OR CONSTRUCTION	SERIES E-3609					
DESIGNED:	A. FAREKAS		NICTD - WEST LAKE CORRIDO SOUTH HAMMOND ST						
DRAWN:	C. MARTIN	l	300 TH TIAMMOND 31	Allon					
CHECKED:	M. BLUMENTHAL								
			KING LOT DADTIAL	DHOT	OME	TDICS			
DATE:	07/21/17	LYV	PARKING LOT PARTIAL PHOTOMETRICS						
		FILENAME	SHT_WL_E_SHAMMOND_DP_09	SHEET					
		SCALE	1/32" = 1' - 0"	171	OF	361			



- SEE SHEETS E-0001 AND E-0002 FOR ELECTRICAL SYMBOL LIST, ABBREVIATIONS, AND GENERAL NOTES.
- 2. SEE SHEET E-0601 FOR LIGHTING FIXTURE SCHEDULE.

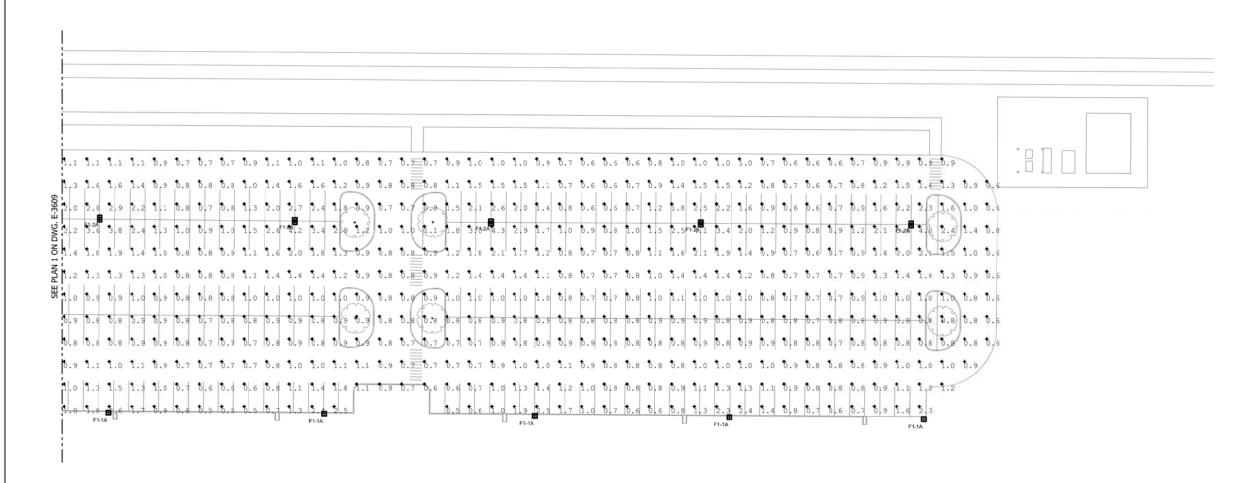


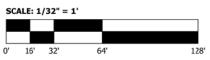

PARKING LOT PARTIAL PHOTOMETRICS SCALE: 1/32" = 1'-0" E-3610/

Luminaire Schedule								
Symbol	Qty	Label	Arrangement	Tag	Lum. Watts	Mounting Height (ft.)	LLF	Description
•	7	DSX1 LED 40C 1000 40K T4M MV0	SINGLE	F1-1A	138	25	0.700	DSX1 LED 40C 1000 40K T4M MVOLT
#	22	DSX1 LED 40C 1000 40K T4M MVO 1	BACK-BACK	F1-2A	138	25	0.700	DSX1 LED 40C 1000 40K T4M MVOLT

Calculation Summary							
Label	CalcType	Units	Avg	Max	Min	Avg/Min	Max/Min
Central Parking Lot	Illuminance	Fc	1.30	4.2	0.5	2.60	8.40
NorthParking Lot	Illuminance	Fc	1.25	4.3	0.5	2.50	8.60
South Parking Lot	Illuminance	Fc	1.10	4.3	0.5	2.20	8.60
Handicap Parking-Central A	Illuminance	Fc	2.04	3.8	1.3	1.57	2.92
Handicap Parking-Central B	Illuminance	Fc	1.97	3.5	1.3	1.52	2.69

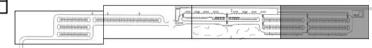

KEY PLAN

AAA Engineering, Ltd. 4323 W Irving Park Rd., Suite 200 Chicago, IL 60641 P: 773-657-3300 F: 773-657-3330 www.AAAEngineering.net ISSUE DATE DESCRIPTION


NORTHERN INDIANA COMMUTER TRANSPORTATION DISTRICT 33 East Highway 12 Chesterton, Indiana 46304



			NOT F	OR CONSTRUCTION	SERIES E-3610
DESIGNED:	A. FAREKAS		NICTD - WEST LAKE CORRIDO		
	DRAWN:	WN: C. MARTIN		SOUTH HAMMOND ST	TATION
	CHECKED:	M. BLUMENTHAL			
			DAD	PARKING LOT PARTIA	
DATE:	DATE:	07/21/17		KING LOT PAKTIAL	- 1101
				C. IT. W. E. C. LANDON B. D. 40	eucct

NICTD - WEST LAKE CORRIDOR - MP WL 65.6 SOUTH HAMMOND STATION RKING LOT PARTIAL PHOTOMETRICS

FILENAME SHT_WL_E_SHAMMOND_DP_10 172 OF 361 SCALE 1/32" = 1' - 0"

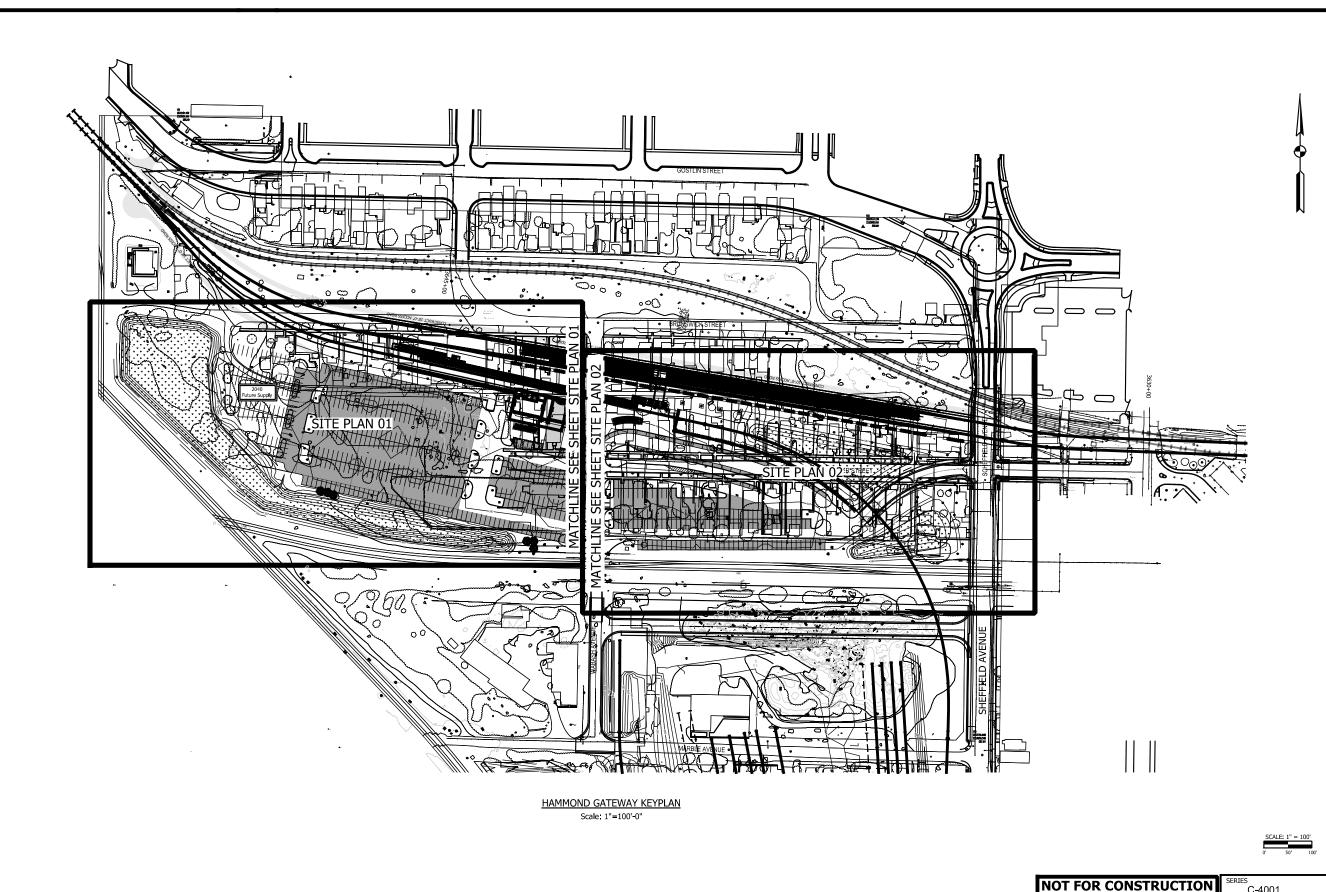




HDR Engineering, Inc. 8550 W Bryn Mawr Ave., Sulte 900 Chapter, L. 60331







				U-4	.001				
DESIGNED:	JKH	NICTD - WEST LAKE CORRIDOR - MP WL 61.38 TO WL 69.18							
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CHECKED:	CGH								
			MMOND CATEMA	V QIT		VDI AK	ı		
DATE:	07/21/17	HAMMOND GATEWAY SITE KEYPLAN							
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		SCALE	AS NOTED	173	OF	361			

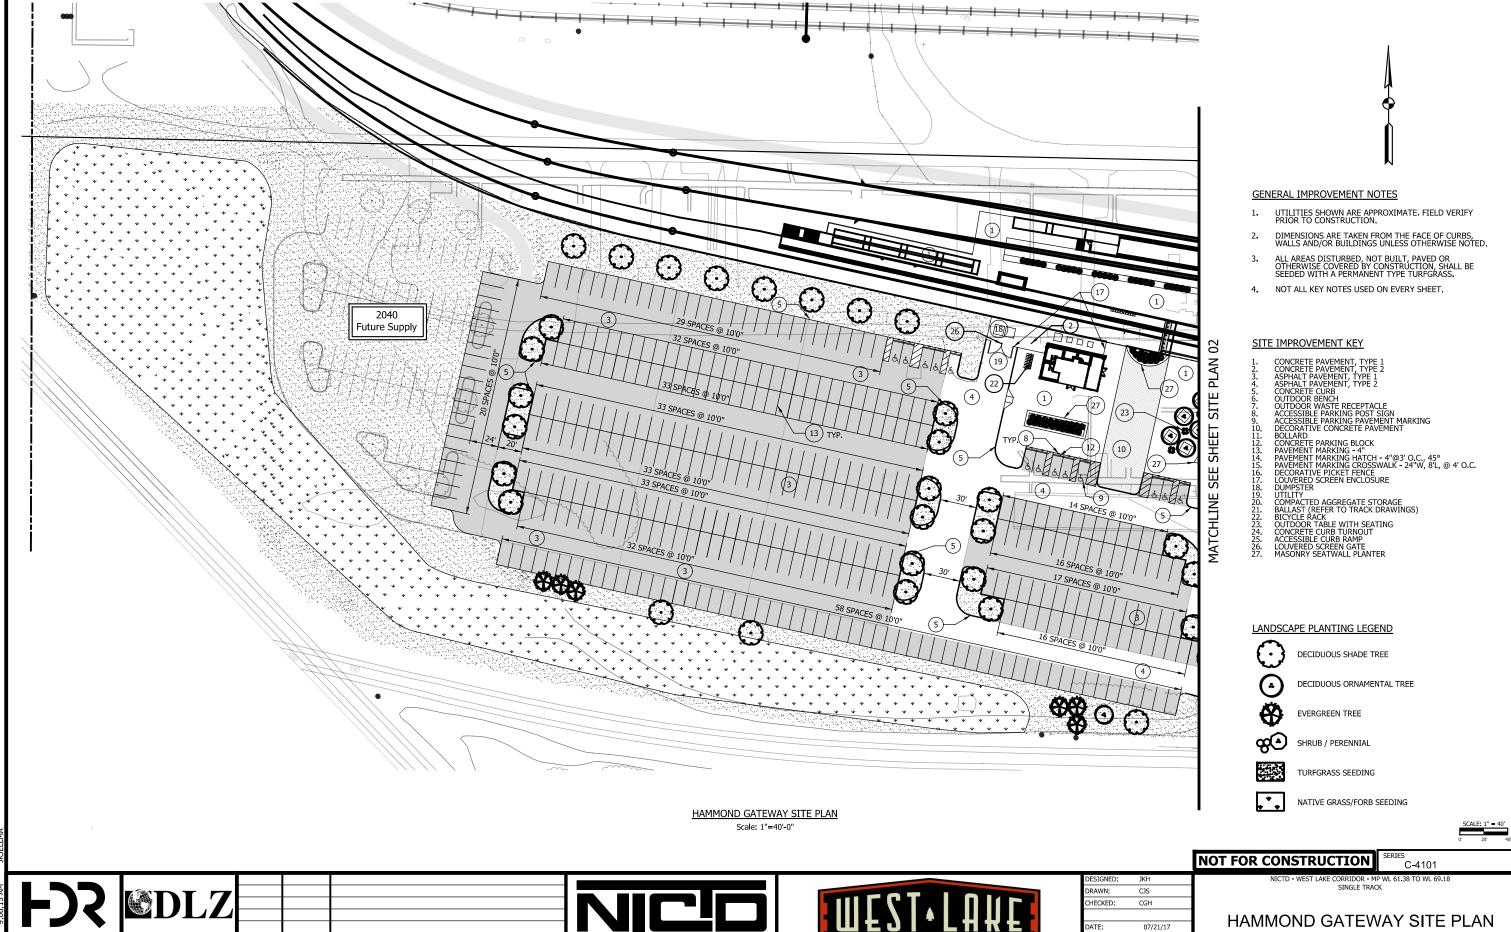

NORTHERN INDIANA COMMUTER

TRANSPORTATION DISTRICT 33 East Highway 12 Chesterton, Indiana 46304

07/21/17

DYER TO HAMMOND, INDIANA


FACILITY

174 OF 361

SHT_WL_FA_HGS_PL_01.dgn

www.hdrinc.com

DLZ Indiana, LLC 2211 E. Jefferson Boulevard South Bend, IN 46615

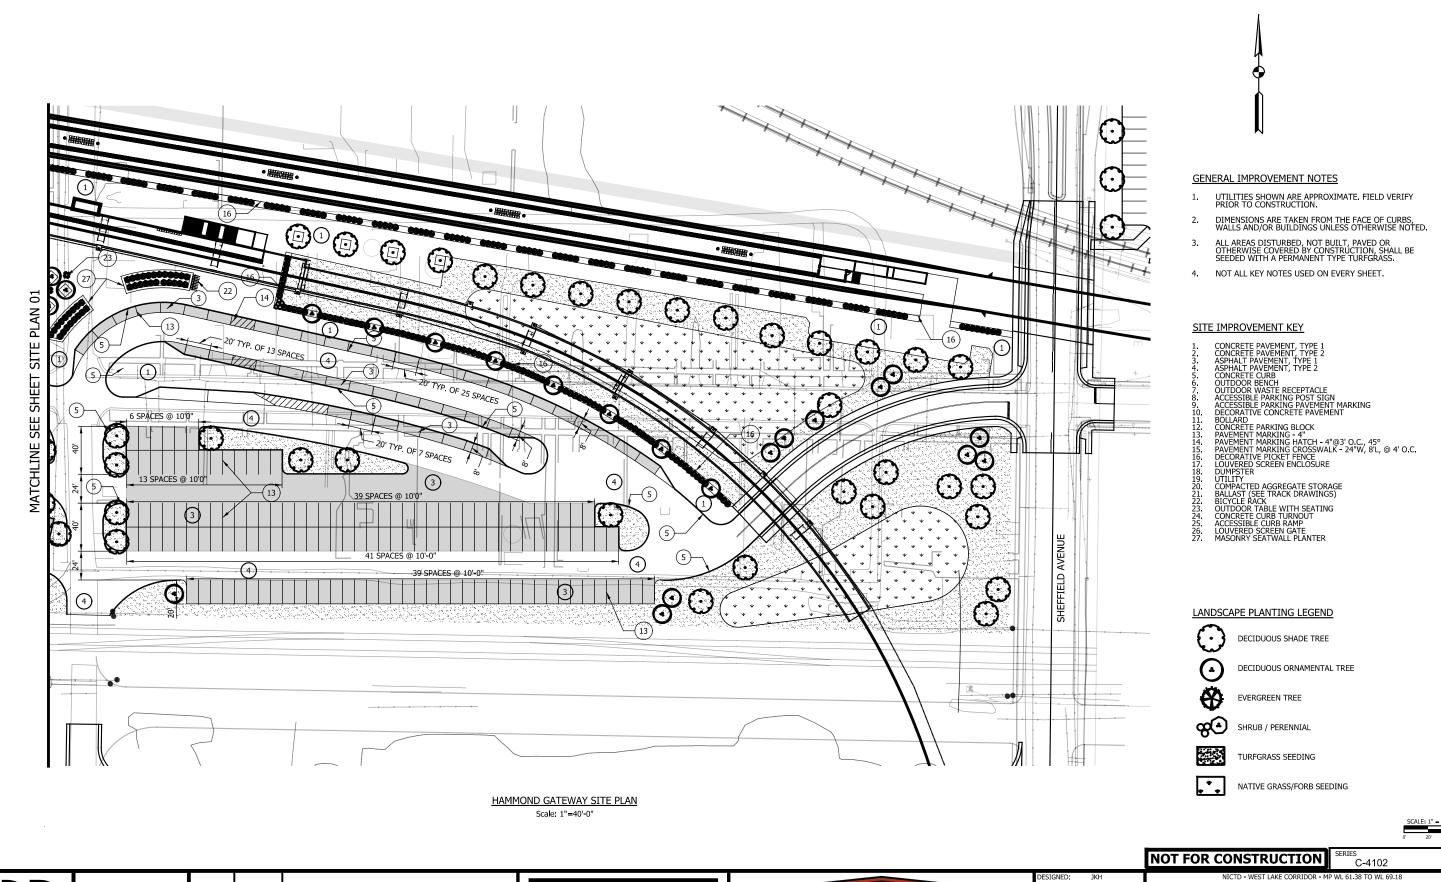

DLZ Indiana, LLC 2211 E. Jefferson Boulevard South Bend, IN 46615 www.hdrinc.com

NORTHERN INDIANA COMMUTER TRANSPORTATION DISTRICT 33 East Highway 12 Chesterton, Indiana 46304




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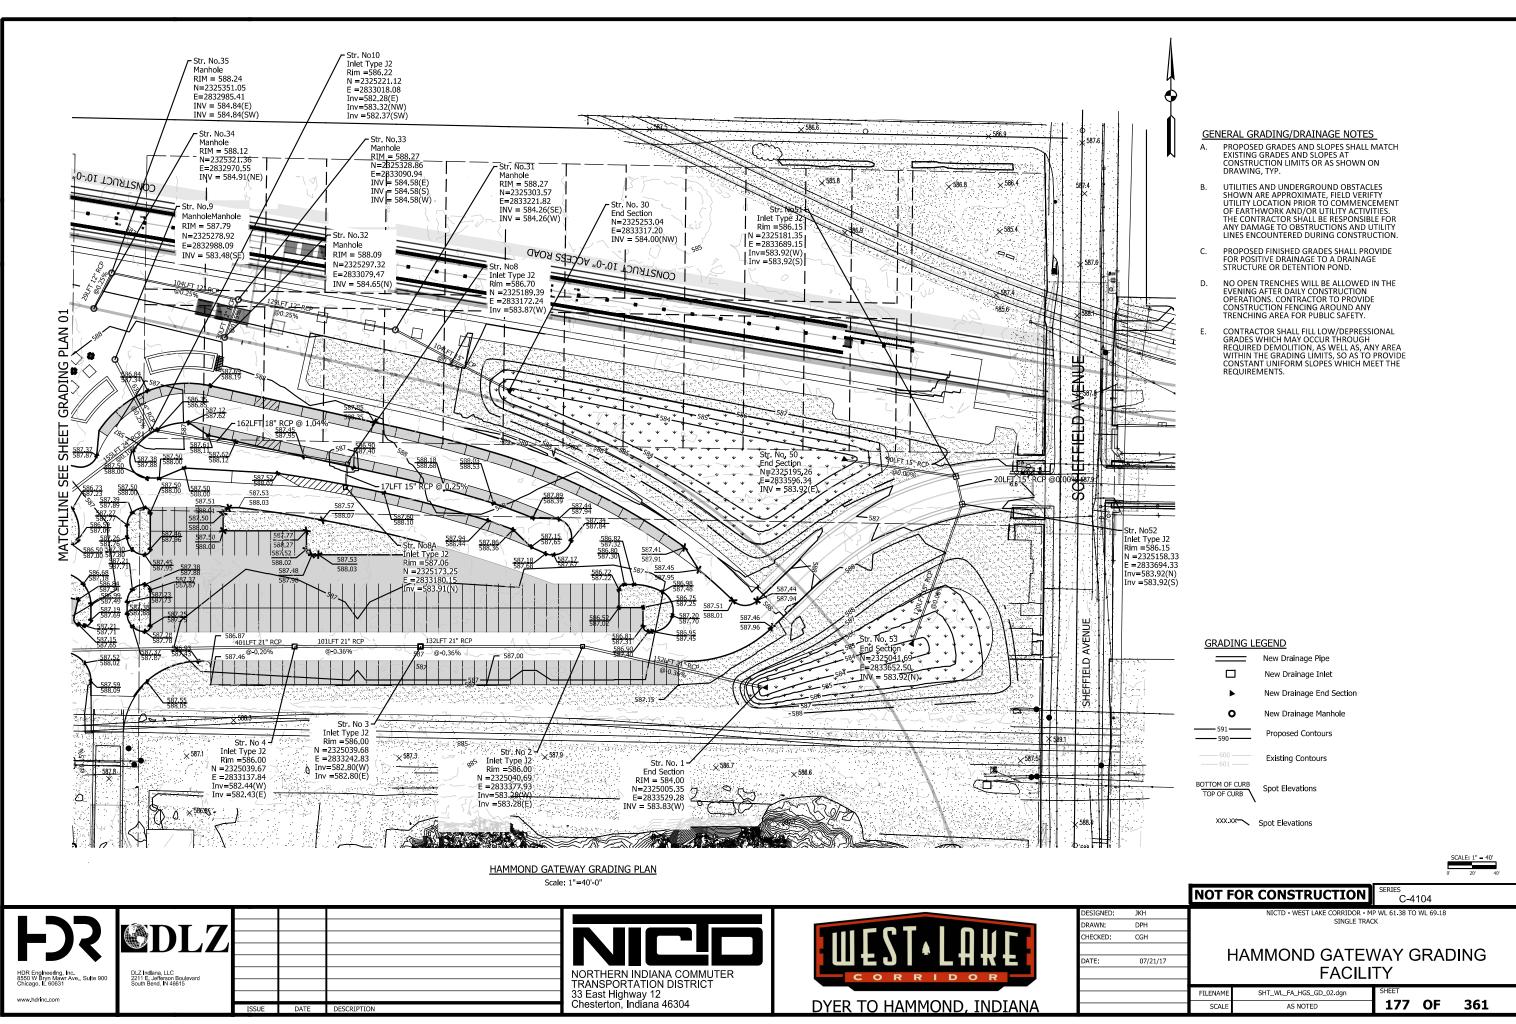
NICTD - WEST LAKE CORRIDOR - MP W SINGLE TRACK

HAMMOND GATEWAY SITE PLAN **FACILITY**

SHT_WL_FA_HGS_PL_02.dgn SCALE


175 OF 361




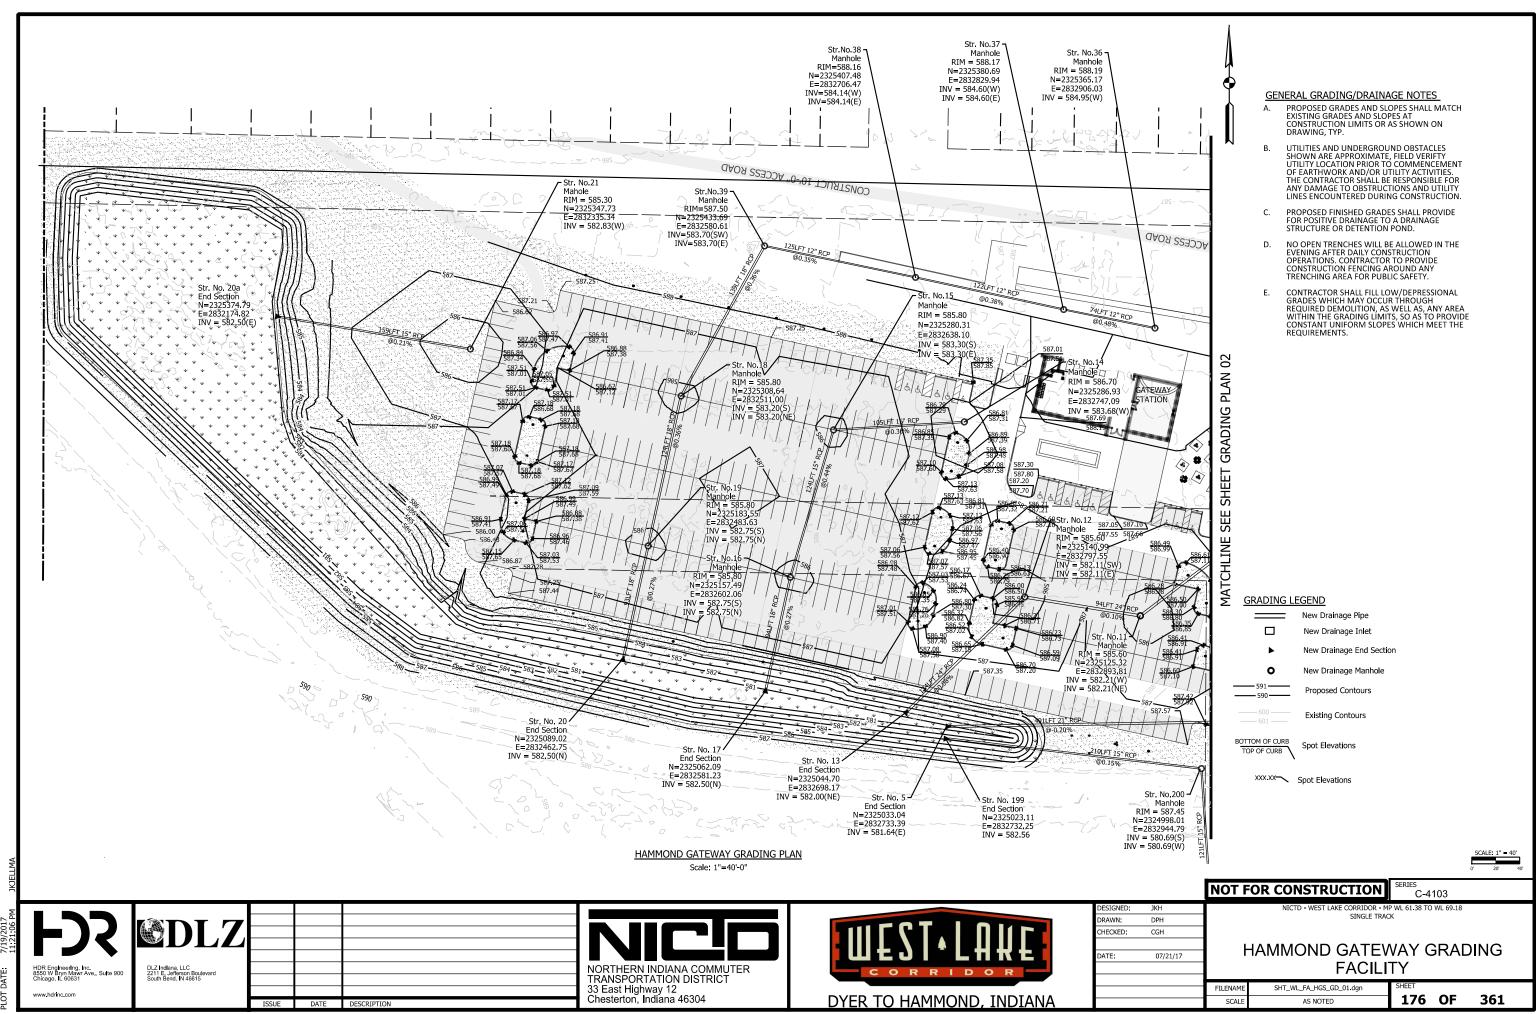


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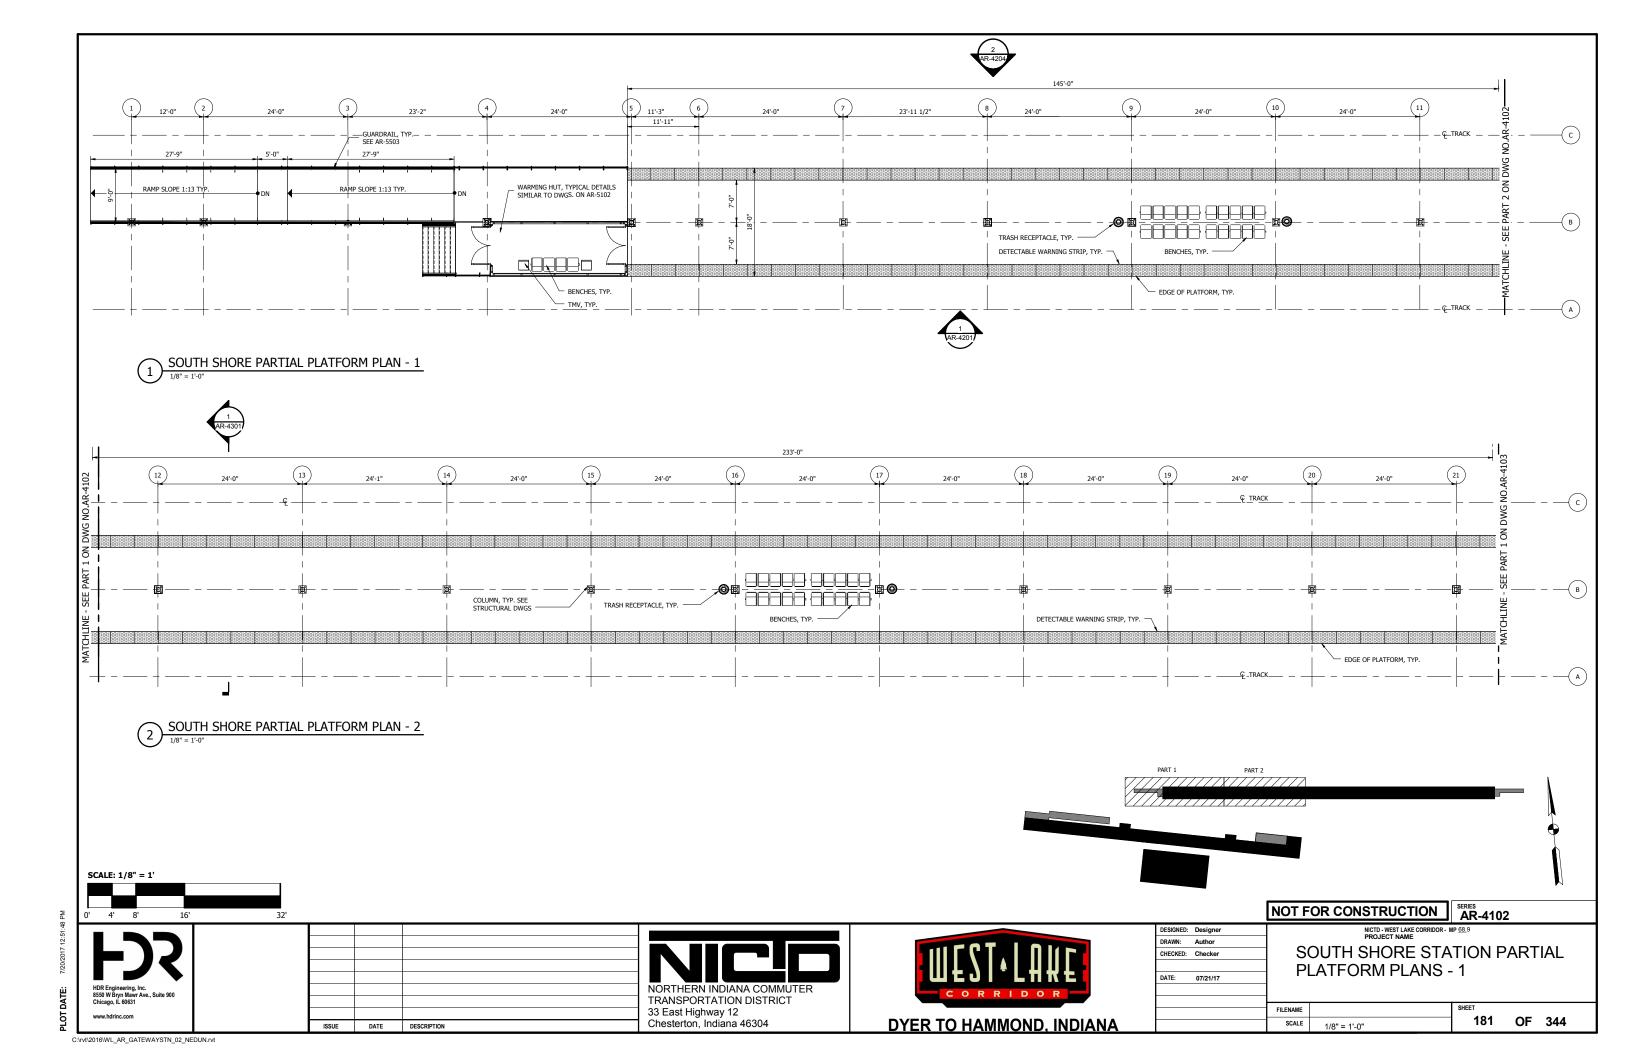
TRANSPORTATION DISTRICT 33 East Highway 12 Chesterton, Indiana 46304

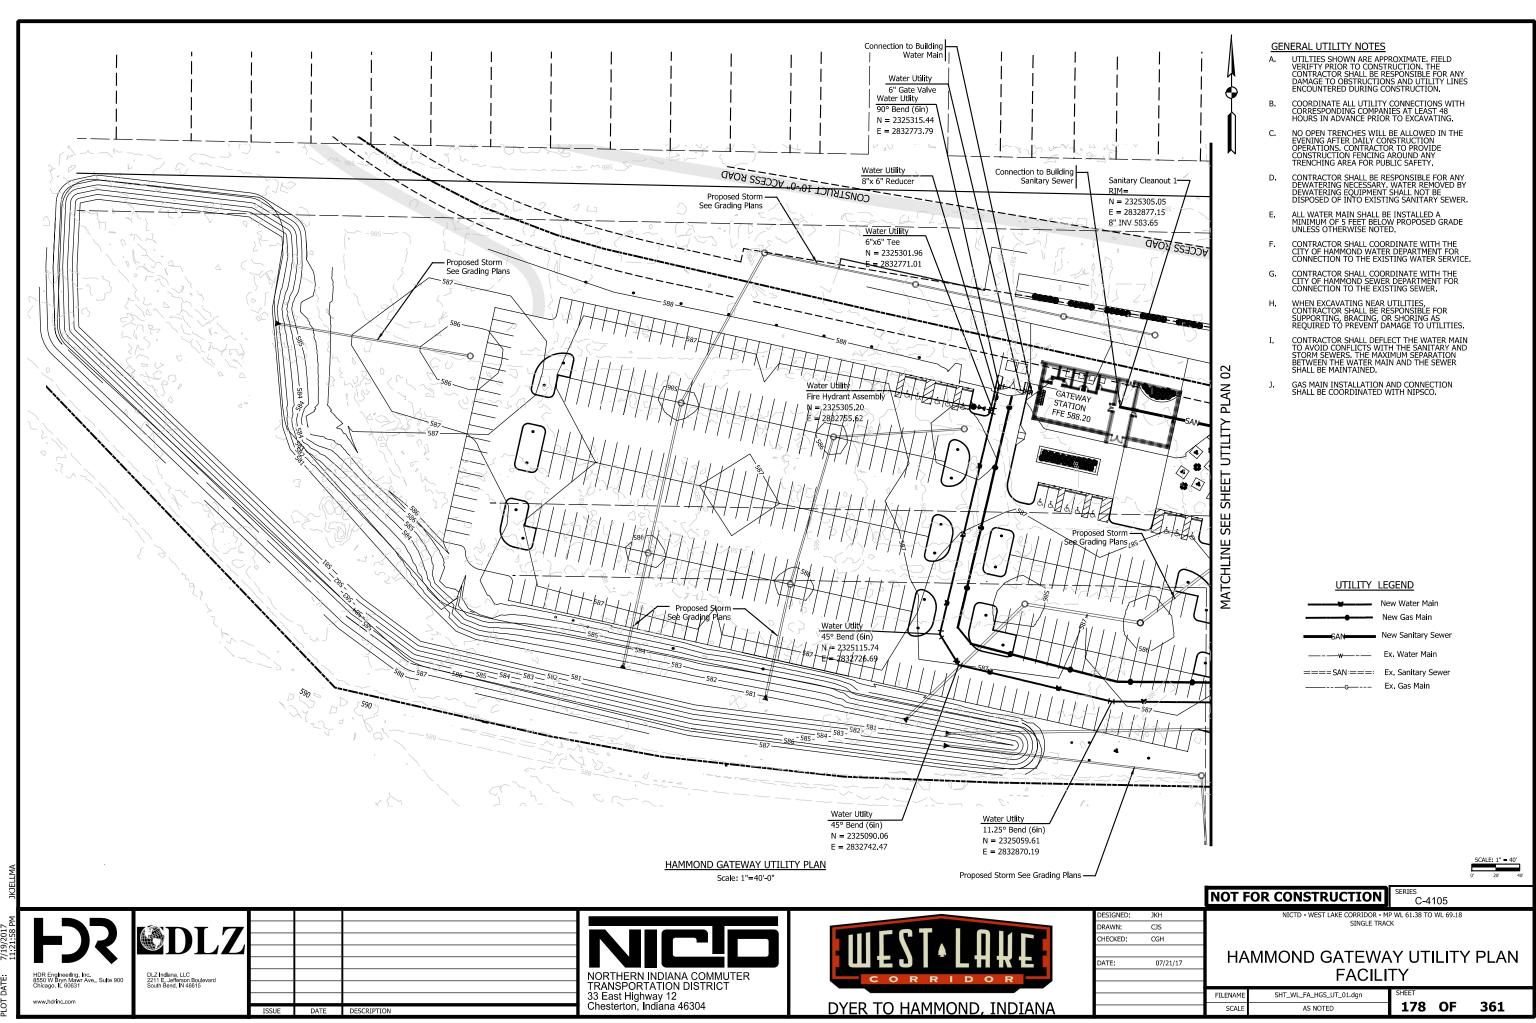



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DESIGNED:	R. Krieger		NICTD - WEST LAKE CORRIDOR - I	ир <u>69.</u> 0			_	
DRAWN:	Author	_						
CHECKED:	Checker	GATEWAY STATION SITE PLAN						
DATE:	07/21/17							
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		FILENAME						
		SCALE	1" = 60'-0"	180	OF	361		

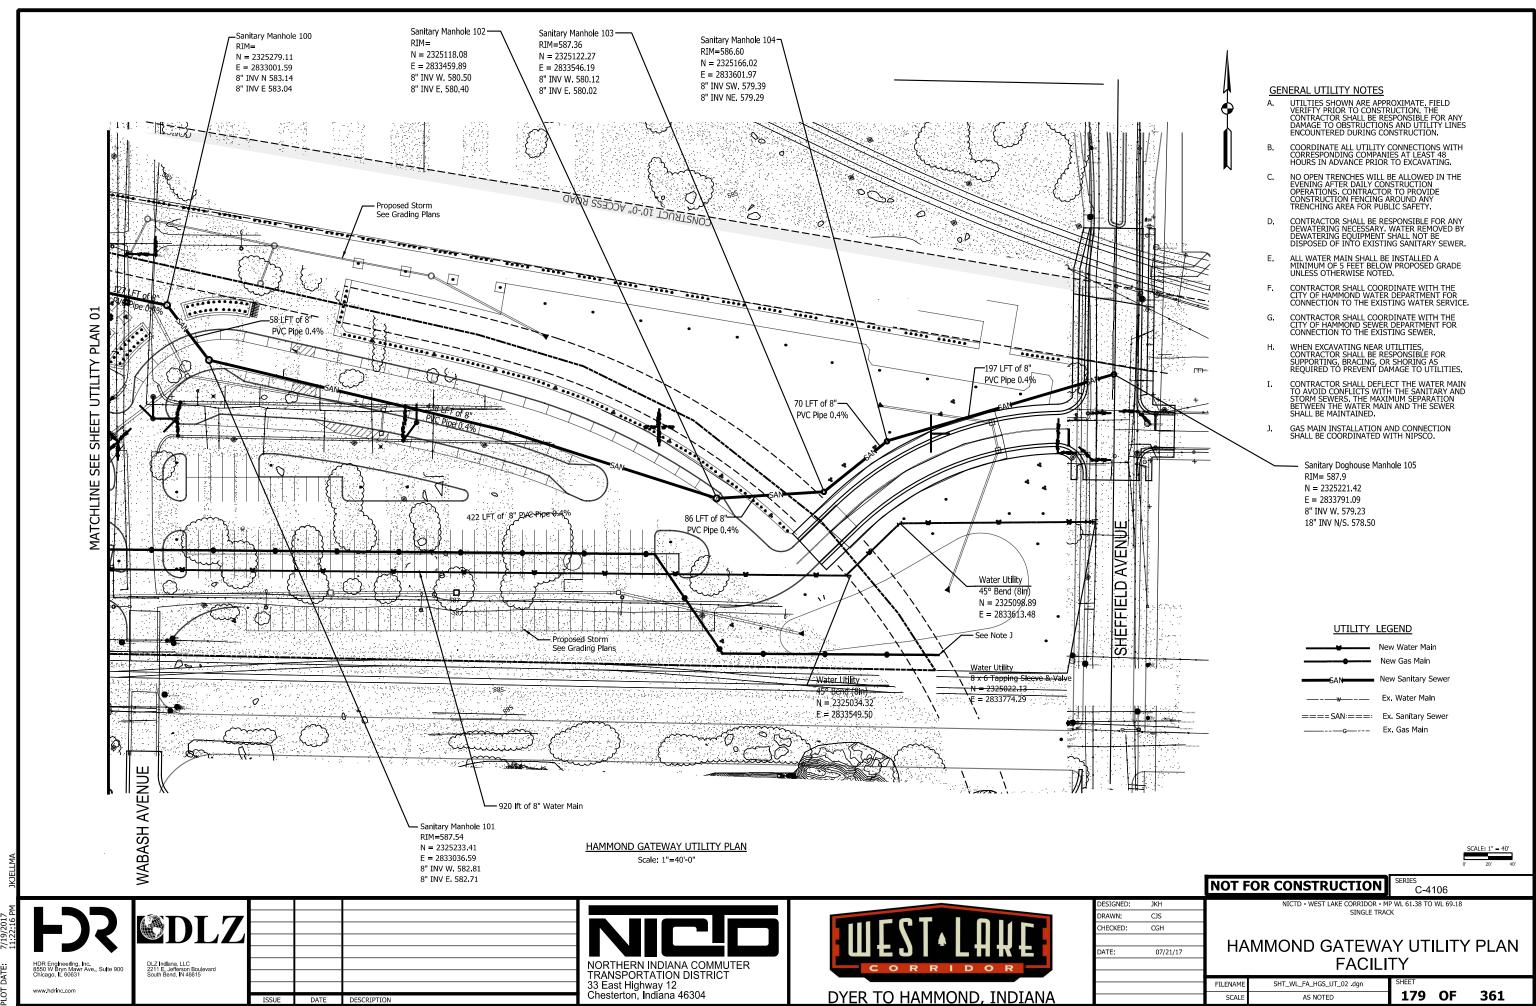SCALE 1" = 60'-0"

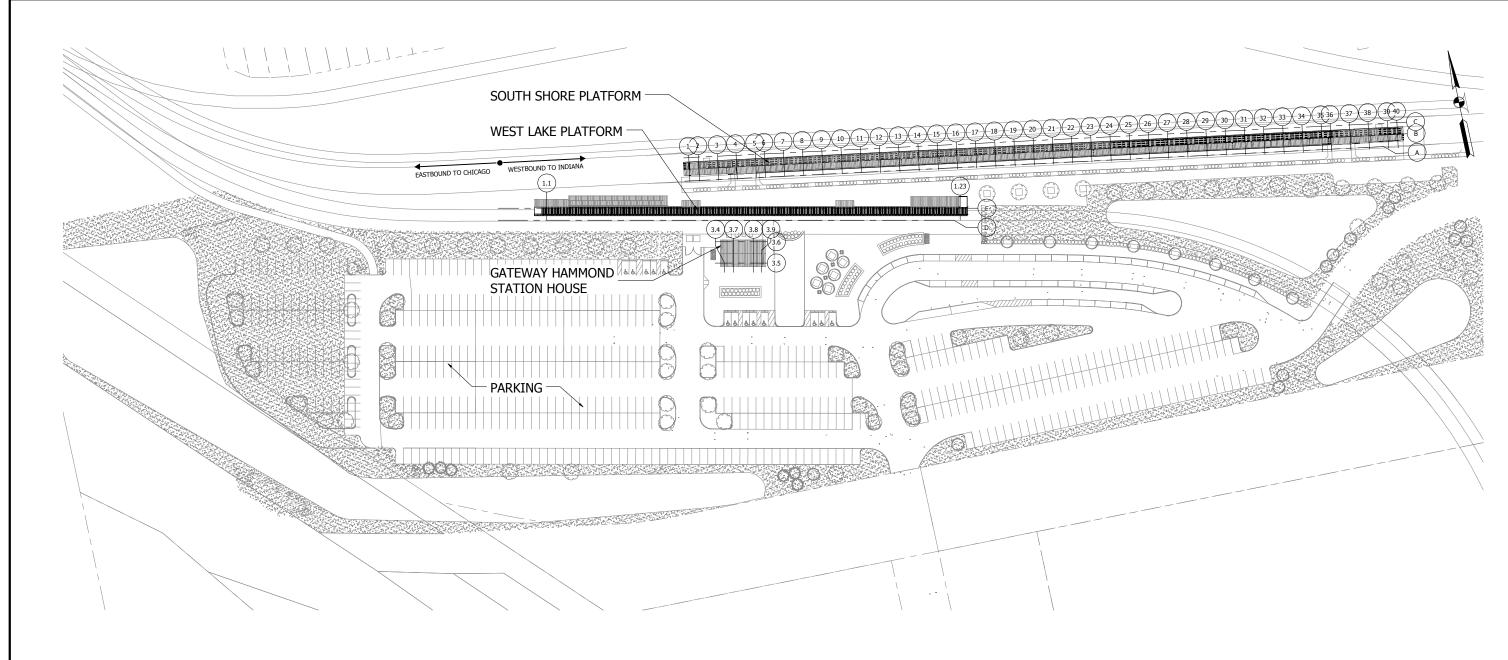
ISSUE DATE DESCRIPTION



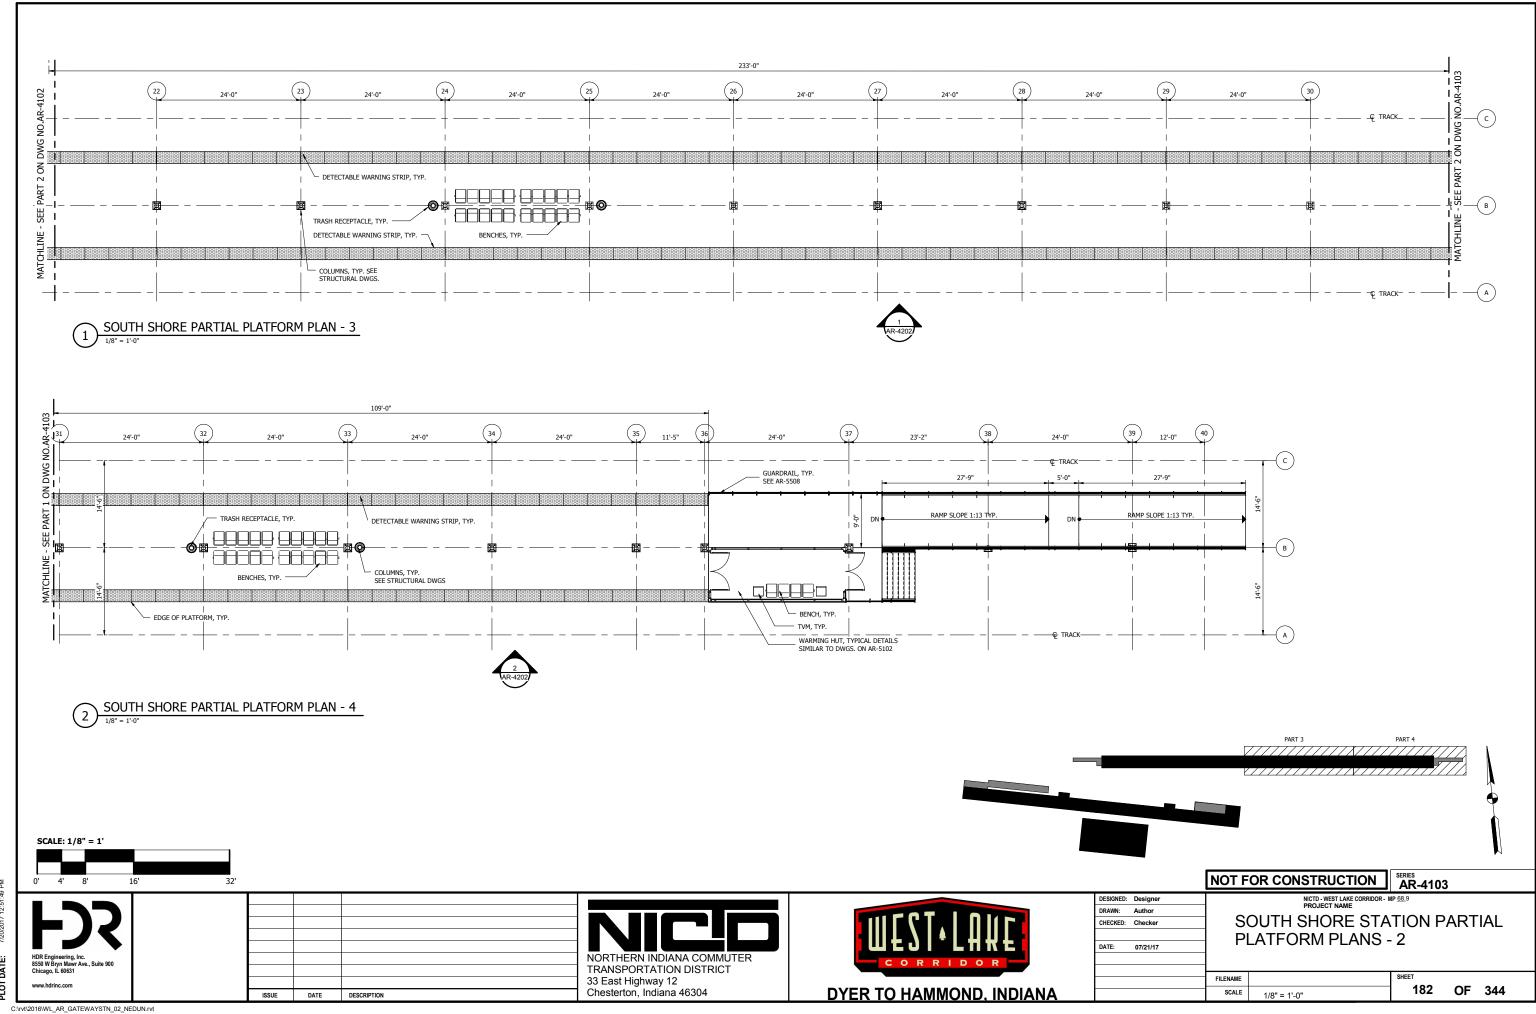

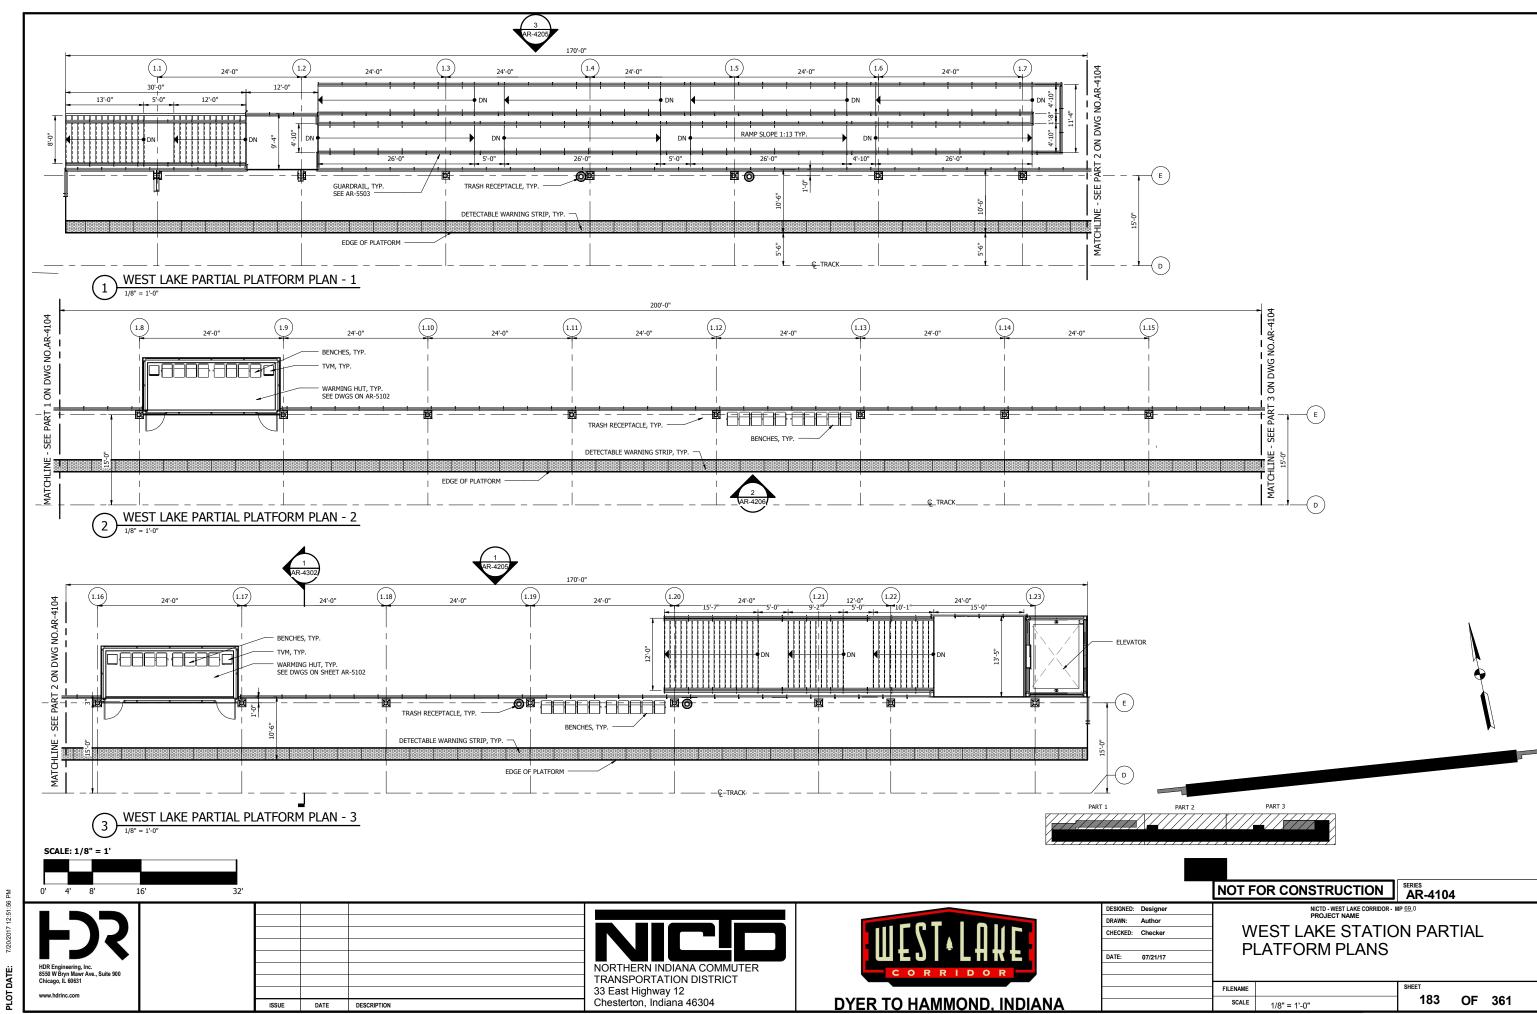

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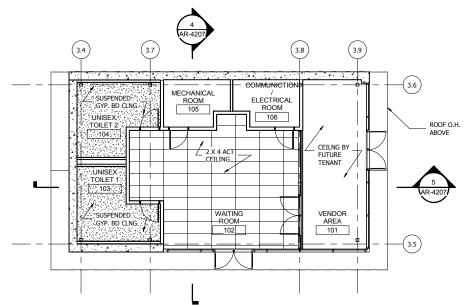


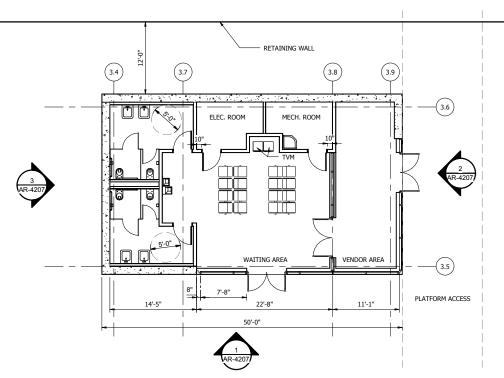NOTE: ALL INTERIOR WALLS 6" CMU WITH 1/2" PLASTER ON BOTH SIDES U.O.N. $\,$

CHASE WALL PARTITION: 3 5/8" METAL STUD FRAMING WITH 1/2" CEMENT BD AT TILED WAINSCOTT; 5/8" MOISTURE RESISTANT GYP. BD. ABOVE TYP.

COLUMN ENCLOSURE: 3 5/8" METAL STUD AND TWO LAYERS OF 5/8" GYP. BD.

STATION BUILDING - 1ST FLOOR



NOTE: CEILING ARE TO BE EXPOSED PAINTED CEILING U.O.N.

ALL CEILING HEIGHT REFERENCE ARE FROM FINISHED FIRST FLOOR LEVEL

REFLECTED CEILING PLAN - 1ST FLOOR



ISSUE DATE DESCRIPTION


NORTHERN INDIANA COMMUTER TRANSPORTATION DISTRICT 33 East Highway 12 Chesterton, Indiana 46304



		NOT F	OR CONSTRUCTION	AR-4105	;	
DESIGNED:	Designer		NICTD - WEST LAKE CORRIDOR - I	MP <u>69.</u> 0		
DRAWN:	Author	_				_
CHECKED:	Checker	S	TATION HOUSE FL	.00R PI	LAN:	S
DATE:	07/21/17					
				T		
		FILENAME		SHEET		
		SCALE	1/8" = 1'_0"	184	OF	361

1/8" = 1'-0"

SCALE

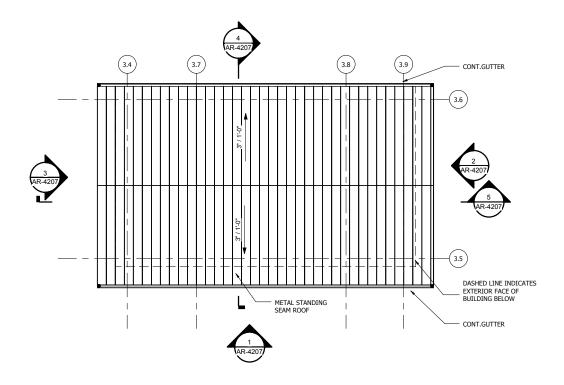

STATION BUILDING ROOF PLAN

1/8" = 1'-0"

				Door Sc	hedule			
Door number	Width	Height	Thickness	Door Material	Frame Material	Frame thickness	Fire Rating	Comments
7	3' - 0"	7' - 0"	0' - 1 3/4"	НМ	НМ	0' - 2"		
8	3' - 0"	7' - 0"	0' - 1 3/4"	HM		0' - 2"		
11	3' - 0"	7' - 2"						
16	3' - 0"	7' - 2"						
17	3' - 0"	7' - 2"						
19	3' - 0"	7' - 0"	0' - 1 3/4"	<by category=""></by>	<by category=""></by>	0' - 2"		
20	3' - 0"	7' - 0"	0' - 1 3/4"	<by category=""></by>	<by category=""></by>	0' - 2"		
21	3' - 0"	7' - 2"						
24	3' - 0"	7' - 2"						
25	3' - 0"	7' - 2"						
29	3' - 0"	7' - 2"						
144	3' - 0"	7' - 0"	0' - 1 3/4"	<by category=""></by>	<by category=""></by>	0' - 2"		


	Room Finish Schedule					
				Finishes		
Room No.	Name	Wall	Base	Ceiling	Floor	Comments
		•	•	•		•
101	VENDOR AREA	SPG	N/A	N/A	CT	5' HIGH WAINSCOAT CT ALL AROUND
102	WAITING ROOM	SGP	N/A	METAL PANEL	CT	5' HIGH WAINSCOAT CT ALL AROUND
103	UNISEX TOILET 1	CT/SPG	N/A	ACT	CT	5' HIGH WAINSCOAT CT ALL AROUND
104	UNISEX TOILET 2	CT/SPG	N/A	ACT	CT	5' HIGH WAINSCOAT CT ALL AROUND
105	MECHANICAL ROOM	CONC	CONC	N/A	CONC	
106	COMMUNICTION / ELECTRICAL ROOM	CONC	CONC	N/A	CONC	

 ${\sf KEY}\;{\sf NOTE}\;{\sf LEGEND};$

ACT: ACOUSTICAL CEILING TILE CT: CERAMIC TILE CONC: CONCRETE SGP: SEMI GLOSS PAINT

DESIGNED: Designer DRAWN: Author

CHECKED: Checker DATE: 07/21/17

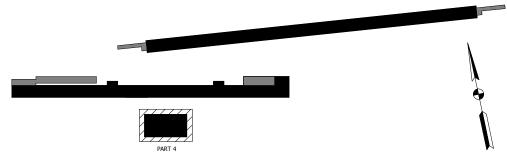


NOT FOR CONSTRUCTION SERIES AR-4121

NICTD - WEST LAKE CORRIDOR - MP 69.0 PROJECT NAME


STATION HOUSE ROOF PLAN

FILENAME 185 OF 361 SCALE 1/8" = 1'-0"

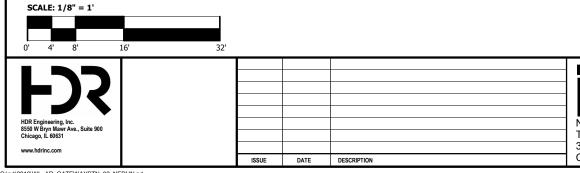






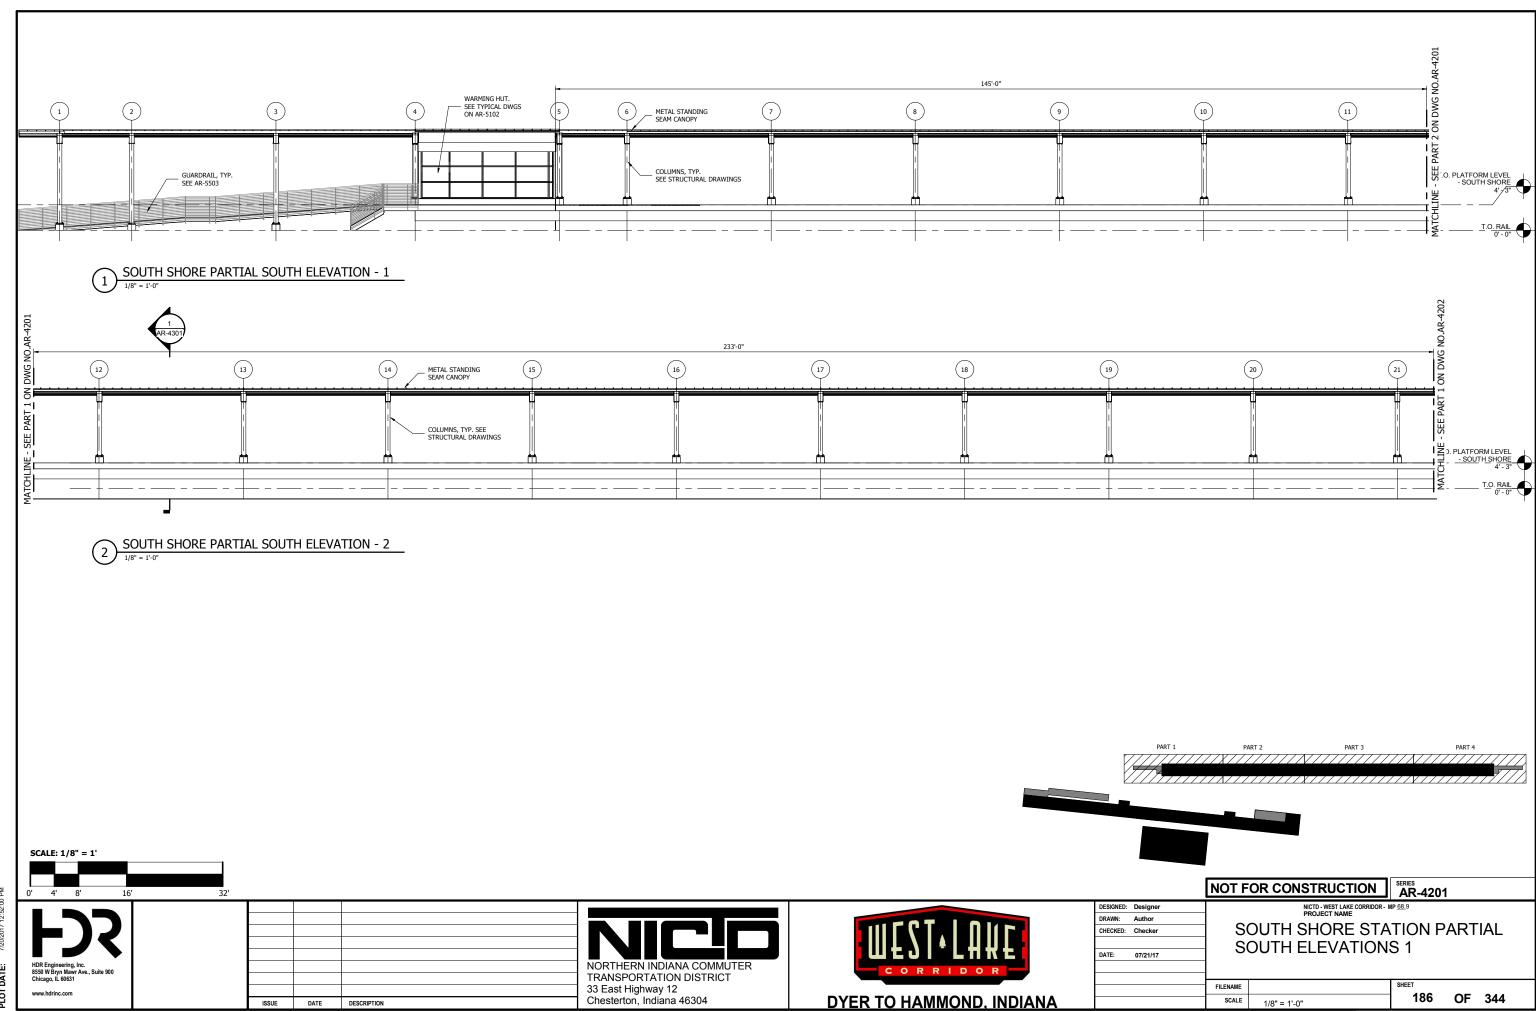

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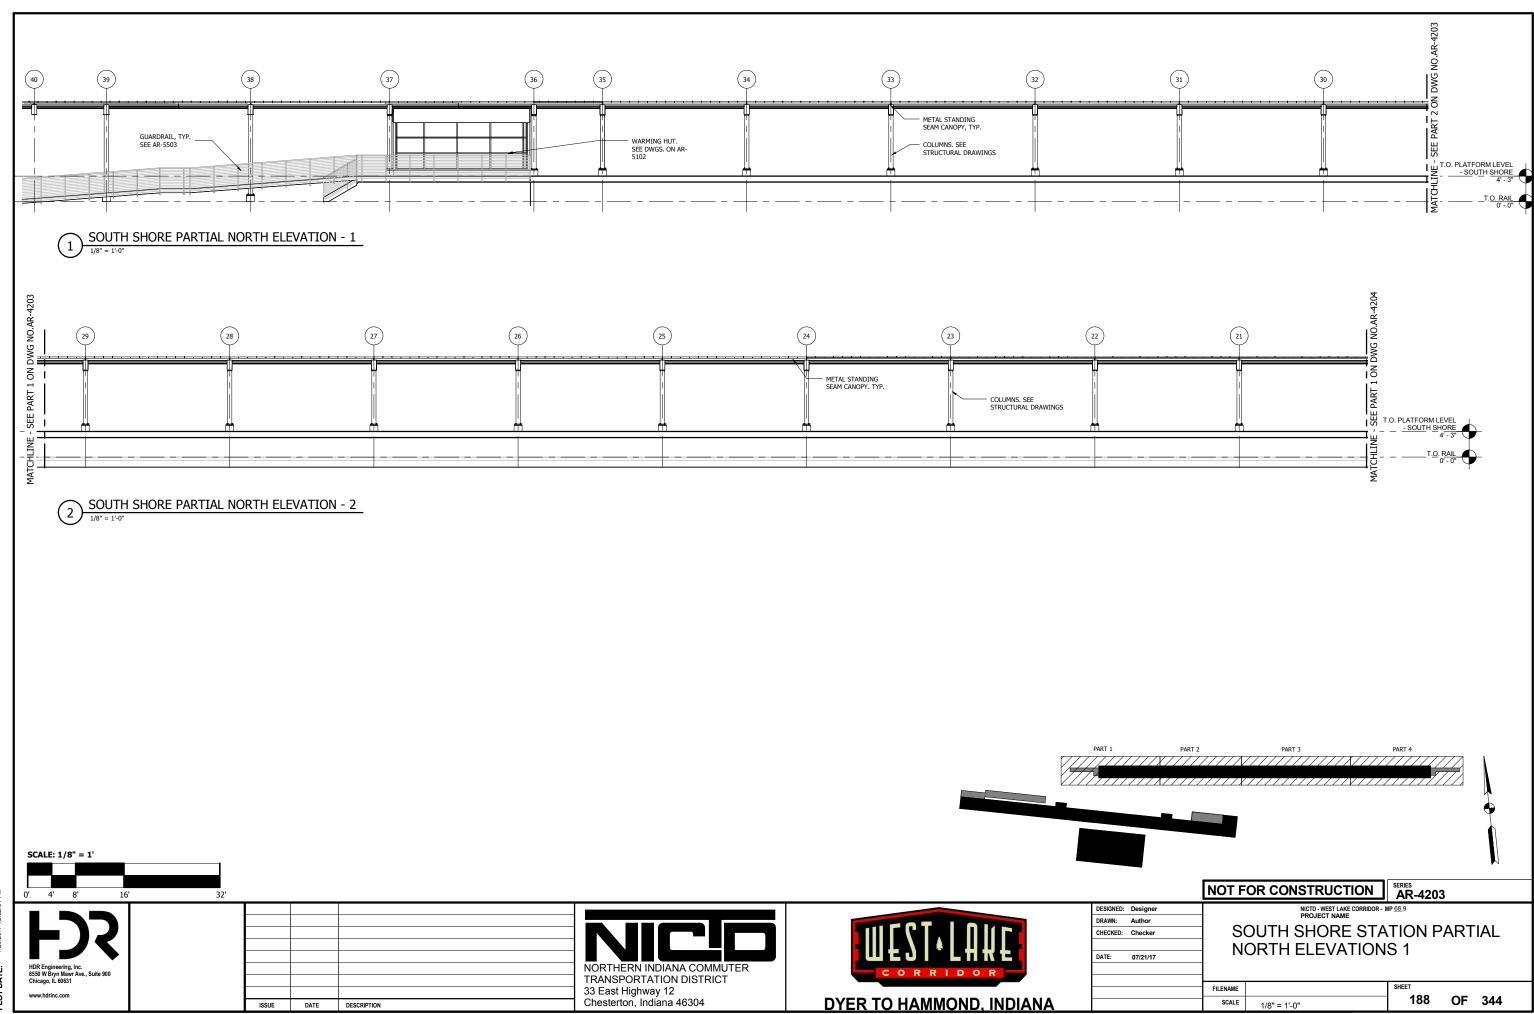
SOUTH SHORE PARTIAL SOUTH ELEVATION - 4

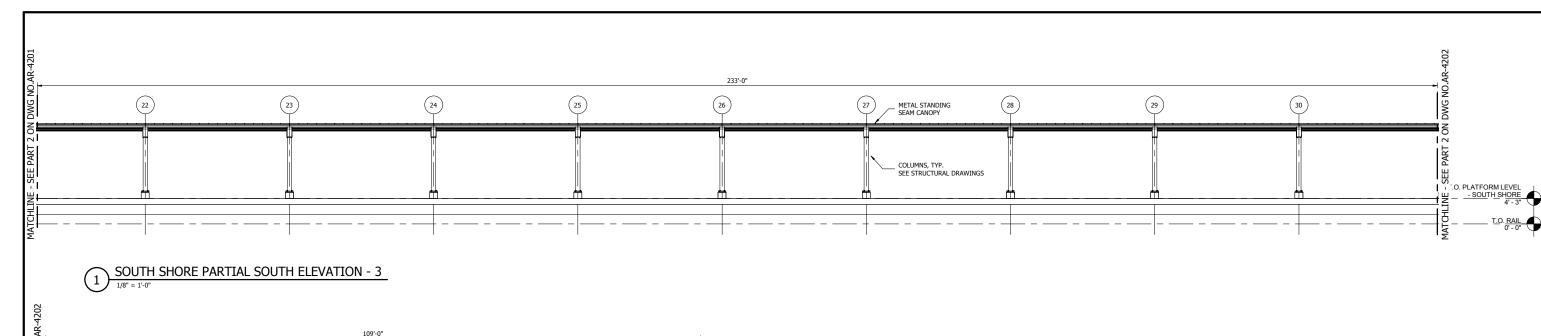ISSUE DATE DESCRIPTION






	NOT F	OR CONSTRUCTION	AR-4202	2			
DESIGNED: Designer		NICTD - WEST LAKE CORRIDOR - PROJECT NAME	MP <u>69.</u> 0				
DRAWN: Author CHECKED: Checker	-	SOUTH SHORE STATION PARTIAL					
DATE: 07/21/17	5	SOUTH ELEVATIONS 2					
	FILENAME		SHEET				
	SCALE	1/0" - 1' 0"	187	OF 361			



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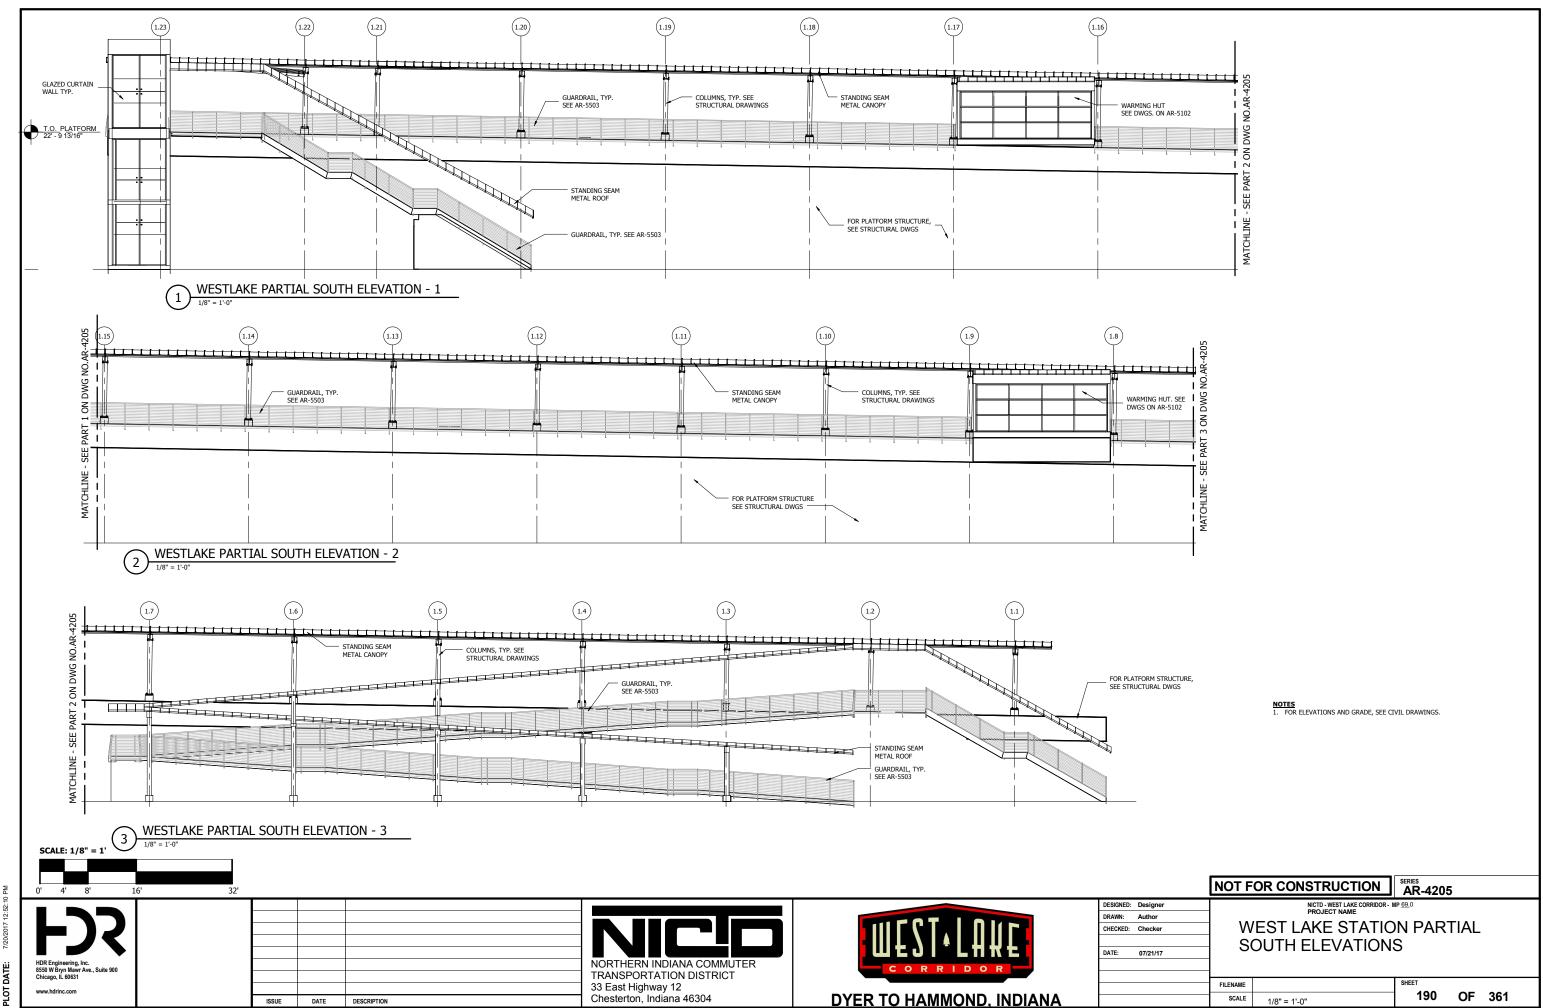
HDR Engineering, Inc. 8550 W Bryn Mawr Ave., Suite 900 Chicago, IL 60631 www.hdrinc.com

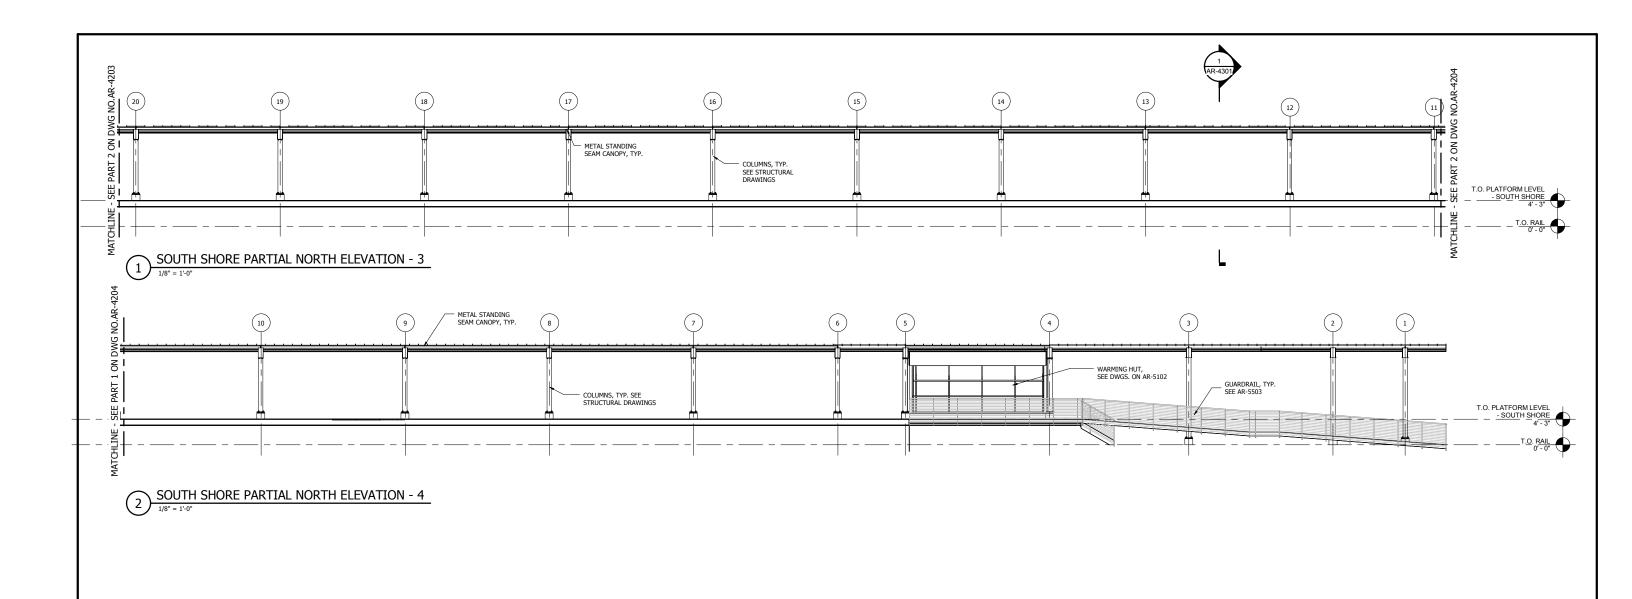NORTHERN INDIANA COMMUTER TRANSPORTATION DISTRICT 33 East Highway 12 Chesterton, Indiana 46304





		NOT F	OR CONSTRUCTION	AR-4204	Į.			
DESIGNED:	Designer		NICTD - WEST LAKE CORRIDOR - I	MP <u>68.</u> 9				
DRAWN:	Author	_						
CHECKED:	Checker	S	SOUTH SHORE STATION PARTIAL					
		NORTH ELEVATIONS 2						
DATE:	07/21/17	IN	NORTH ELEVATIONS 2					
		FILENAME		SHEET				
		SCALE	1/8" = 1'-0"	189	OF	344		

ISSUE DATE DESCRIPTION




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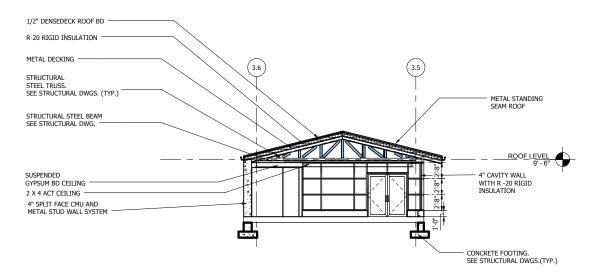


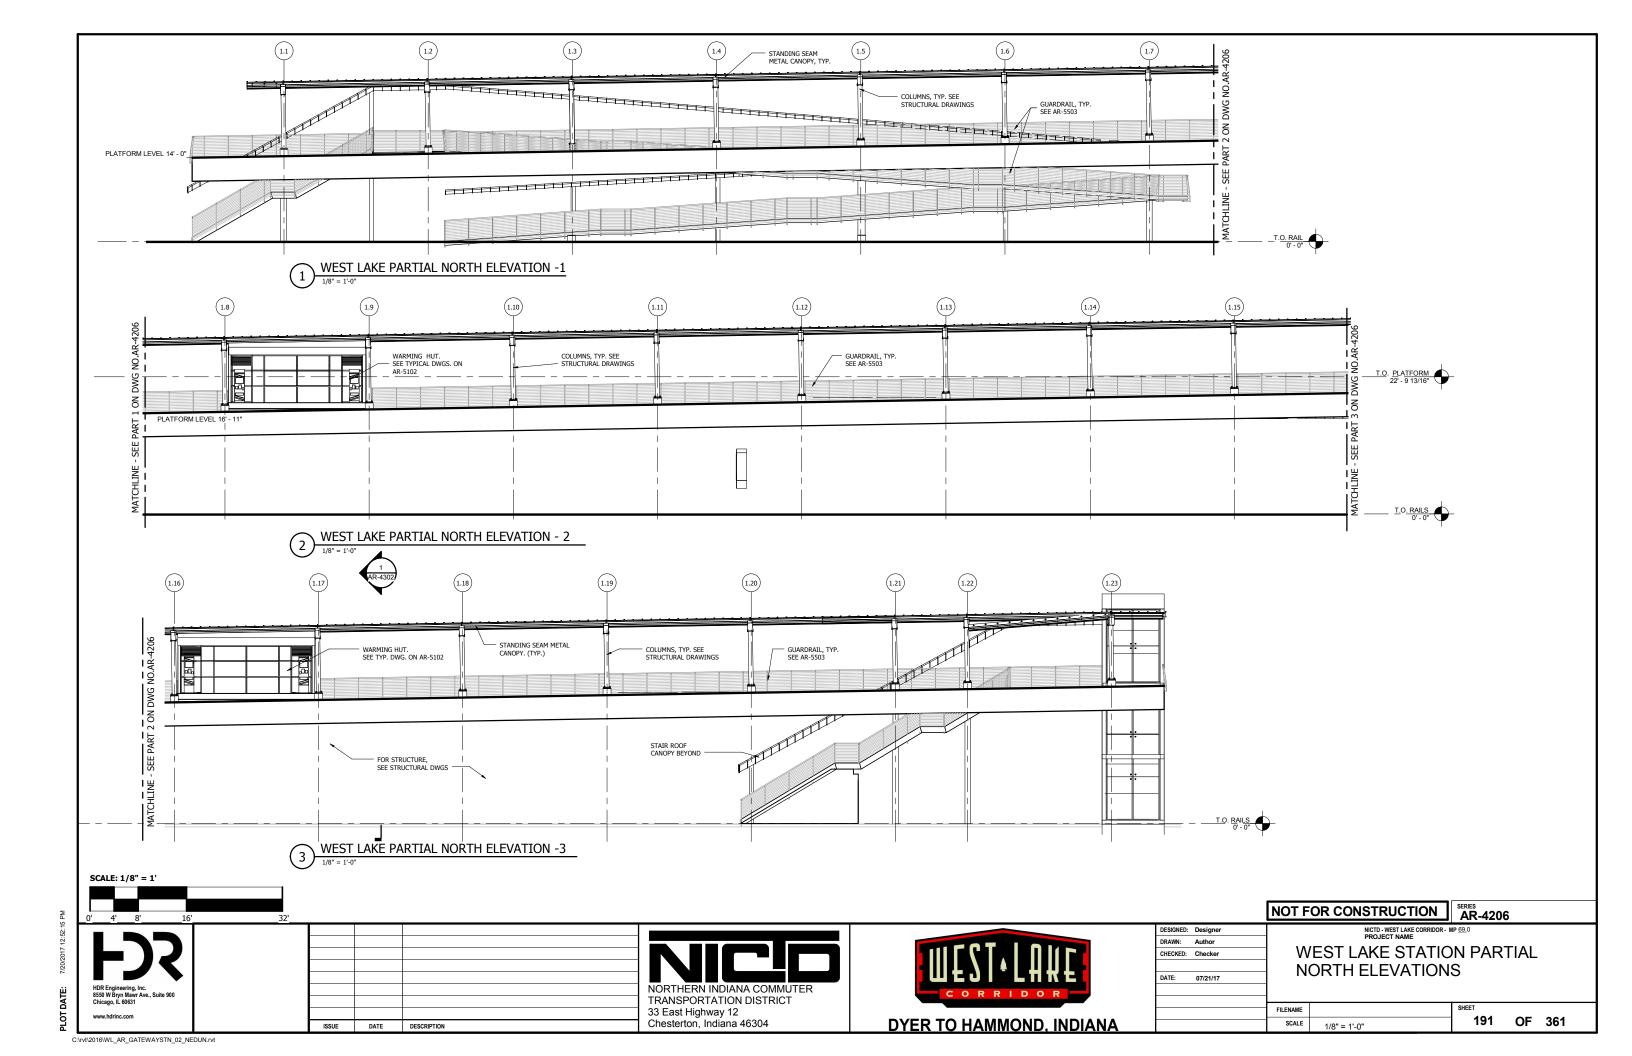

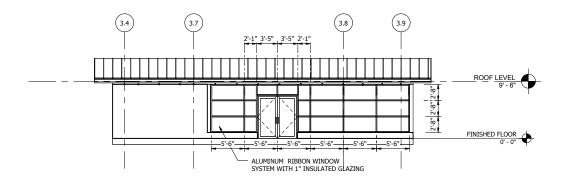STATION BUILDING NORTH ELEVATION

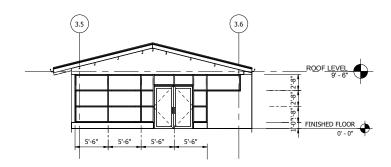


STATION BUILDING EAST ELEVATION 1/8" = 1'-0"




ISSUE DATE DESCRIPTION

4 CROSS SECTION THROUGH WAITING AREA

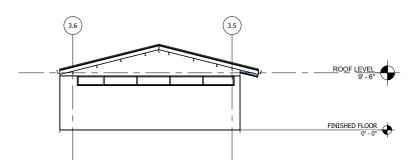


STATION BUILDING WEST ELEVATION

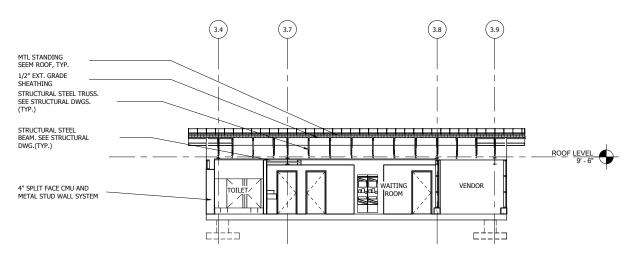

5 LONGITUDINAL SECTION

1/8" = 1'-0"

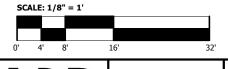


HDR Engineering, Inc. 8550 W Bryn Mawr Ave., Suite 900 Chicago, IL 60631 www.hdrinc.com NORTH TRANSF 33 East Chesteri





	NOT F	OR CONSTRUCTION	AR-4207	7	
DESIGNED: Designer DRAWN: Author CHECKED: Checker DATE: 07/21/17	_	NICTO-WEST LAKE CORRIDOR - I PROJECT NAME TATION HOUSE EL ECTIONS		ONS	&
	FILENAME		SHEET		
	SCALE	1/8" = 1'-0"	192	OF	361

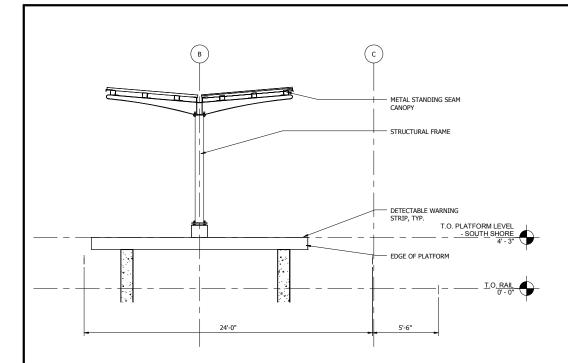

SOUTH SHORE CROSS SECTION

1/4" = 1'-0"

NOTES

1. FOR ELEVATIONS AND GRADE, SEE CIVIL DRAWINGS.



S559 W Bhy...
Chicago, IL 90831

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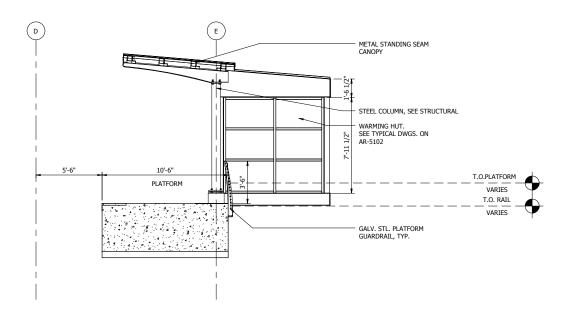
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ISSUE DATE DESCRIPTION





	NOT F	OR CONSTRUCTION	AR-430	1			
DESIGNED: Designer DRAWN: Author CHECKED: Checker	P	NICTD - WEST LAKE CORRIDOR - 1 PROJECT NAME LATFORM CROSS-		A NC	 Т		
DATE: 07/21/17	S	SOUTH SHORE PLATFORM					
	FILENAME	1/4" = 1'-0"	193	OF	344		



 $\underbrace{ 1 }_{1/4"=1"\cdot 0"} \underbrace{ \text{WEST LAKE STATION CROSS SECTION} }_{1/4"=1"\cdot 0"}$

NOTES

1. FOR ELEVATIONS AND GRADE, SEE CIVIL DRAWINGS.



S559 W Bhy...
Chicago, IL 90831


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ISSUE DATE DESCRIPTION




	NOT F	OR CONSTRUCTION	AR-4302	2		
DESIGNED: Designer		NICTD - WEST LAKE CORRIDOR - I	MP <u>69.</u> 0			
DRAWN: Author					_	
CHECKED: Checker	Р	PLATFORM CROSS-SECTION AT				
	WESTLAKE STATION SECTIONS					
DATE: 07/21/17	WESTLAKE STATION SECTIONS					
	FILENAME		SHEET			
	SCALE	1/4" = 1'-0"	194	OF	361	



3;38;12 PM JKJELLMA

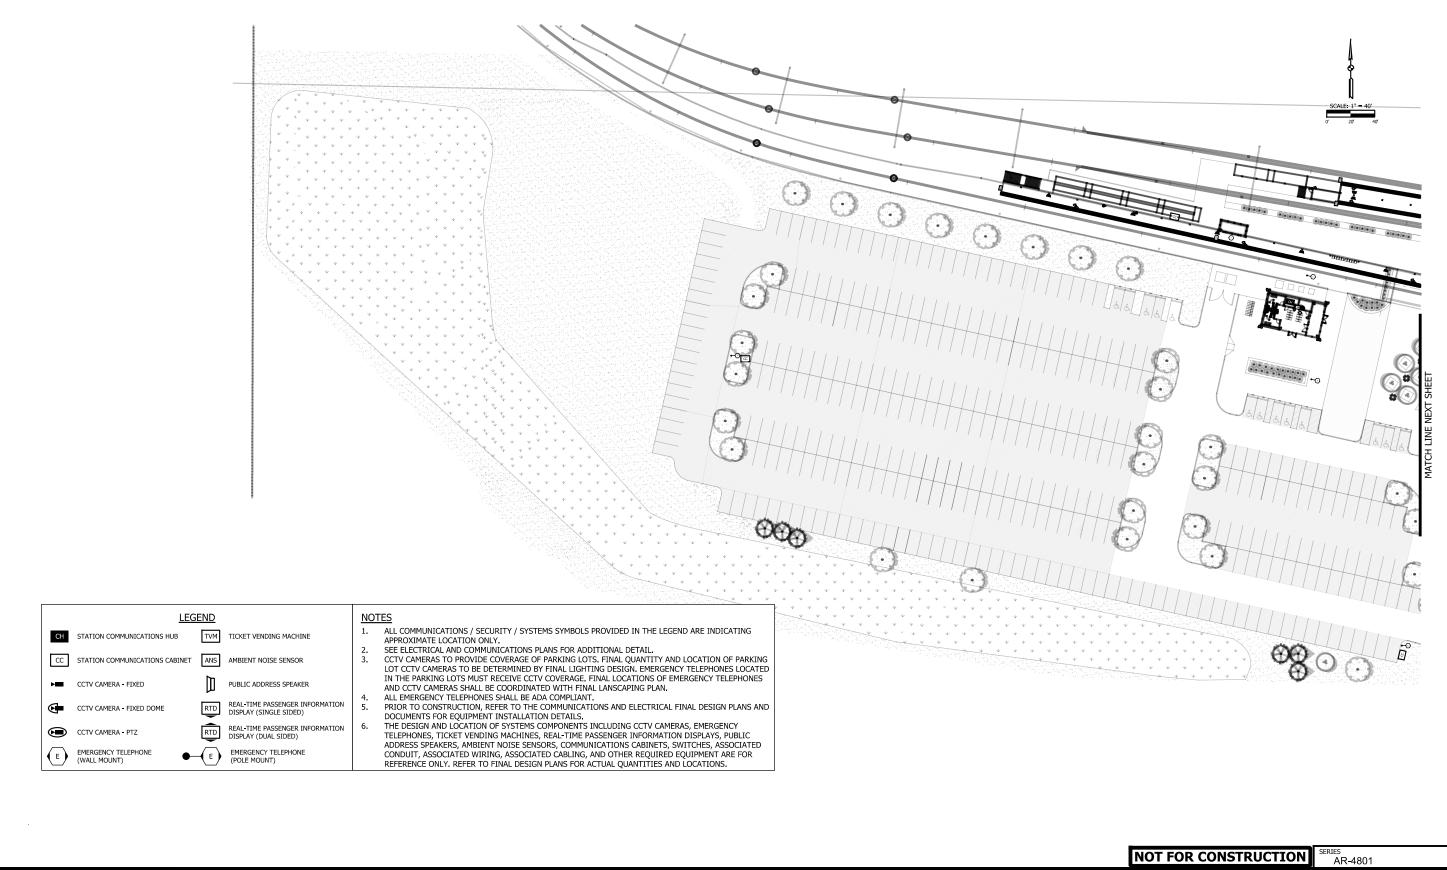


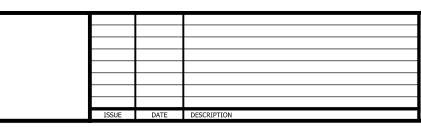






			OK CONSTRUCTION	AR-4	801	
DESIGNED:	T. HILES		NICTD - WEST LAKE CORRIDOR - M		WL 69.18	
DRAWN:	J. MERSEREAU		SINGLE TRA	CK		
CHECKED:	S. WICKS					
			PARKING SYST		OL A N	1 1
DATE:	07/21/17				LAN	I I
			STATIO	NC		
		FILENAME	SHT_WL_TE_HG_PL_01.dgn	SHEET		
		SCALE	AS NOTED	195	OF	361

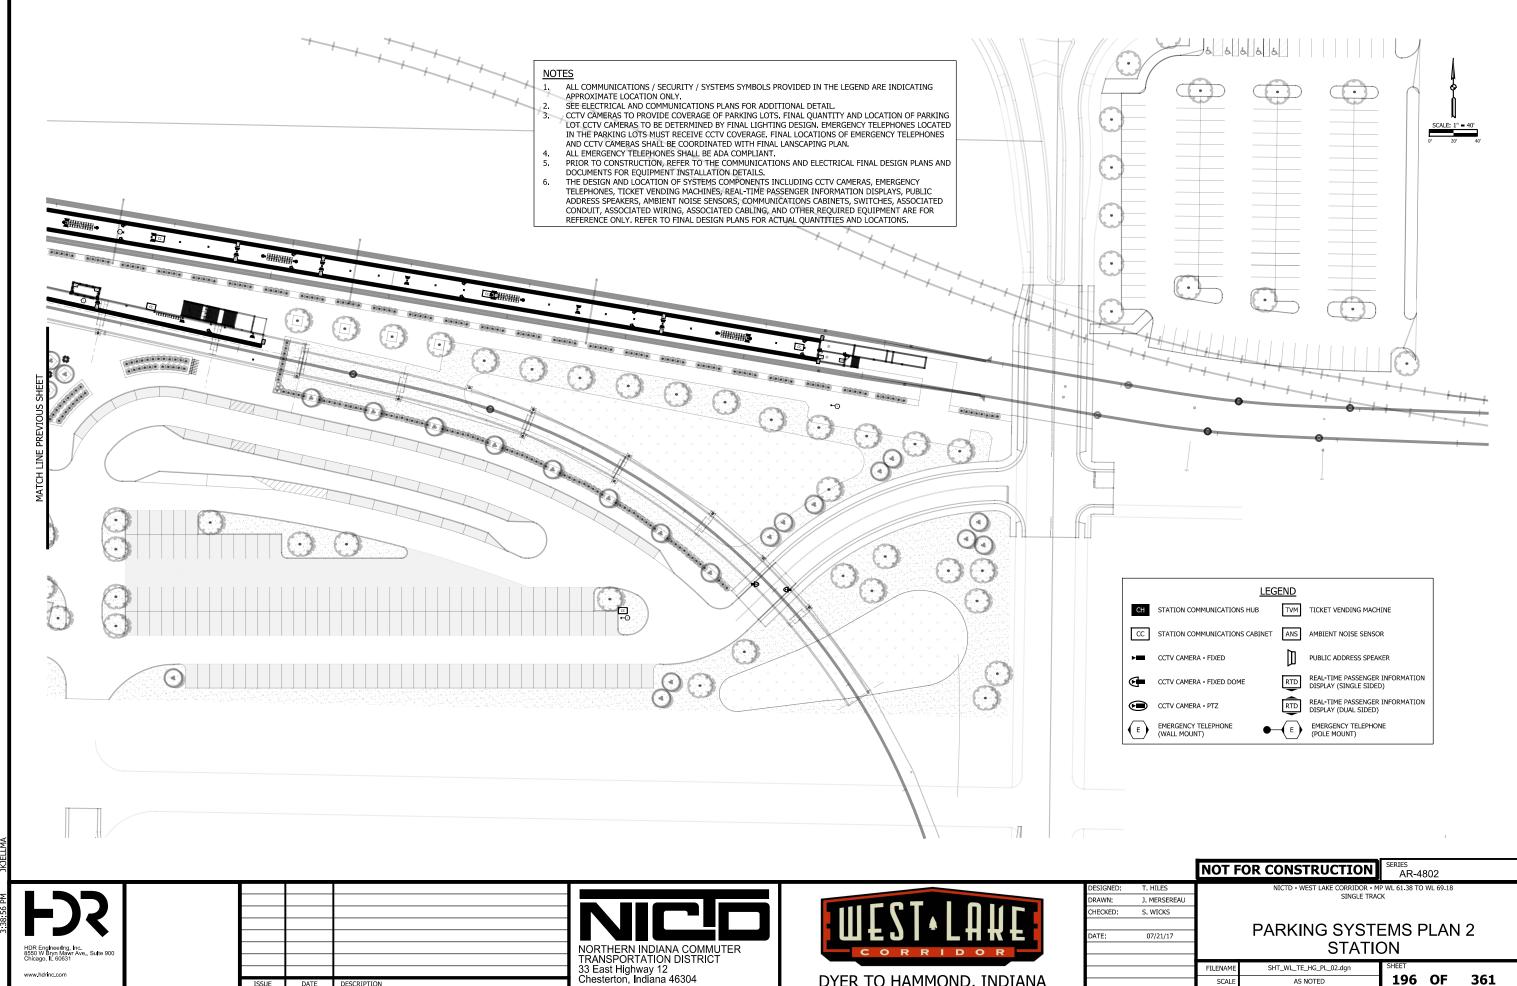


DYER TO HAMMOND, INDIANA

196 OF 361

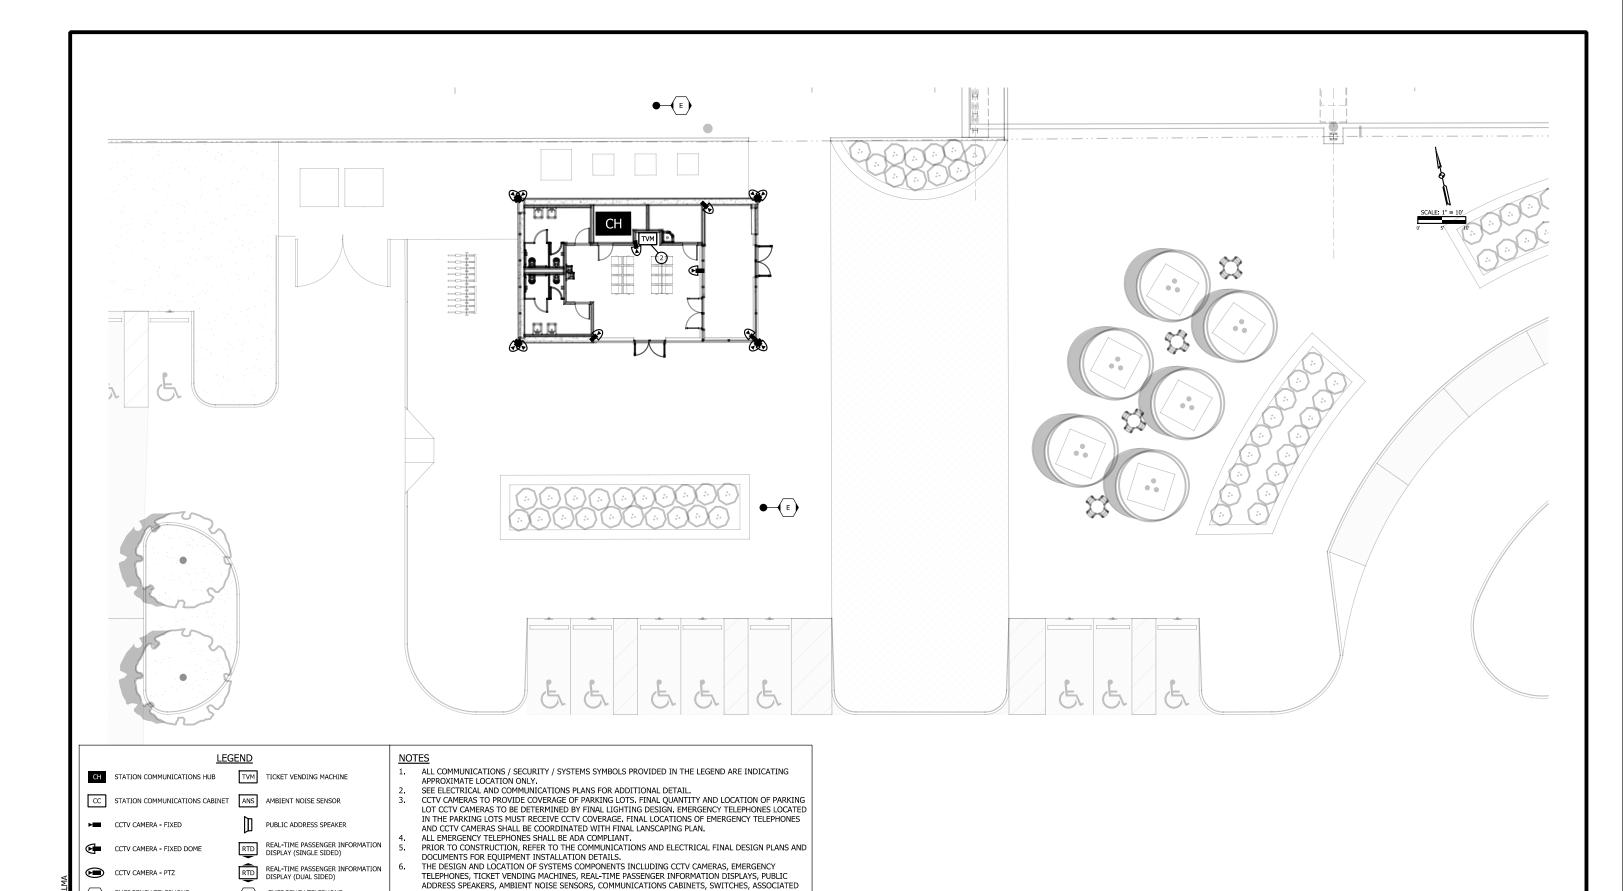



E EMERGENCY TELEPHONE (POLE MOUNT)

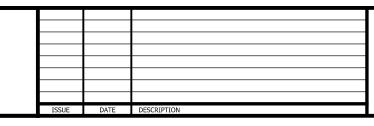

NORTHERN INDIANA COMMUTER TRANSPORTATION DISTRICT 33 East Highway 12 Chesterton, Indiana 46304

CONDUIT, ASSOCIATED WIRING, ASSOCIATED CABLING, AND OTHER REQUIRED EQUIPMENT ARE FOR

REFERENCE ONLY. REFER TO FINAL DESIGN PLANS FOR ACTUAL QUANTITIES AND LOCATIONS.




DESIGNED:	T. HILES			NICTE) - WEST		RRIDOR - N
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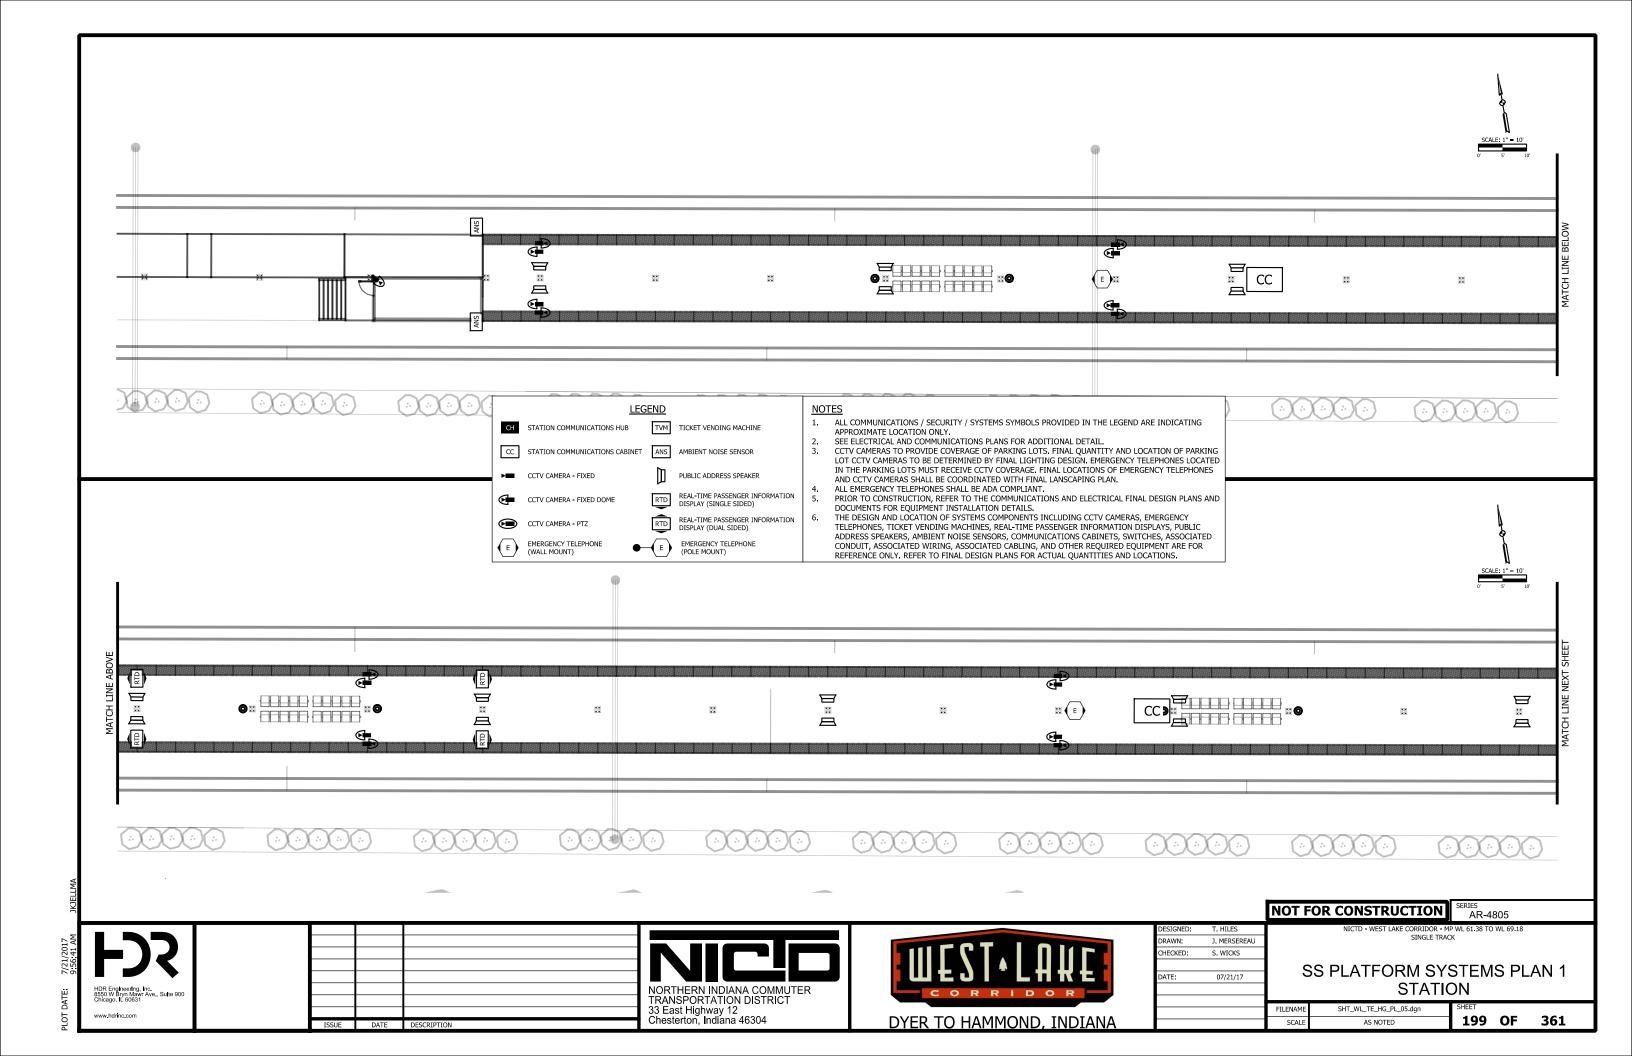
NOT FOR CONSTRUCTION


SYSTEMS PLAN ION


197 OF 361

AR-4803



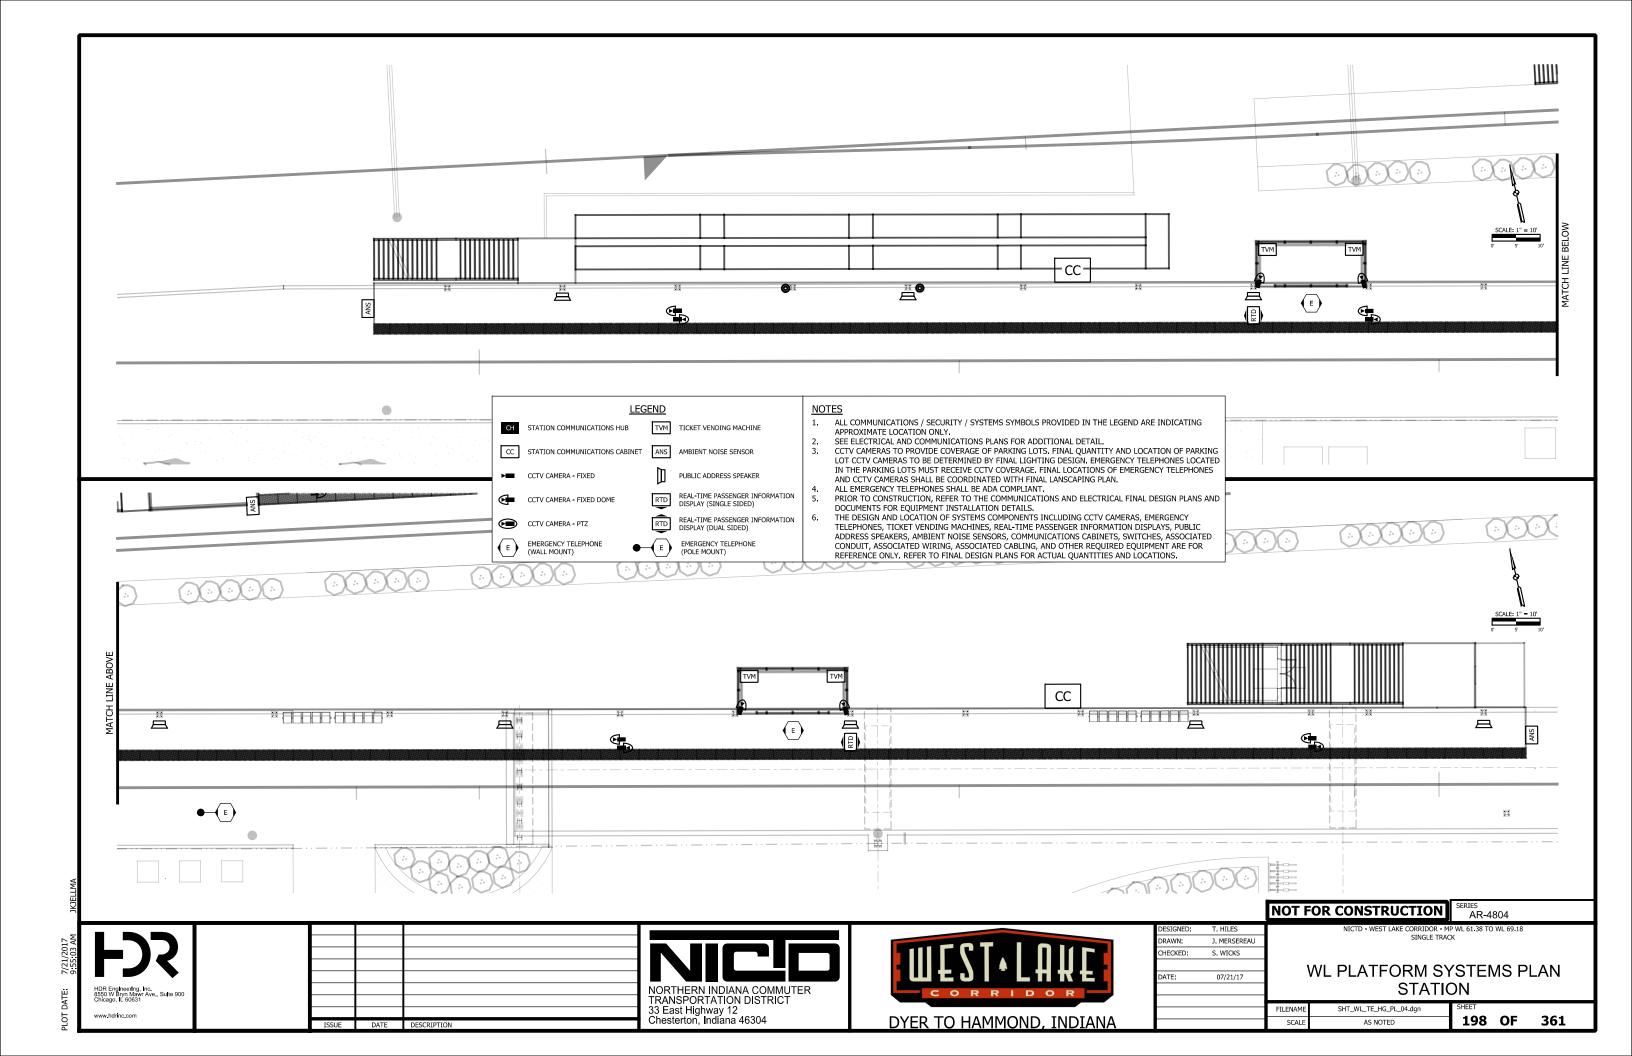

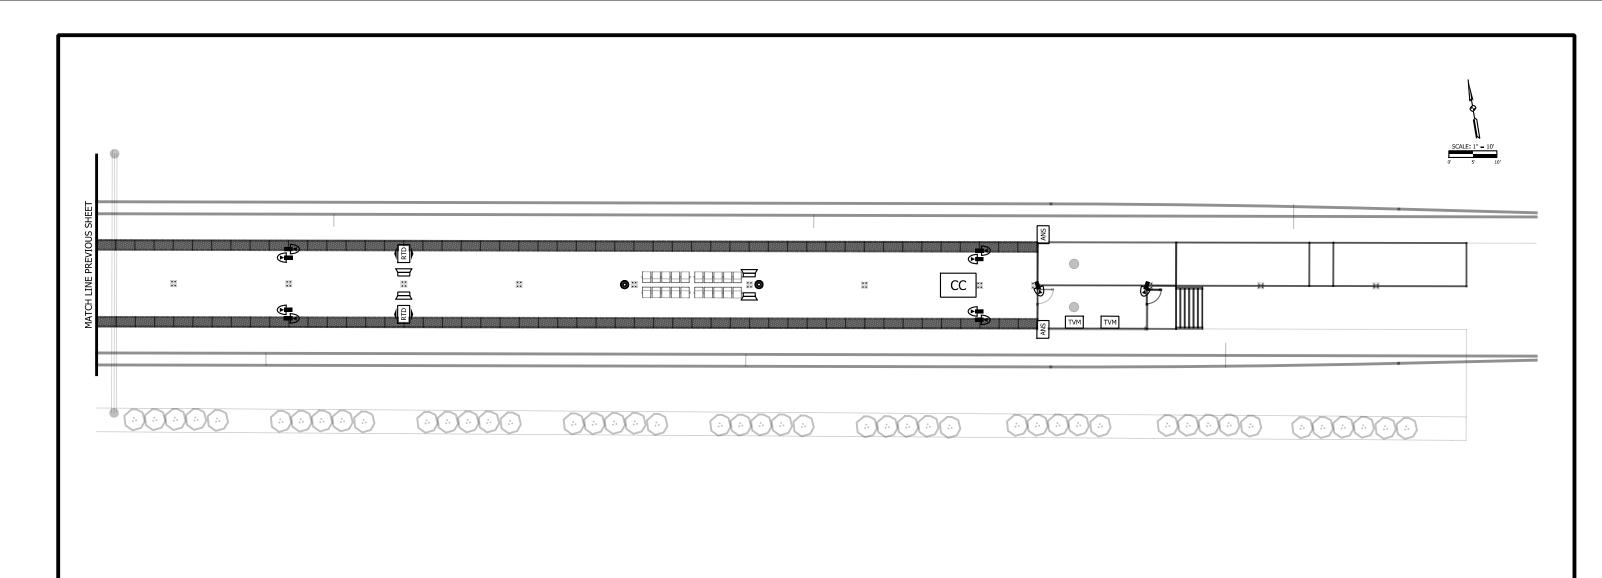

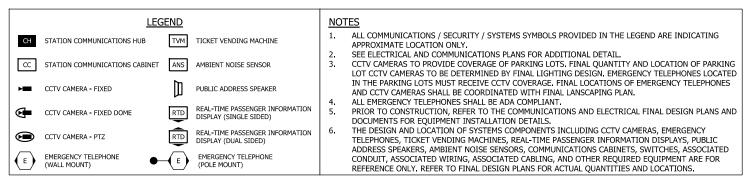

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NORTHERN INDIANA COMMUTER TRANSPORTATION DISTRICT 33 East Highway 12 Chesterton, Indiana 46304




		N
DESIGNED:	T. HILES	
DRAWN:	J. MERSEREAU	
CHECKED:	S. WICKS	
DATE:	07/21/17	

NOT FOR CONSTRUCTION SERIES AR-4806 NICTD - WEST LAKE CORRIDOR - MP WL 61.38 TO WL 69.18 SINGLE TRACK


SS PLATFORM SYSTEMS PLAN 2 NOITATS

	STATE	אוכ	
FILENAME	SHT_WL_TE_HG_PL_06.dgn	SHEET	
	=		_


200 OF 361 AS NOTED

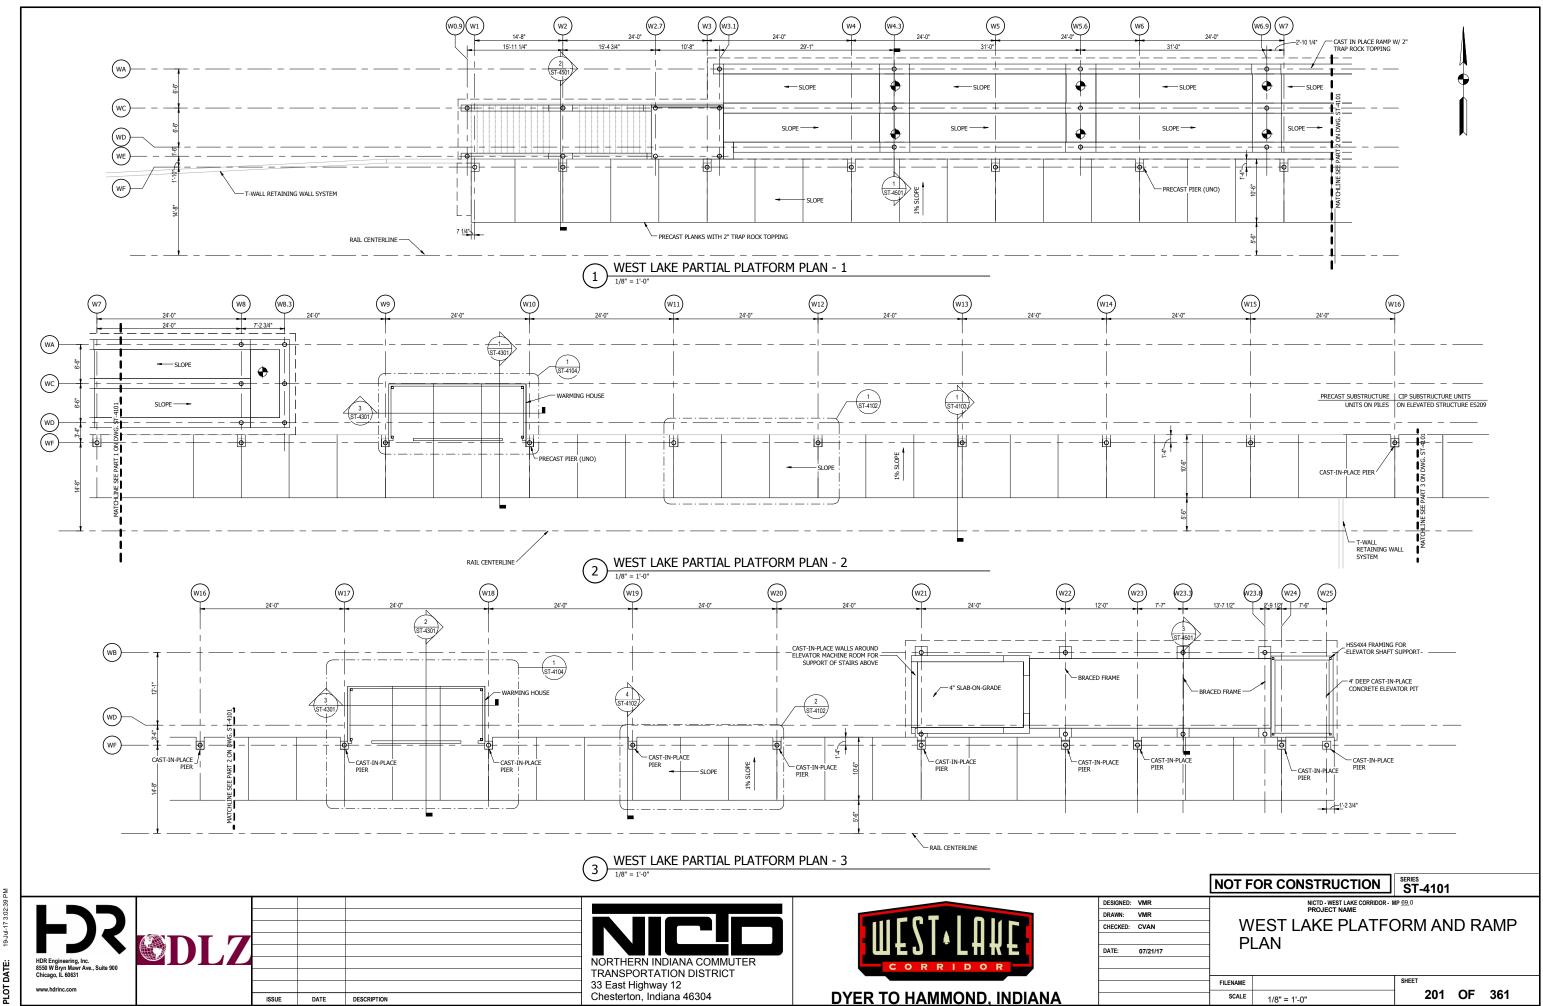

OH DATE: 40 1:4 47 0:00

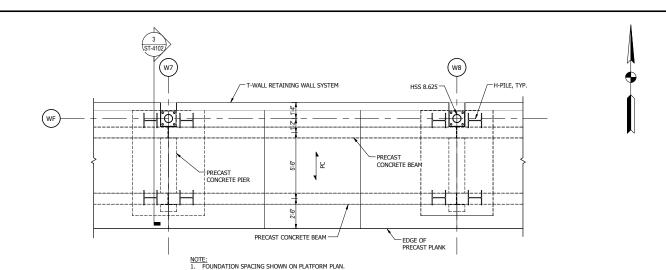

TYPICAL PLATFORM FRAMING AT T-WALL

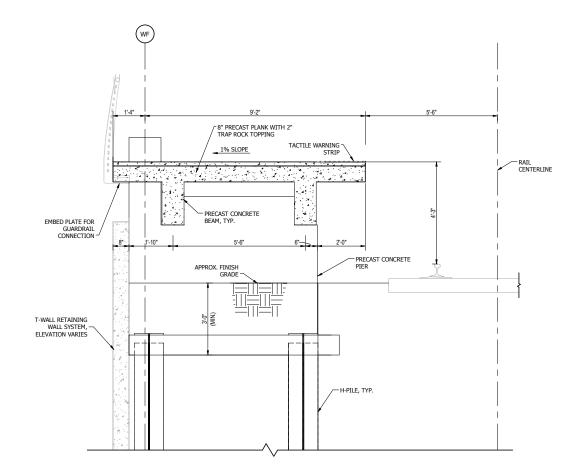


NOTES:

1. PROVIDE ELECTRICAL HEATING MAT INTEGRAL IN PRECAST PLANKS.
2. STEEL COLUMN AND CANOPY NOT SHOWN FOR CLARITY.

ISSUE DATE DESCRIPTION


TYPICAL PLATFORM SECTION AT T-WALL

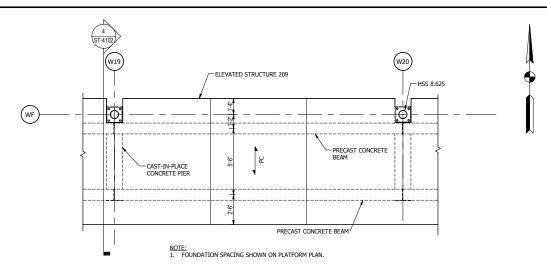

TYPICAL PLATFORM FRAMING AT ELEVATED

STRUCTURE

1/4" = 1'-0"

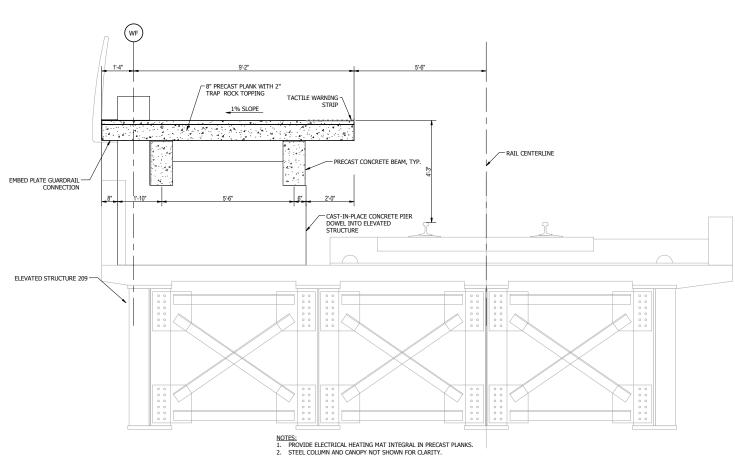



TYPICAL PLATFORM SECTION AT ELEVATED

4 STRUCTURE



	NOT F	OR CONSTRUCTION	SERIES ST-4	4102			
DESIGNED: VMR DRAWN: VMR CHECKED: CVAN DATE: 07/21/17	1	NICTO - WEST LAKE CORRIDOR - I PROJECT NAME VEST LAKE PLATFO LAN		FR	AMI	NG	
	FILENAME		SHEET				
	SCALE	As indicated		202	OF	361	

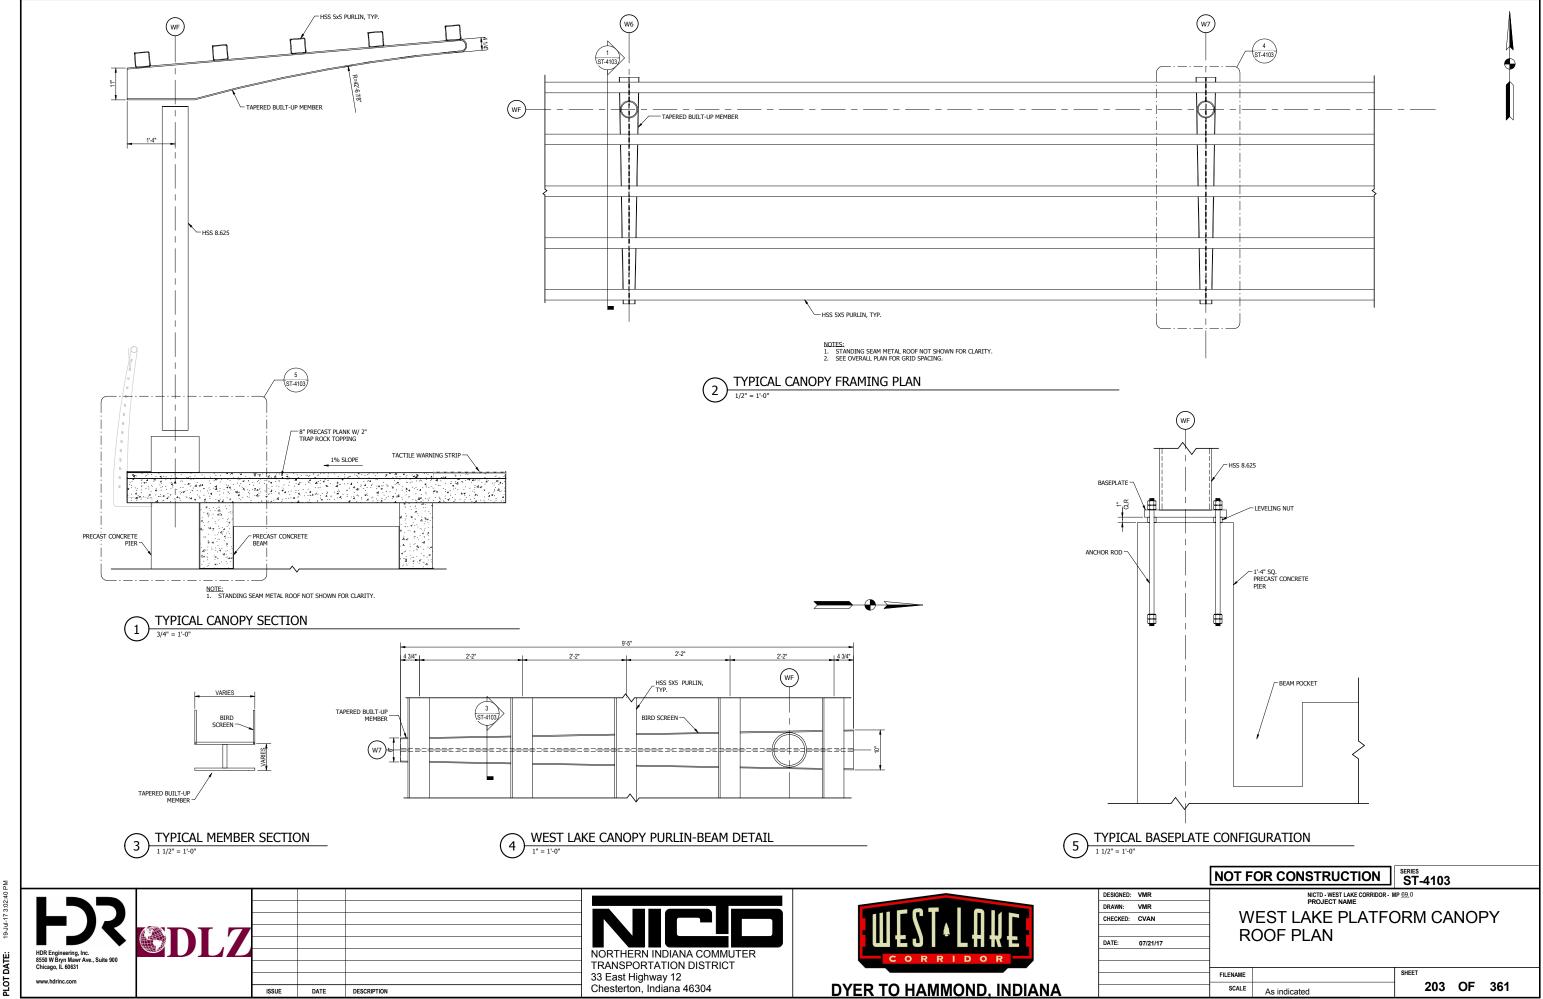

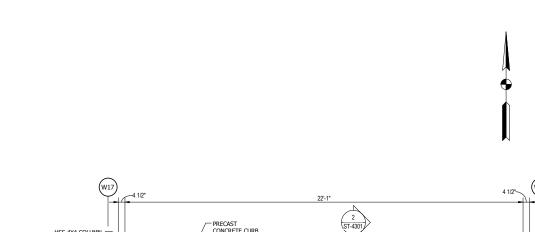

HSS 404 COLUMN,
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CAST-IN-PLACE
CONCRETE CURB, TYP

CAST-IN-PLACE
CONCRETE CURB, TYP


CONCRETE CURB, TYP

CONCRETE PIRC ON
CO

NOTE:

1. SEE ST-4102 FOR TYPICAL PLATFORM FRAMING AND FOUNDATION.

TYPICAL WARMING HOUSE SLAB PLAN
3/8" = 1'-0"

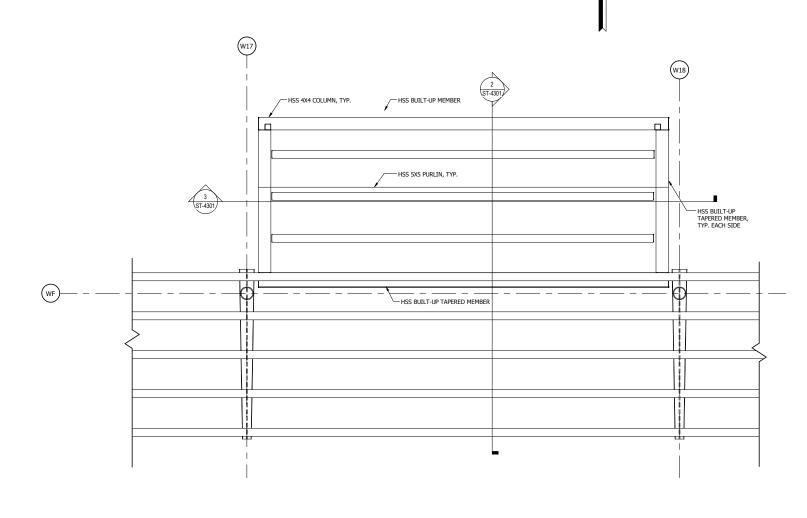


NOTES:

1. STANDING SEAM METAL ROOF NOT SHOWN FOR CLARITY.


2. SEE PLATFORM PLAN FOR GRID SPACING.

2 TYPICAL WARMING HOUSE ROOF FRAMING PLAN
3/8" = 1'-0"

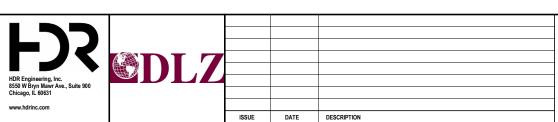




	NOT F	OR CONSTRUCTION	SERIES	-4104		
DESIGNED: VMR		NICTD - WEST LAKE CORRIDOR PROJECT NAME	- MP <u>69.</u> 0			
DRAWN: VMR						
CHECKED: CVAN	¬ W	/EST LAKE WARM	IING	HO	JSE	
	_ D	LAN				
DATE: 07/21/17		LAN				
	FILENAME		SHEET			
	SCALE	3/8" = 1'-0"		204	OF	361

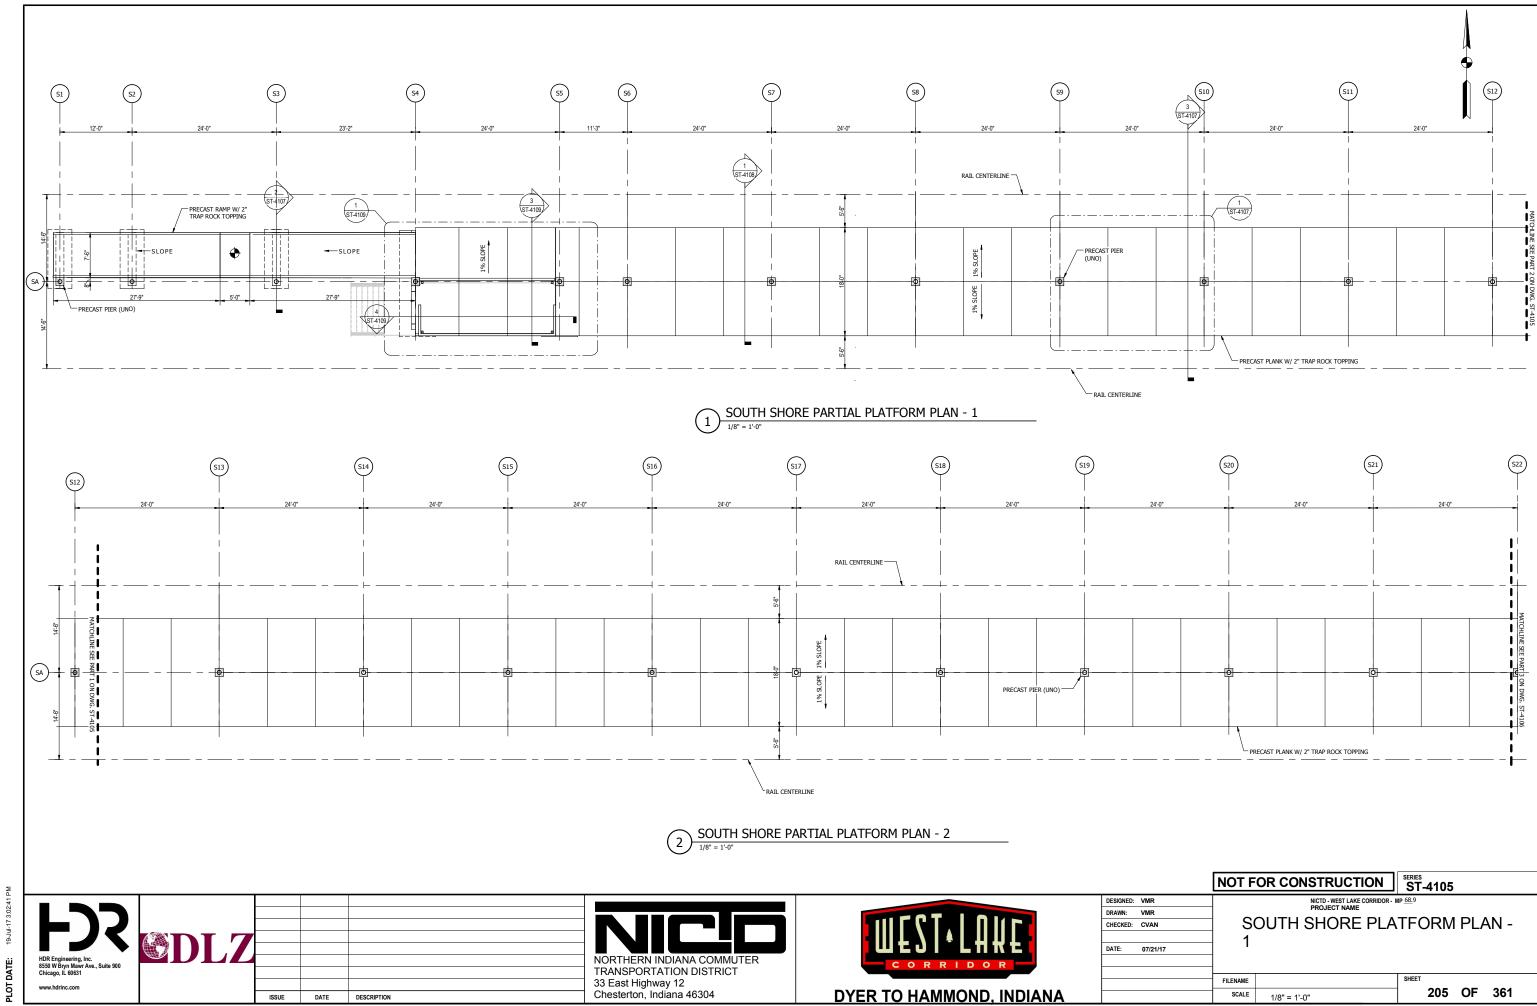


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PLOT DATE: 19-Jul-17 3:02:42 F

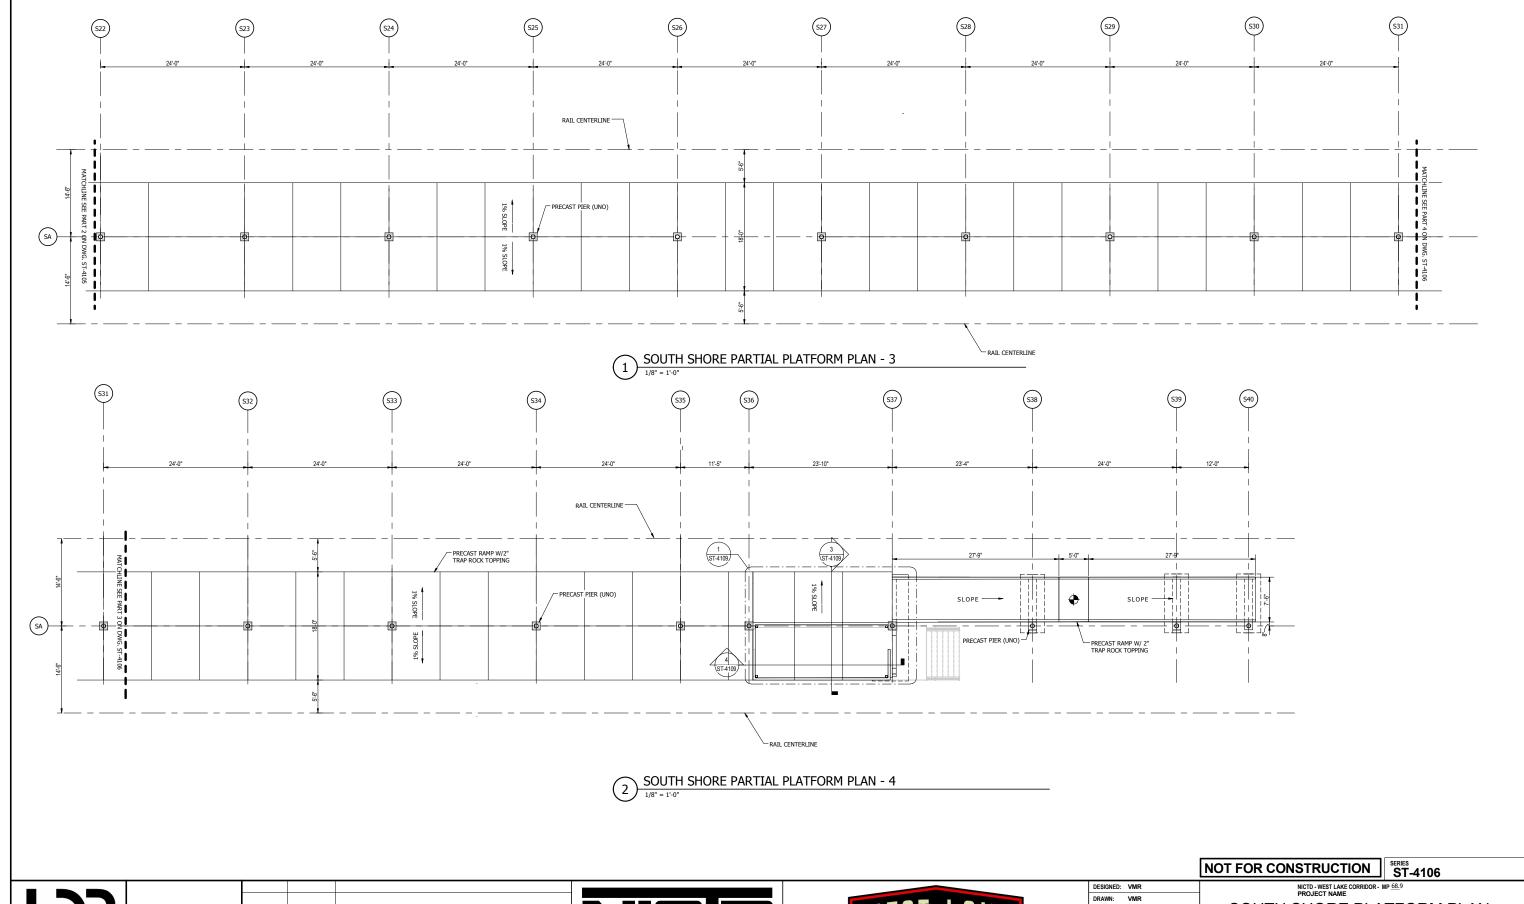

	NOT F	OR CONSTRUCTION	ST-4106	;	
DESIGNED: VMR		NICTD - WEST LAKE CORRIDOR - I	MP <u>68.</u> 9		
DRAWN: VMR					
CHECKED: CVAN	S	OUTH SHORE PLA	TFORM	1 PLAN -	
	2				
DATE: 07/21/17					
	FILENAME		SHEET		
	SCALE	1/8" - 1' 0"	206	OF 361	



TRANSPORTATION DISTRICT 33 East Highway 12 Chesterton, Indiana 46304
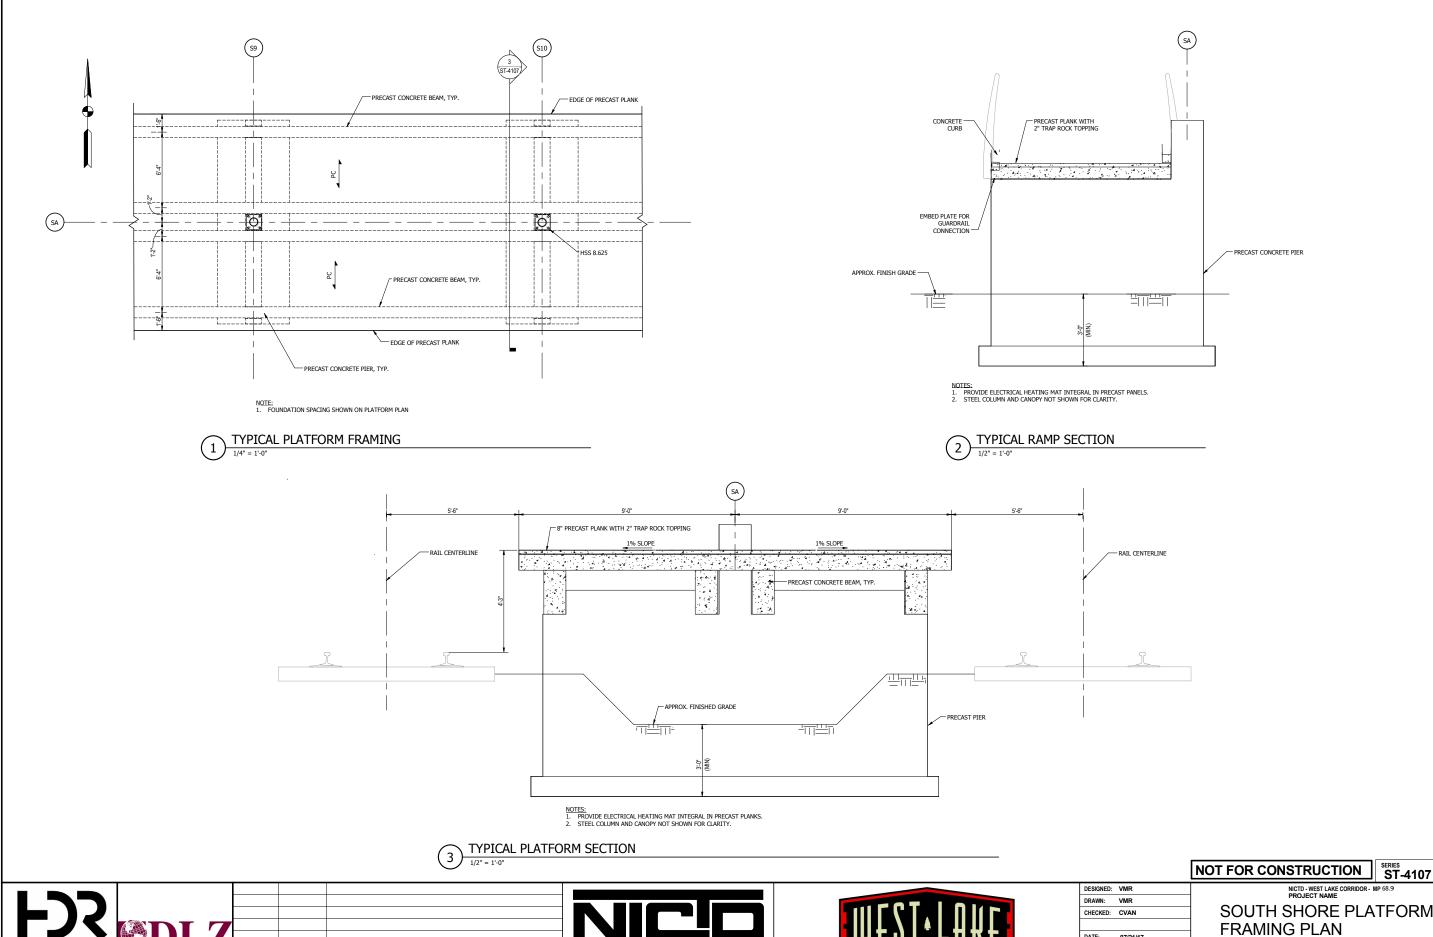
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ISSUE DATE DESCRIPTION

DYER TO HAMMOND, INDIANA


DATE: 07/21/17


SOUTH SHORE PLATFORM

SCALE

FILENAME

207 OF 361 As indicated

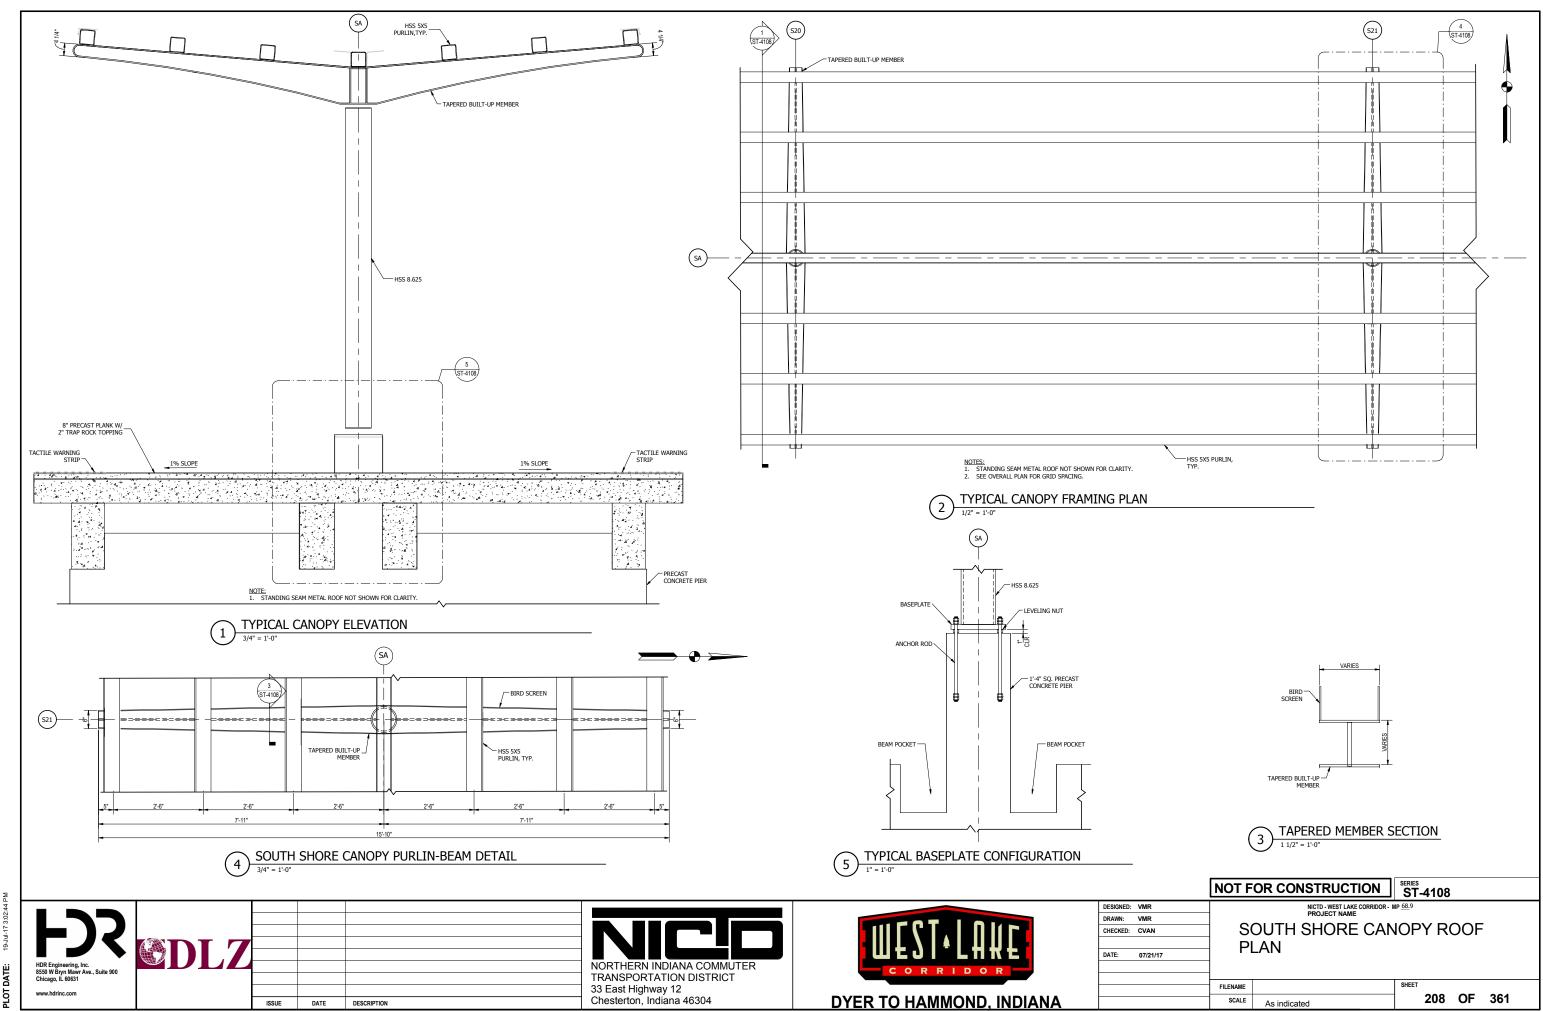


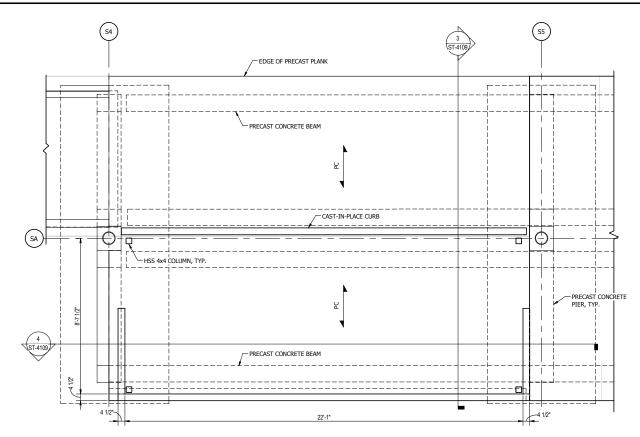

NOTE:


1. SEE PLATFORM FRAMING PLAN FOR TYPICAL GRID SPACING.

TYPICAL WARMING HOUSE FRAMING PLAN

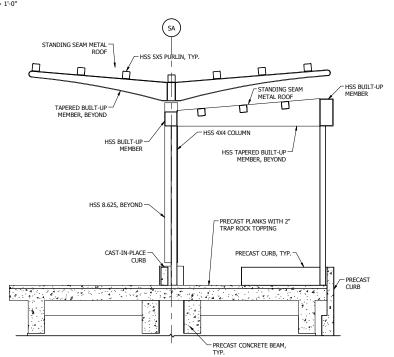


TYPICAL WARMING HOUSE SECTION


3/8" = 1'-0"

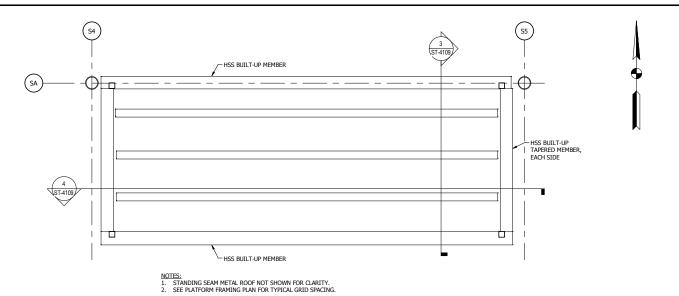

TYPICAL WARMING HOUSE FRAMING PLAN
3/8" = 1'-0"

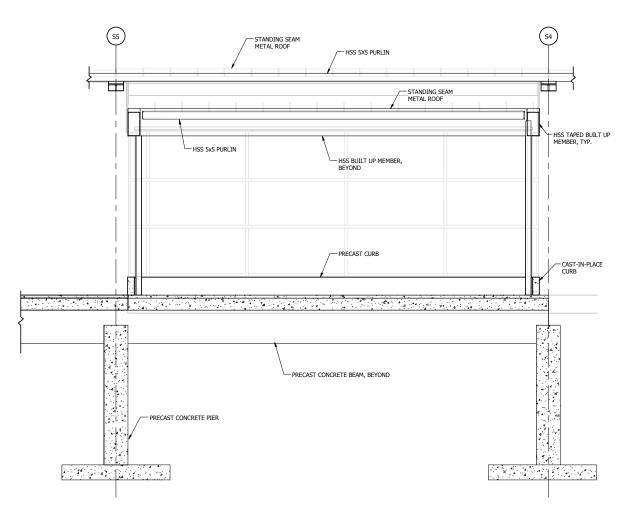


TYPICAL WARMING HOUSE SECTION

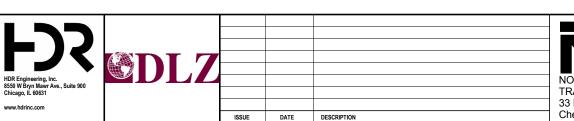



	NOT F	OR CONSTRUCTION	SERIES ST-410	9	
DESIGNED: VMR		NICTD - WEST LAKE CORRIDOR - I	MP <u>68.</u> 9		
DRAWN: VMR	l _				
CHECKED: CVAN] So	SOUTH SHORE WARMING HOUSE			
		LAN			
DATE: 07/21/17	1 PI	LAIN			
	FILENAME		SHEET		
	SCALE	3/8" = 1'-0"	209	OF	361



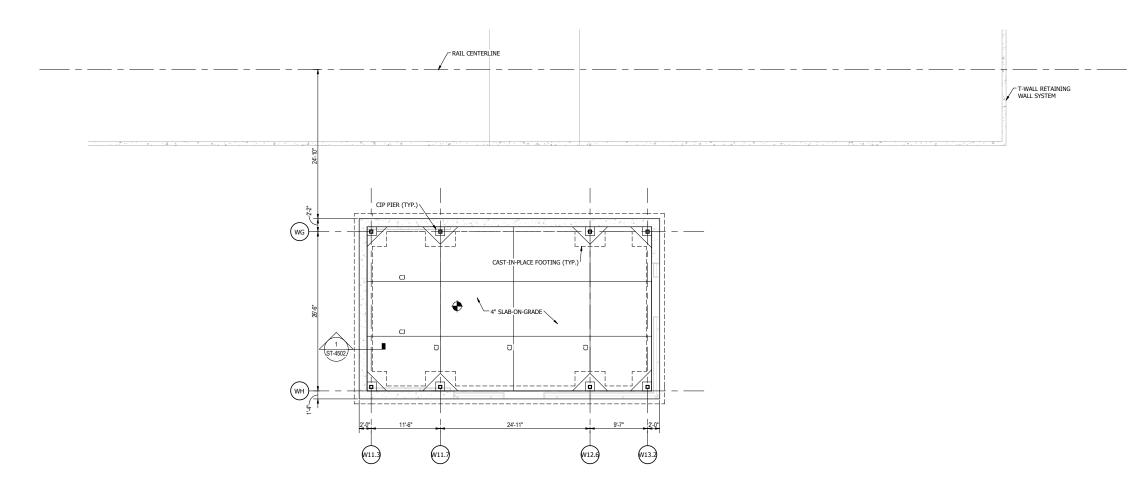

STATION HOUSE FOUNDATION PLAN

1/8" = 1"-0"

HDR Engineering, Inc.
8550 W Bryn Mawr Ave., Suite 900
Chicago, I. 60631
www.hdrinc.com

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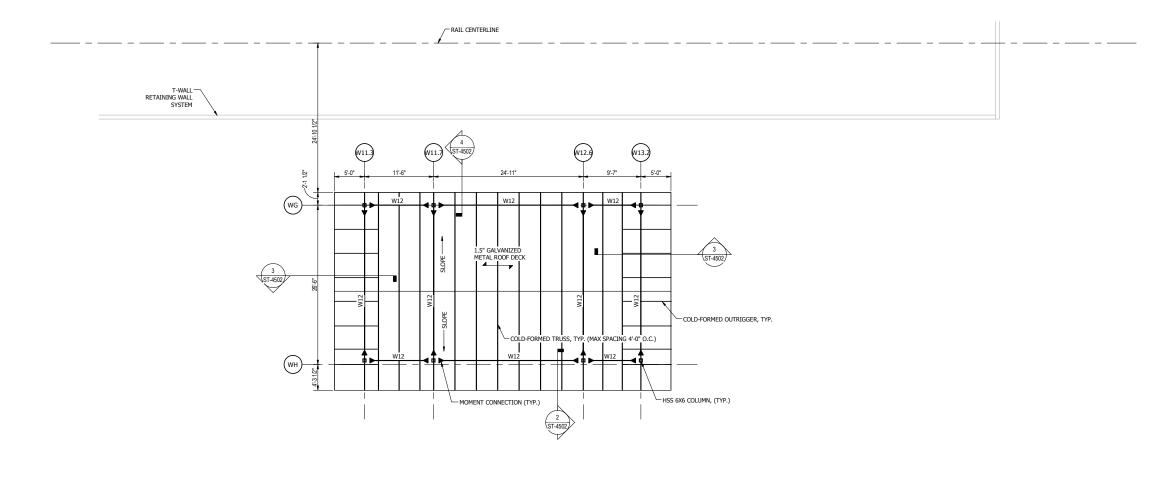
		NOT F	OR CONSTRUCTION	ST-4110
DESIGNED:	VMR		NICTD - WEST LAKE CORRIDOR - N PROJECT NAME	IP <u>69.</u> 0
DRAWN:	VMR	_	***************************************	
CHECKED:	CVAN	G/	ATEWAY STATION	HOUSE
			DUNDATION PLAN	
DATE:	07/21/17		JUNDATION FLAIN	
				AUEST.

1/8" = 1'-0"

SCALE

210 OF 361





STATION HOUSE ROOF PLAN

1/8" = 1'-0"


HDR Engineering, Inc.
8550 W Bryn Mawr Ave., Suite 900
Chicago, IL 60631

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ISSUE DATE DESCRIPTION




	NOT F	OR CONSTRUCTION	SERIES	-4111			
DESIGNED: VMR		NICTD - WEST LAKE CORRIDOR - I	MP <u>69.</u> 0				
DRAWN: VMR	_			_	_	_	
CHECKED: CVAN	G	GATEWAY STATION HOUSE ROOF					
		LANI					
DATE: 07/21/17		LAN					
	FILENAME		SHEET				
	SCALE	1/8" - 1' 0"		211	OF	361	

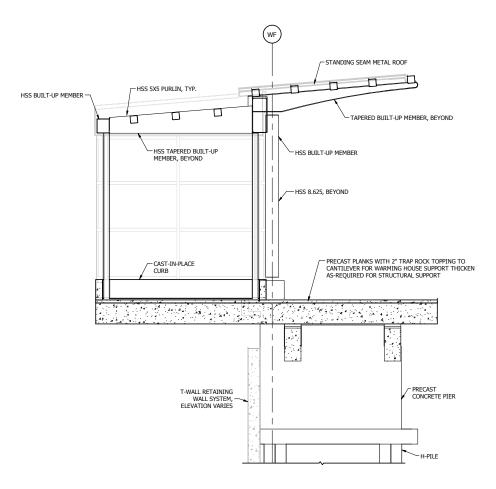

SECTION THROUGH WARMING HOUSE AT T-WALL


3/8" = 1'-0"

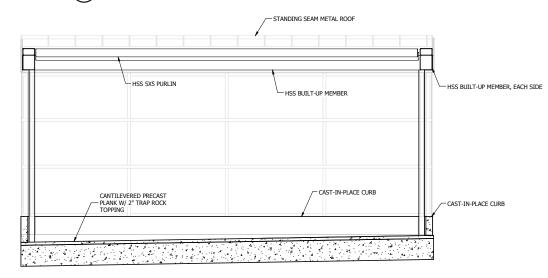

STANDING SEAM METAL ROOF HSS 5X5 PURLIN, TYP. HSS BUILT-UP MEMBER -TAPERED BUILT-UP MEMBER, BEYOND HSS BUILT-UP MEMBER HSS 4x4 COLUMN -HSS 8.625, BEYOND PRECAST PLANKS WITH 2" TRAP ROCK TOPPING TO CANTILEVER FOR WARMING HOUSE SUPPORT THICKEN AS-REQUIRED FOR STRUCTURAL SUPPORT CAST-IN-PLACE CONCRETE PIER DOWELED INTO BRIDGE DECK ELEVATED _ STRUCTURE ES 209 SECTION THROUGH WARMING HOUSE AT ELEVATED STRUCTURE ES209


TYPICAL SECTION THROUGH WARMING HOUSE

3/8" = 1'-0"

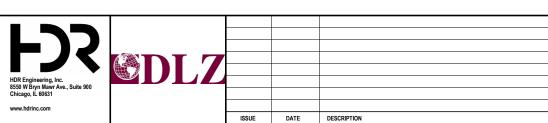




		NOT F	OR CONSTRUCTION	SERIES ST-	4301			
DESIGNED:	VMR		NICTD - WEST LAKE CORRIDOR - I	MP <u>69.</u> 0				
DRAWN:	VMR		******					
CHECKED:	CVAN	WEST LAKE WARMING						
		QI	SECTIONS					
DATE:	07/21/17	5	LCTIONS					
		FILENAME		SHEET				
		SCALE	3/8" = 1'-0"	1	212	OF	361	

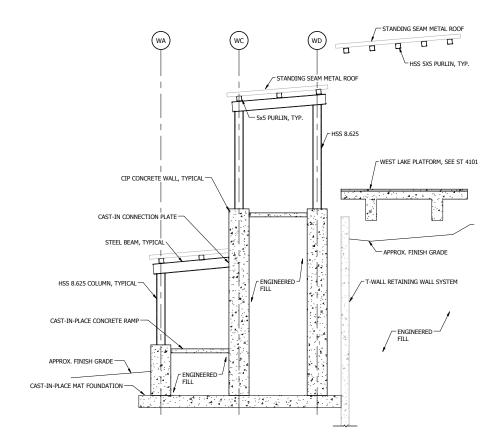

NOTE:
1. GUARDRAIL AND HANDRAIL NOT SHOWN FOR CLARITY, REFER TO ARCHITECTURAL DRAWINGS.

WEST LAKE WEST RAMP SECTION


1/4" = 1'-0"

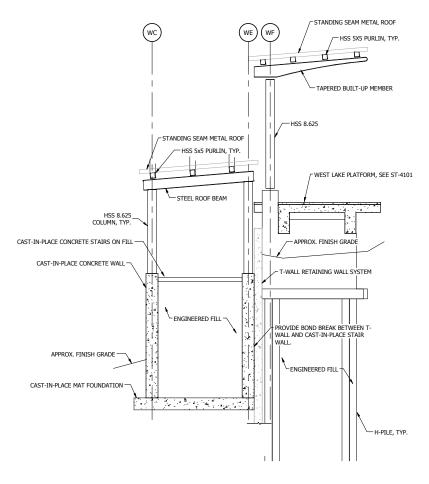

NOTE:
1. GUARDRAIL AND HANDRAIL NOT SHOWN FOR CLARITY, REFER TO ARCHITECTURAL DRAWINGS.

WEST LAKE WEST STAIR SECTION

1/4" = 1'-0"

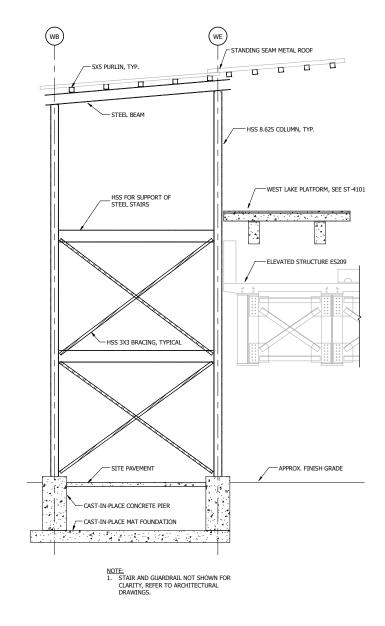


WEST LAKE EAST STAIR SECTION


1/4" = 1'-0"






	NOT F	OR CONSTRUCTION	SERIES	-4501			
DESIGNED: VMR		NICTD - WEST LAKE CORRIDOR - I	MP <u>69.</u> 0				_
DRAWN: VMR			_				
CHECKED: CVAN	W	WEST LAKE PLATFORM RAMP					
	_ P	ETAILS					
DATE: 07/21/17	ן ט	ETAILS					
	FILENAME		SHEET				
	SCALE	1/4" = 1'-0"		213	OF	361	

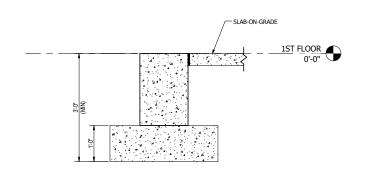

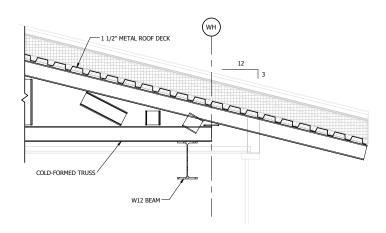

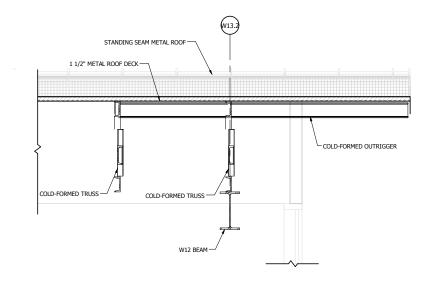


TYPICAL FOUNDATION SECTION

3/4" = 1'-0"


2 TYPICAL TRUSS BEARING AT SOUTH
3/4" = 1'-0"

3 TYPICAL DECK BEARING ROOF DETAIL

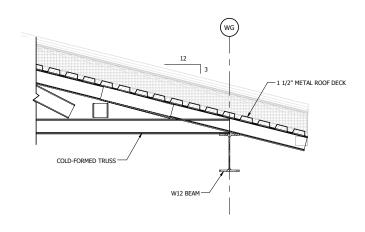

TYPICAL TRUSS BEARING AT NORTH


3/4" = 1'-0"

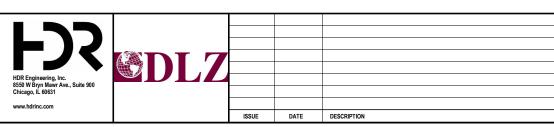





	NOT F	OR CONSTRUCTION	SERIES ST-4	4502			
DESIGNED: VMR DRAWN: VMR CHECKED: CVAN DATE: 07/21/17		NICTO - WEST LAKE CORRIDOR - N PROJECT NAME ATEWAY STATION ETAILS		USE	Ξ		
	FILENAME		SHEET				
	SCALE	3/4" = 1'-0"		214	OF	361	

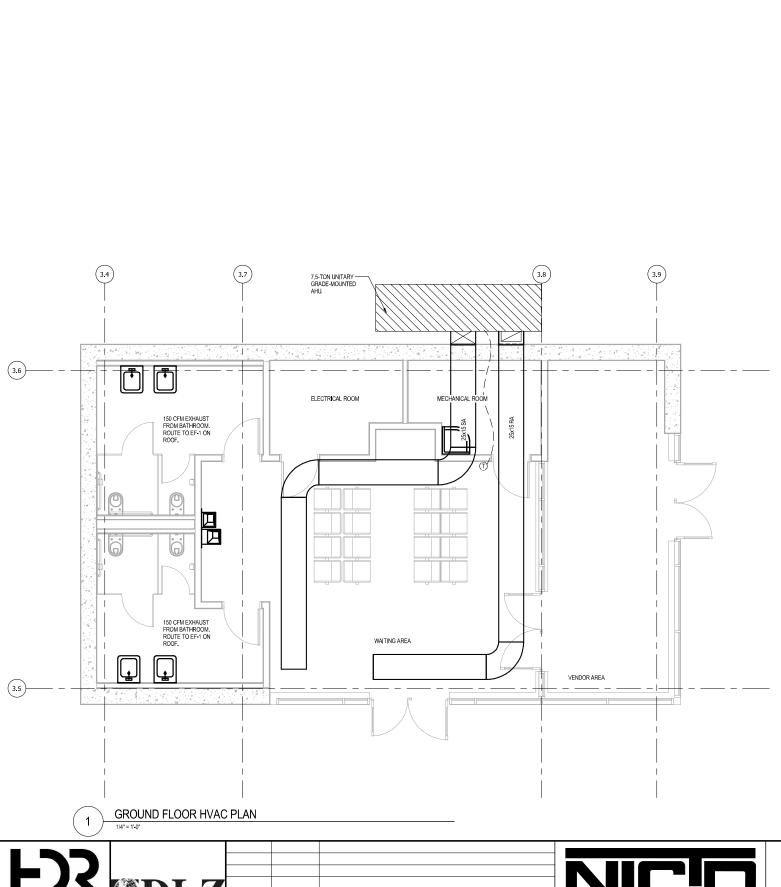

NOT FOR CONSTRUCTION
SERIES M-4101

DATE DESCRIPTION


TRANSPORTATION DISTRICT 33 East Highway 12 Chesterton, Indiana 46304



DESIGNED:	ZEA	
DRAWN:	ZEA	
CHECKED:	ESA	
		ĺ
DATE:	07/21/2017	
		1
		1

GATEWAY HVAC-OVERALL GROUND FLOOR PLAN

FILENAME 215 **OF** 361 SCALE 1/4" = 1'-0"

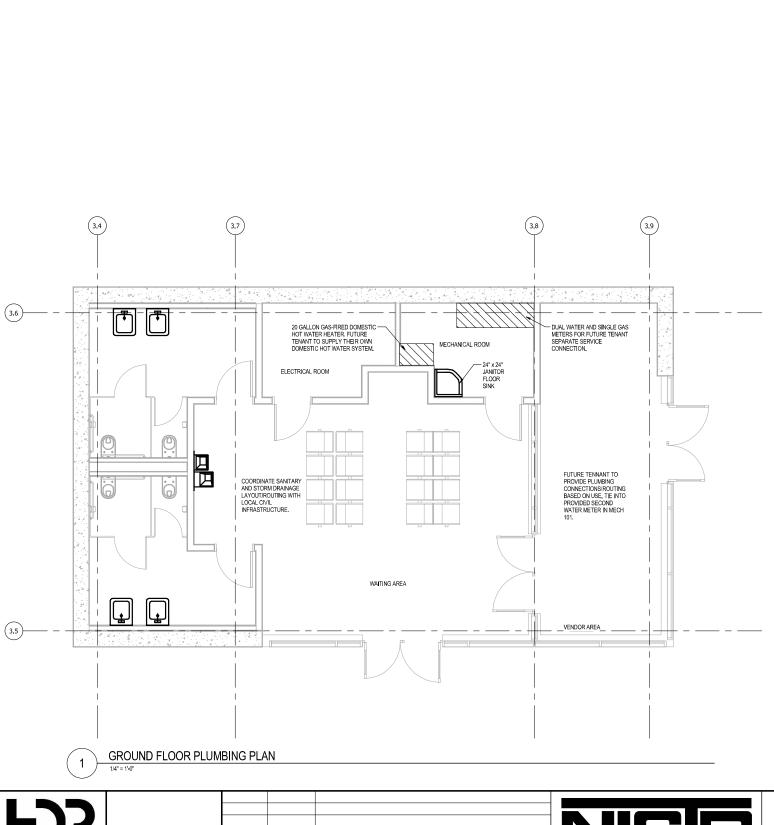

DATE DESCRIPTION

NOT FOR CONSTRUCTION

SERIES MP-4101

DRAWN: ZEA

CHECKED: ESA

DATE: 07/21/2017

HAMMOND GATEWAY PLUMBING-OVERALL GROUND FLOOR PLAN


216 **OF** 361


FILENAME SCALE

1/4" = 1'-0"

NORTHERN INDIANA COMMUTER TRANSPORTATION DISTRICT 33 East Highway 12 Chesterton, Indiana 46304

DYER TO HAMMOND, INDIANA

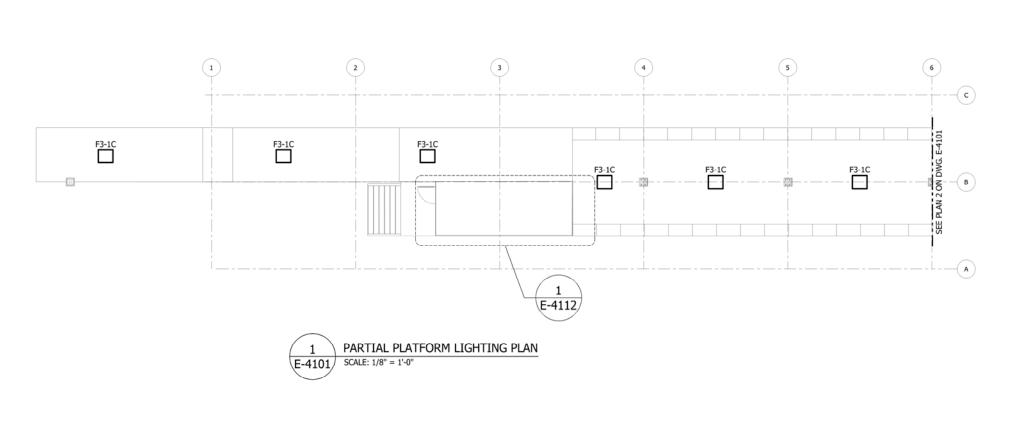

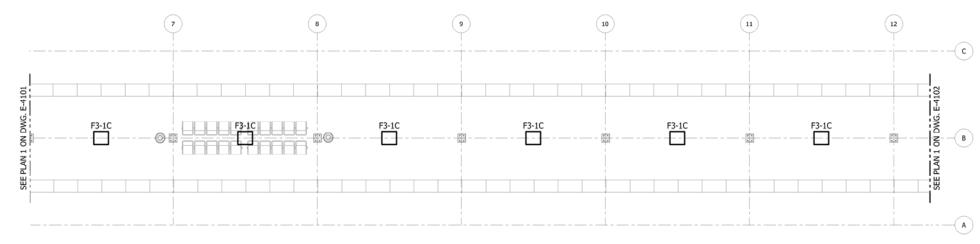





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AAA ENGINEERING
DBE CERTIFIED AAA Engineering, Ltd. 4323 W Irving Park Rd., Suite 200 Chicago, IL 60641 P: 773-657-3300 F: 773-657-3330 www.AAAEngineering.net ISSUE DATE DESCRIPTION

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		NOT FOR CONSTRUCTION SERIES E-4101
DESIGNED:	A. FAREKAS	NICTD - WEST LAKE CORRIDOR - MP 68.9
DRAWN:	C. MARTIN	HAMMOND GATEWAY STATION
CHECKED:	M. BLUMENTHAL	PARTIAL PLATFORM LIGHTIN
		PARTIAL PLATFORM LIGHTIN
DATE:	07/21/17	SOUTH SHORE PLATED

NICTD - WEST HAMMON
PARTIAL PLATFOI
SOUTH SHO

PRM LIGHTING PLANS -IORE PLATFORM

FILENAME SHT_WL_E_GATEWAYSTN_PL_01 SCALE 1/8" = 1' - 0"


NOTES:

SEE SHEETS E-0001 AND E-0002 FOR ELECTRICAL SYMBOL LIST, ABBREVIATIONS, AND GENERAL NOTES.


3. SEE SHEET E-0601 FOR LIGHTING FIXTURE SCHEDULE.

2. SEE SHEET E-4602 FOR CABLE AND CONDUIT SCHEDULE.

217 OF 361

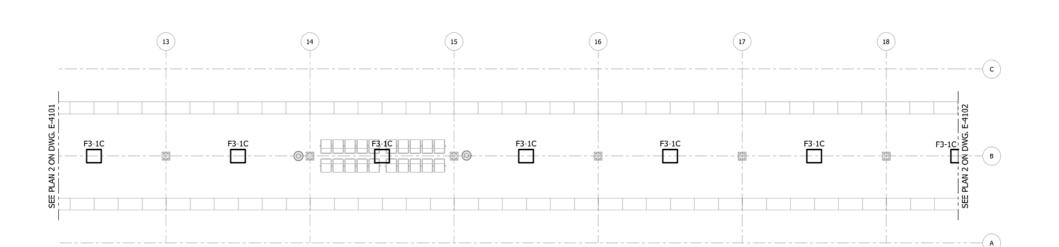

PARTIAL PLATFORM LIGHTING PLAN E-4102 SCALE: 1/8" = 1'-0"

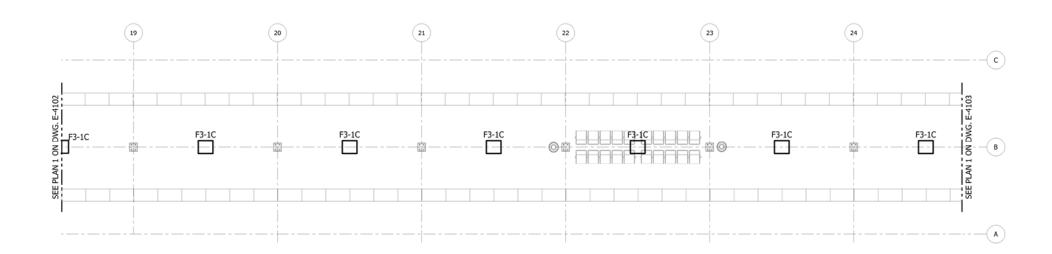

PARTIAL PLATFORM LIGHTING PLAN SCALE: 1/8" = 1'-0" \E-4102*/*



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		INC
DESIGNED:	A. FAREKAS	
DRAWN:	C. MARTIN	
CHECKED:	M. BLUMENTHAL	P
DATE:	07/21/17	
		FILEN

PARTIAL PLATFORM LIGHTING PLANS
SOUTH SHORE PLATFORM

ENAME SHT_WL_E_GATEWAYSTN_PL_02 218 OF 361 SCALE 1/8" = 1' - 0"


M:5050 NICTD WEST LAKE PROJECT:04 - CADD FILES:04 - SHEET FILES:HAMMOND GATEWAY STATION:SHT_WL_E_GATEWAYSTN_PL_02.DWG


NOTES:

SEE SHEETS E-0001 AND E-0002 FOR ELECTRICAL SYMBOL LIST, ABBREVIATIONS, AND GENERAL NOTES.


3. SEE SHEET E-0601 FOR LIGHTING FIXTURE SCHEDULE.

2. SEE SHEET E-4602 FOR CABLE AND CONDUIT SCHEDULE.

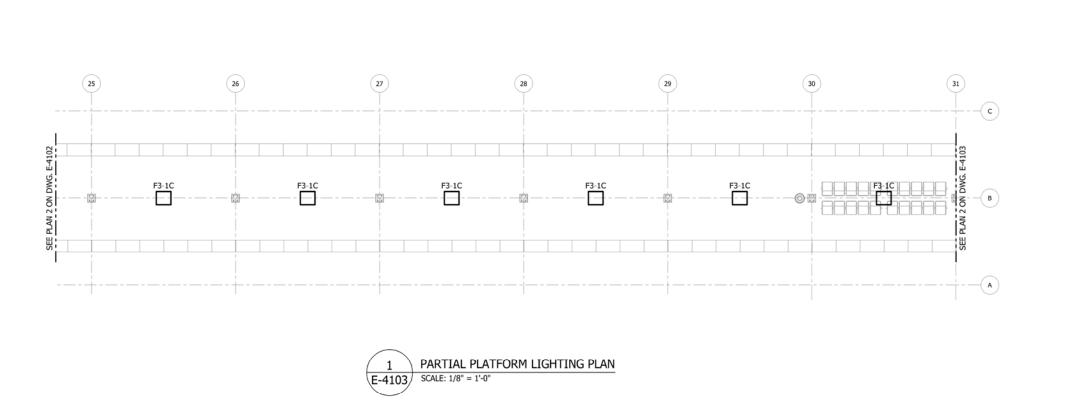

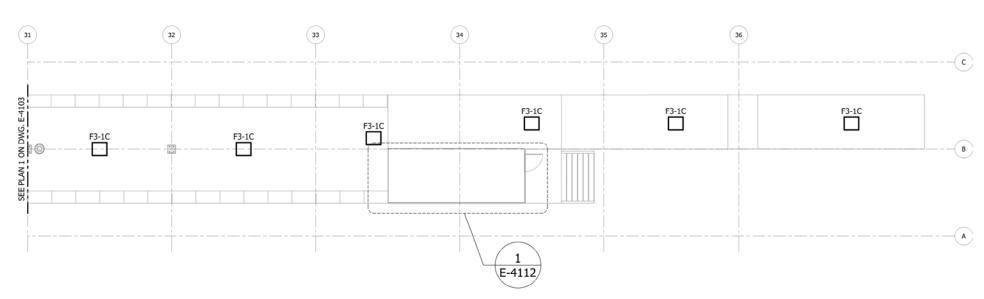

PARTIAL PLATFORM LIGHTING PLAN SCALE: 1/8" = 1'-0"

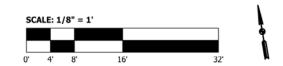

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		NOT F	OR CO	ONSTRUCT	ION	SERIES E-4103	
DESIGNED:	A. FAREKAS				EST LAKE CORRIDOR - MP 68.9		
DRAWN:	C. MARTIN		HAMMOND GATEWAY				
CHECKED:	M. BLUMENTHAL	PAR	PARTIAL PLATFORM LIC				
		1 730					
DATE:	07/21/17	SOUTH SHORE I			PLATEC		
		FILENAME	SHT WI	F GATEWAYSTN	PI 03	SHEET	

HAMMOND GATEWAY STATION	
ARTIAL PLATFORM LIGHTING PLANS	; ·
SOUTH SHORE PLATFORM	

ENAME SHT_WL_E_GATEWAYSTN_PL_03 219 OF 361


NOTES:

SEE SHEETS E-0001 AND E-0002 FOR ELECTRICAL SYMBOL LIST, ABBREVIATIONS, AND GENERAL NOTES.


3. SEE SHEET E-0601 FOR LIGHTING FIXTURE SCHEDULE.

2. SEE SHEET E-4602 FOR CABLE AND CONDUIT SCHEDULE.


4. SEE SHEET E-4102 FOR PANEL LOCATIONS.

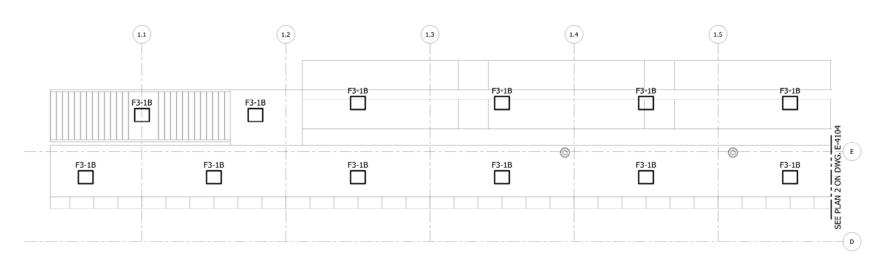

PARTIAL PLATFORM LIGHTING PLAN E-4104 SCALE: 1/8" = 1'-0"

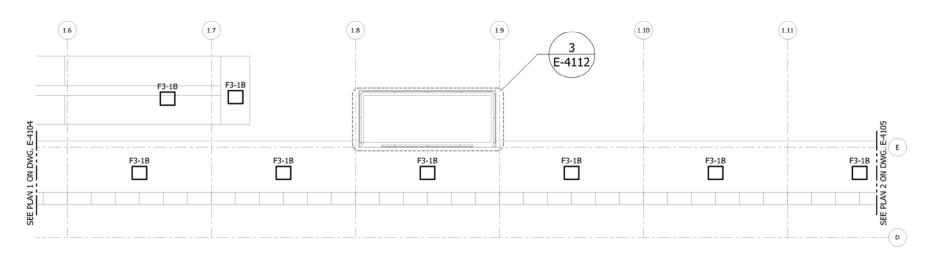

PARTIAL PLATFORM LIGHTING PLAN E-4104 SCALE: 1/8" = 1'-0"

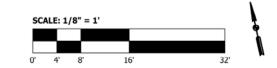



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NOT FOR CONSTRUCTION E-4104		
NICTD - WEST LAKE CORRIDOR - MP WL 69.0	A. FAREKAS	DESIGNED:
HAMMOND GATEWAY STATION	C. MARTIN	DRAWN:
PARTIAL PLATFORM LIGHTIN	M. BLUMENTHAL	CHECKED:
WEST LAKE PLATFOR	07/21/17	DATE:

NICTD - WEST LAKE CORRIDOR - MP WL 69.0 HAMMOND GATEWAY STATION PARTIAL PLATFORM LIGHTING PLANS -

NOTES:


SEE SHEETS E-0001 AND E-0002 FOR ELECTRICAL SYMBOL LIST, ABBREVIATIONS, AND GENERAL NOTES.

3. SEE SHEET E-0601 FOR LIGHTING FIXTURE SCHEDULE.


2. SEE SHEET E-4602 FOR CABLE AND CONDUIT SCHEDULE.

WEST LAKE PLATFORM

FILENAME SHT_WL_E_GATEWAYSTN_PL_04 SHEET 220 OF 361 SCALE 1/8" = 1' - 0"

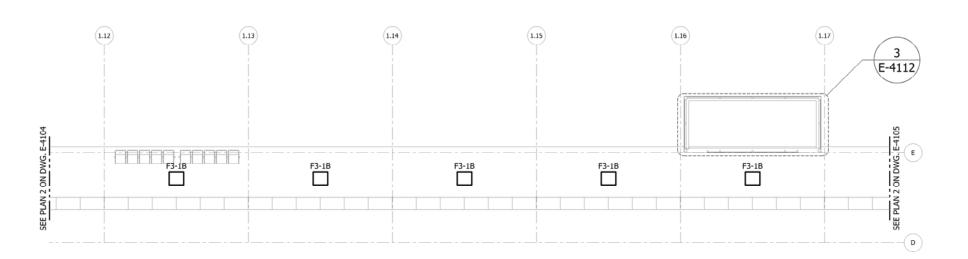

PARTIAL PLATFORM LIGHTING PLAN E-4105 SCALE: 1/8" = 1'-0"

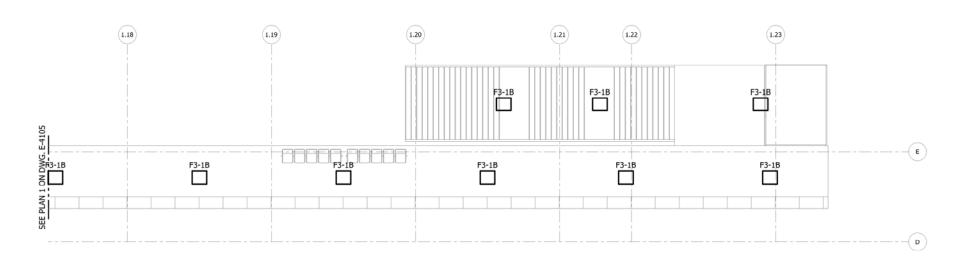

PARTIAL PLATFORM LIGHTING PLAN E-4105 SCALE: 1/8" = 1'-0"



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		NOT F	FOR CONSTRUCTION SERIES E-4105
DESIGNED:	A. FAREKAS		NICTD - WEST LAKE CORRIDOR - MP WL 69.0
DRAWN:	C. MARTIN		HAMMOND GATEWAY STATION
CHECKED:	M. BLUMENTHAL	PAR	RTIAL PLATFORM LIGHTIN
DATE:	07/21/17		WEST LAKE PLATFOR
		EII ENAME	CUT MU E CATEMANOTAL DI OS SHEFT

PARTIAL PLATFORM LIGHTING PLANS -WEST LAKE PLATFORM


FILENAME SHT_WL_E_GATEWAYSTN_PL_05 221 OF 361 SCALE 1/8" = 1' - 0"


NOTES:

SEE SHEETS E-0001 AND E-0002 FOR ELECTRICAL SYMBOL LIST, ABBREVIATIONS, AND GENERAL NOTES.

3. SEE SHEET E-0601 FOR LIGHTING FIXTURE SCHEDULE.

2. SEE SHEET E-4602 FOR CABLE AND CONDUIT SCHEDULE.

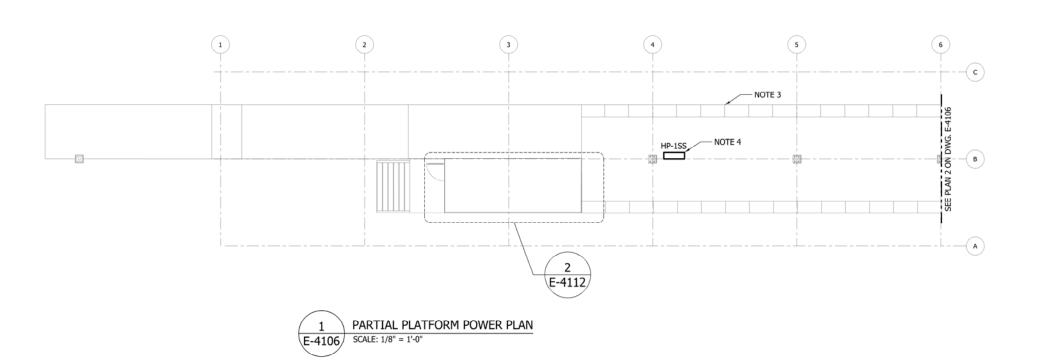

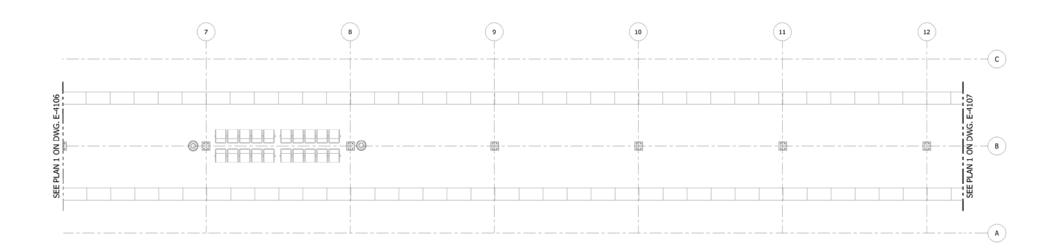









NORTHERN INDIANA COMMUTER TRANSPORTATION DISTRICT 33 East Highway 12 Chesterton, Indiana 46304



		NOT F	FOR CONSTRUCTION SERIES E-4106
DESIGNED:	A. FAREKAS		NICTD - WEST LAKE CORRIDOR - MP 68.9
DRAWN:	C. MARTIN		HAMMOND GATEWAY STATION
CHECKED:	M. BLUMENTHAL	DΛ	DTIAL DI ATEODM DOMES
		PA	RTIAL PLATFORM POWER
DATE:	07/21/17		SOUTH SHORE PLATFO
			OGOTH OHORE LEXTIC
		FILENAME	SHT WL E GATEWAYSTN PL 06 SHEET

PARTIAL PLATFORM POWER PLANS -SOUTH SHORE PLATFORM


ENAME SHT_WL_E_GATEWAYSTN_PL_06 SHEET 222 OF 361 SCALE 1/8" = 1' - 0"

NOTES:


SEE SHEETS E-0001 AND E-0002 FOR ELECTRICAL SYMBOL LIST, ABBREVIATIONS, AND GENERAL NOTES.

4. APPROXIMATE LOCATION OF HEAT TRACING PANELS.

2. SEE SHEET E-4602 FOR CABLE AND CONDUIT SCHEDULE. 3. PROVIDE HEAT TRACING TO PLATFORM AND RAMPS.

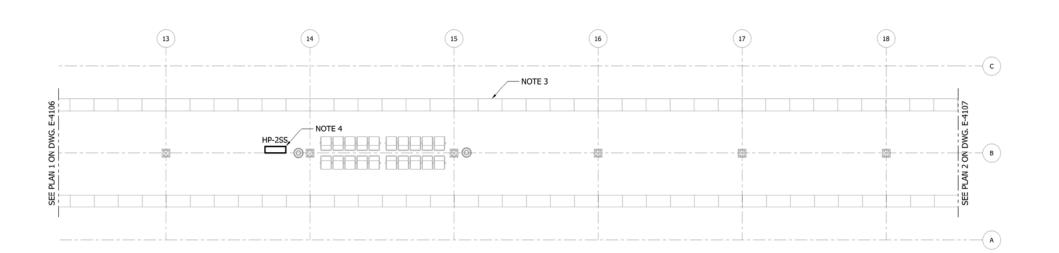

PARTIAL PLATFORM POWER PLAN E-4107 SCALE: 1/8" = 1'-0"

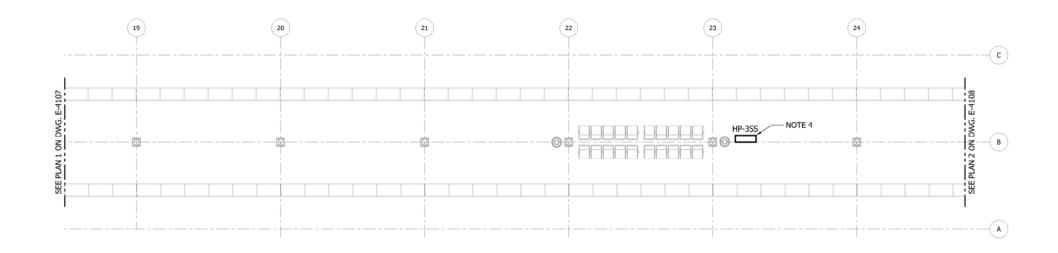





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		NOT FOR CONSTRUCTION	SERIES E-4107
DESIGNED:	A. FAREKAS	NICTD - WEST LAKE CORRID	
DRAWN:	C. MARTIN	HAMMOND GATEWAY S	STATION
CHECKED:	M. BLUMENTHAL	PARTIAL PLATFORM	POWER
DATE:	07/21/17		
DATE:	07/21/17	SOUTH SHORE	PLATE
-			

NICTD - WEST LAKE CORRIDOR - MP 68.9 HAMMOND GATEWAY STATION
ARTIAL PLATFORM POWER PLANS -
SOUTH SHORE PLATFORM

NOTES:


SEE SHEETS E-0001 AND E-0002 FOR ELECTRICAL SYMBOL LIST, ABBREVIATIONS, AND GENERAL NOTES.

4. APPROXIMATE LOCATION OF HEAT TRACING PANELS.


2. SEE SHEET E-4602 FOR CABLE AND CONDUIT SCHEDULE. 3. PROVIDE HEAT TRACING TO PLATFORM AND RAMPS.

FILENAME SHT_WL_E_GATEWAYSTN_PL_07 223 OF 361 SCALE 1/8" = 1' - 0"


M:5050 NICTD WEST LAKE PROJECT:04 - CADD FILES:04 - SHEET FILES:HAMMOND GATEWAY STATION:SHT_WL_E_GATEWAYSTN_PL_07.DWG

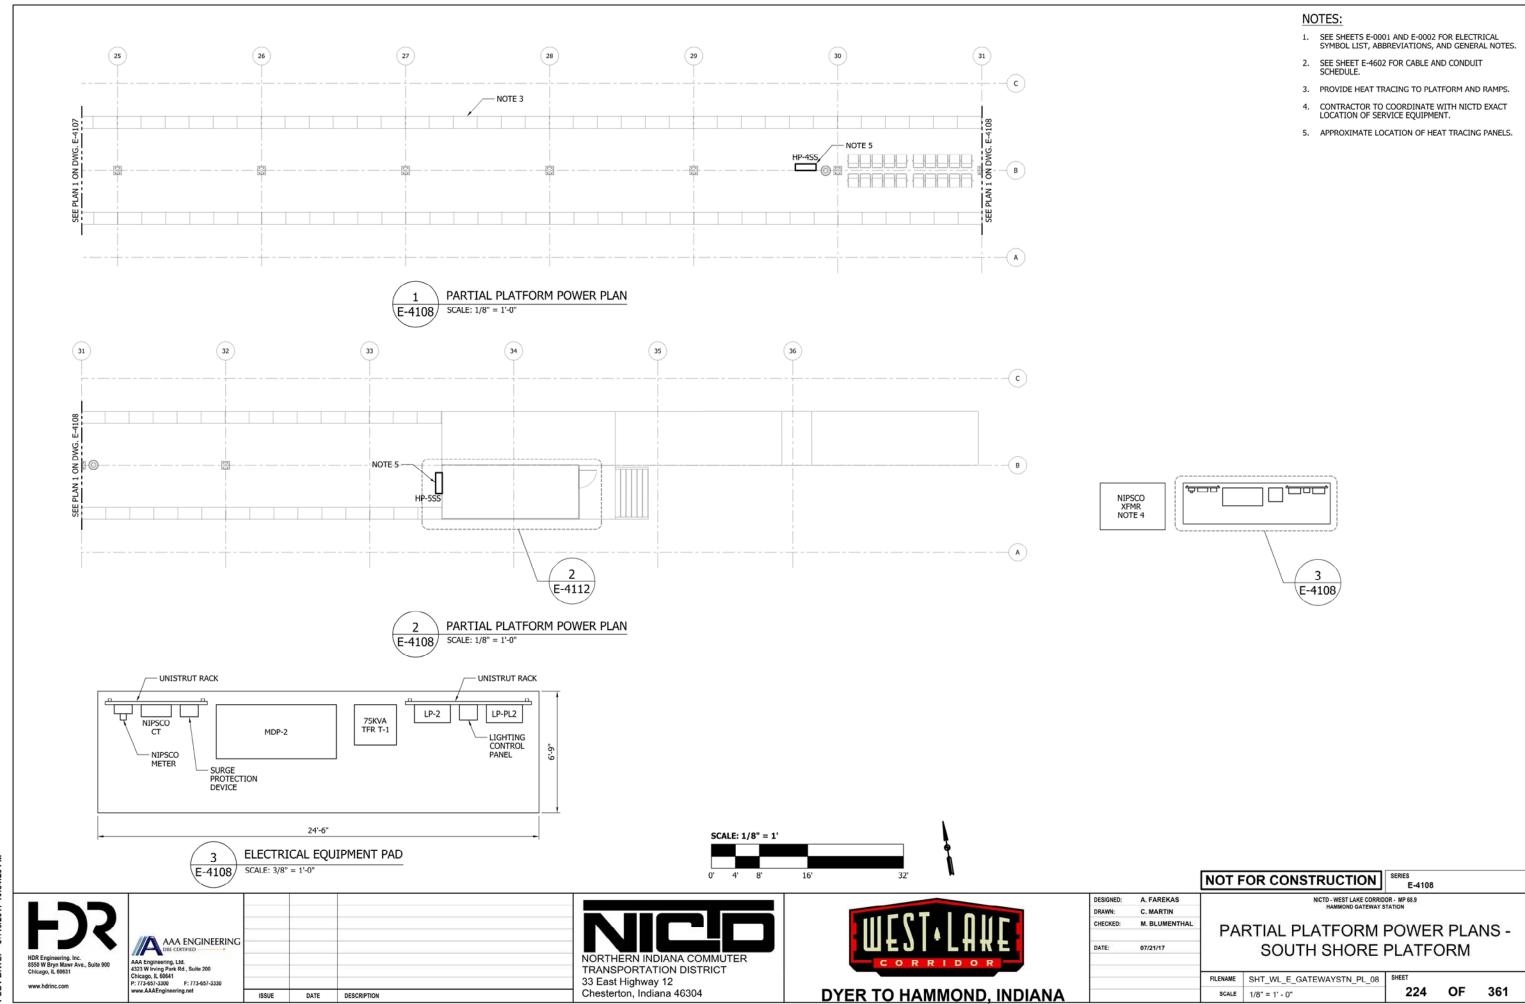


M:5050 NICTD WEST LAKE PROJECT:04 - CADD FILES:04 - SHEET FILES:HAMMOND GATEWAY STATION:SHT_WL_E_GATEWAYSTN_PL_08.DWG

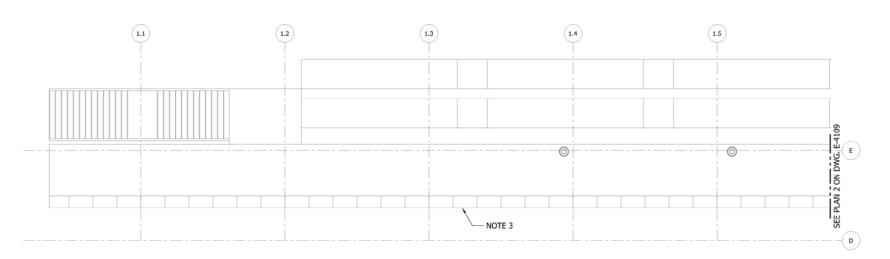




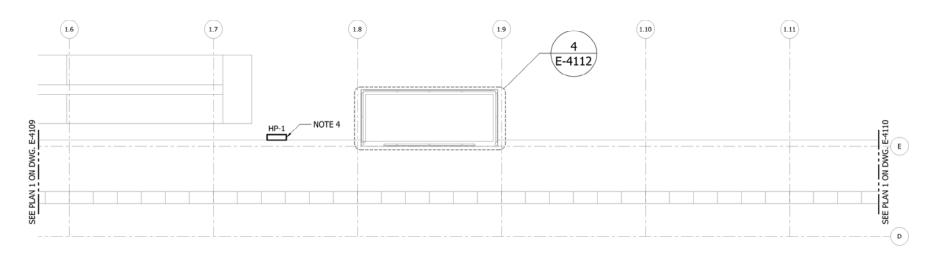



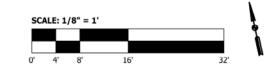



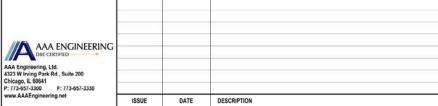

NORTHERN INDIANA COMMUTER TRANSPORTATION DISTRICT 33 East Highway 12 Chesterton, Indiana 46304



		NOT F	FOR CONSTRUCTION E-4109
DESIGNED:	A. FAREKAS		NICTD - WEST LAKE CORRIDOR - MP WL 69.0
DRAWN:	C. MARTIN		HAMMOND GATEWAY STATION
CHECKED:	M. BLUMENTHAL	PA	RTIAL PLATFORM POWER
DATE:	07/21/17		WEST LAKE PLATFOR
		FII ENAME	SHT WILE CATEWAYSTN DL OG SHEET

NICTD - WEST LAKE CORRIDOR - MP WL 69.0 HAMMOND GATEWAY STATION PARTIAL PLATFORM POWER PLANS -WEST LAKE PLATFORM

NOTES:

SEE SHEETS E-0001 AND E-0002 FOR ELECTRICAL SYMBOL LIST, ABBREVIATIONS, AND GENERAL NOTES.


3. PROVIDE HEAT TRACING TO PLATFORM AND RAMPS. 4. APPROXIMATE LOCATION FOR HEAT TRACING PANEL.


2. SEE SHEET E-4602 FOR CABLE AND CONDUIT SCHEDULE.

FILENAME SHT_WL_E_GATEWAYSTN_PL_09 SHEET SCALE 1/8" = 1' - 0"

225 OF 361

M:5050 NICTD WEST LAKE PROJECT:04 - CADD FILES:04 - SHEET FILES:HAMMOND GATEWAY STATION:SHT_WL_E_GATEWAYSTN_PL_09.DWG

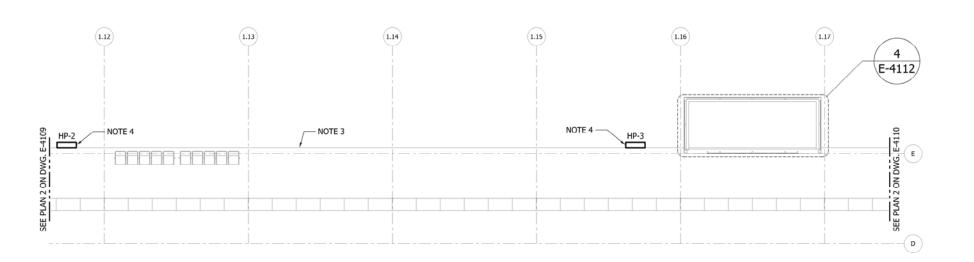


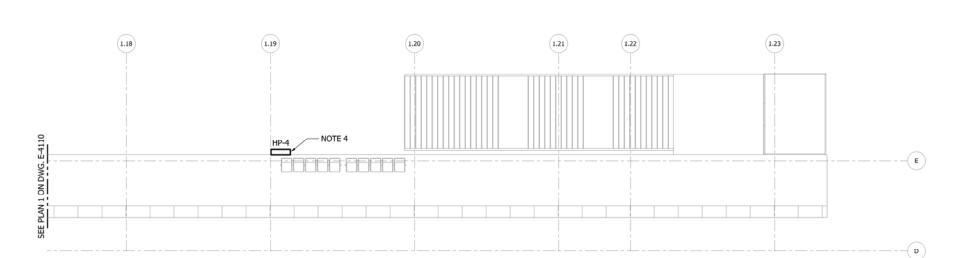



PARTIAL PLATFORM POWER PLAN

E-4110 SCALE: 1/8" = 1'-0"

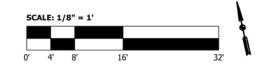



AAA ENGINEERING AAA Engineering, Ltd. 4323 W Irving Park Rd., Suite 200 Chicago, IL 60641 P: 773-657-3300 F: 773-657-3330 www.AAAEngineering.net ISSUE DATE DESCRIPTION

NORTHERN INDIANA COMMUTER TRANSPORTATION DISTRICT 33 East Highway 12 Chesterton, Indiana 46304



		NOT F	OR CONSTRUCTION	SERIES E-4110
DESIGNED:	A. FAREKAS		NICTD - WEST LAKE CORRIDO	
DRAWN:	C. MARTIN		HAMMOND GATEWAY	STATION
CHECKED:	M. BLUMENTHAL	РΔ	RTIAL PLATFORM	POWER
DATE:	07/21/17	1.7	WEST LAKE PI	
		CH CHAME	0.17.11. 5 0.1751111110711 51 10	QUEET

NICTD - WEST LAKE CORRIDOR - MP WL 69.0 HAMMOND GATEWAY STATION PARTIAL PLATFORM POWER PLANS -

WEST LAKE PLATFORM

FILENAME SHT_WL_E_GATEWAYSTN_PL_10 SHEET SCALE 1/8" = 1' - 0"

NOTES:

SEE SHEETS E-0001 AND E-0002 FOR ELECTRICAL SYMBOL LIST, ABBREVIATIONS, AND GENERAL NOTES.

3. PROVIDE HEAT TRACING TO PLATFORM AND RAMPS.


4. APPROXIMATE LOCATION FOR HEAT TRACING PANEL.

2. SEE SHEET E-4602 FOR CABLE AND CONDUIT SCHEDULE.

226 OF 361

M:5050 NICTD WEST LAKE PROJECT:04 - CADD FILES:04 - SHEET FILES:HAMMOND GATEWAY STATION:SHT_WL_E_GATEWAYSTN_PL_10.DWG

- SEE SHEETS E-0001 AND E-0002 FOR ELECTRICAL SYMBOL LIST, ABBREVIATIONS, AND GENERAL NOTES.
- 2. SEE SHEET E-4602 FOR CABLE AND CONDUIT SCHEDULE.
- 3. SEE SHEET E-0601 FOR LIGHTING FIXTURE SCHEDULE.
- 4. CEILING MOUNTED MOTION SENSOR.
- 5. APPROXIMATE LOCATION OF TRANSFORMER FIELD VERIFY.

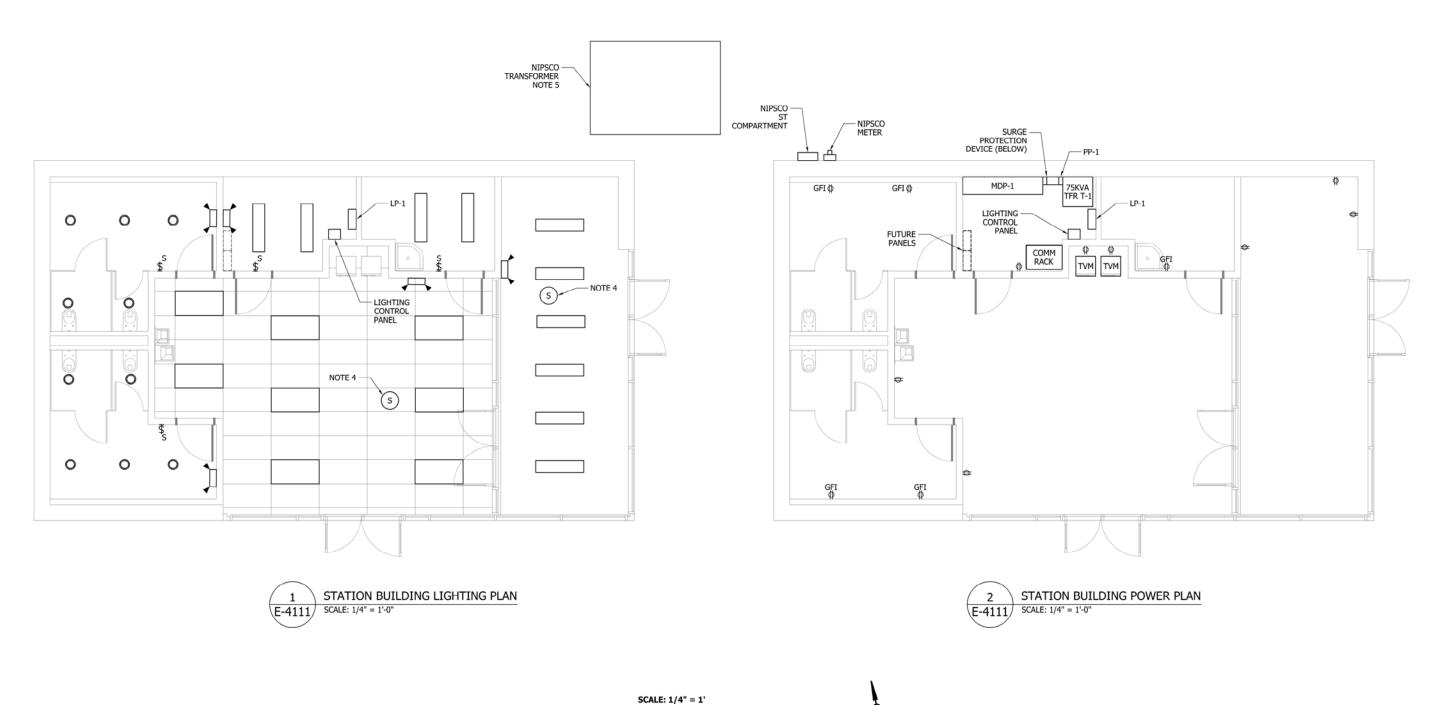

HDR Engineering, Inc. 8550 W Bryn Mawr Ave., Suite 900 Chicago, IL 60631

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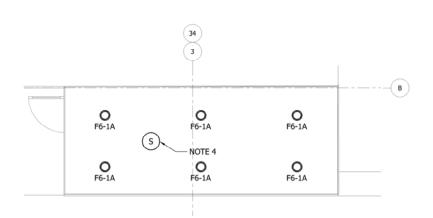
		NOT F	OR CONSTRUCTION	SERIES E-4111
DESIGNED:	A. FAREKAS		NICTD - WEST LAKE CORRIDO	
DRAWN:	C. MARTIN		HAMMOND GATEWAY S	TATION
CHECKED:	M. BLUMENTHAL	1		
			STATION BUILD	ING DI
DATE:	07/21/17		STATION BUILD	ING FL
		FILENAME	SHT WL E GATEWAYSTN PL 11	SHEET

STATION BUILDING PLANS


SCALE 1/4" = 1' - 0"

ENAME SHT_WL_E_GATEWAYSTN_PL_11


227 OF 361




1 TYPICAL SOUTH SHORE WARMING HUT LIGHTING PLAN SCALE: 1/4" = 1'-0"

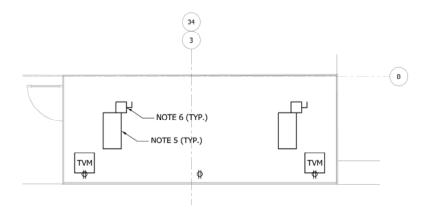

2 TYPICAL SOUTH SHORE WARMING HUT POWER PLAN SCALE: 1/4" = 1'-0"

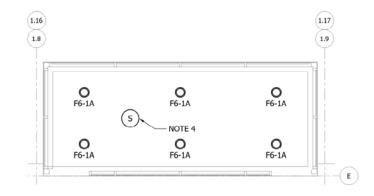

3 TYPICAL WEST LAKE WARMING HUT LIGHTING PLAN
E-4112 SCALE: 1/4" = 1'-0"

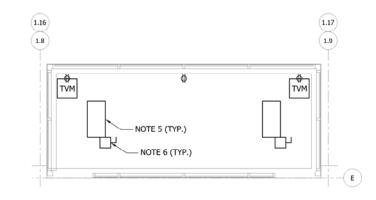

TYPICAL WEST LAKE WARMING HUT POWER PLAN

SCALE: 1/4" = 1'-0"



HDR Engineering, Inc. 8550 W Bryn Mawr Ave., Suite 900 Chicago, It. 60631 www.hdrinc.com

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DECCENTRIED

AAA Engineering, Ltd.
432 W Irving Park Rd, Suite 200
Chicago, IL 60641
P. 173-657-3330
www.AAAEngineering.net
ISSUE DATE DESCRIPTION





		NOT F	OR CONSTRUCTION	SERIES E-4112			_
ESIGNED:	A. FAREKAS		NICTD - WEST LAKE CORRIDO				_
RAWN:	C. MARTIN		HAMMOND GATEWAY S	STATION			
HECKED:	M. BLUMENTHAL						
			TYPICAL WARMING	CHIT	DI ANI	9	
ATE:	07/21/17		TIFICAL WARWING	3 11011	LAIN	3	
	VANATURE III						
		FILENAME	SHT_WL_E_GATEWAYSTN_PL_12	SHEET			_
		SCALE	1/4" = 1' - 0"	228	OF	361	

NOTES:

 SEE SHEETS E-0001 AND E-0002 FOR ELECTRICAL SYMBOL LIST, ABBREVIATIONS, AND GENERAL NOTES.


3. SEE SHEET E-0601 FOR LIGHTING FIXTURE SCHEDULE.

6. SIZE DISCONNECT SWITCHES FOR INFRARED HEATERS SIZE.

2. SEE SHEET E-4602 FOR CABLE AND CONDUIT SCHEDULE.

4. CEILING MOUNTED MOTION SENSOR.

INFRARED HEATERS.

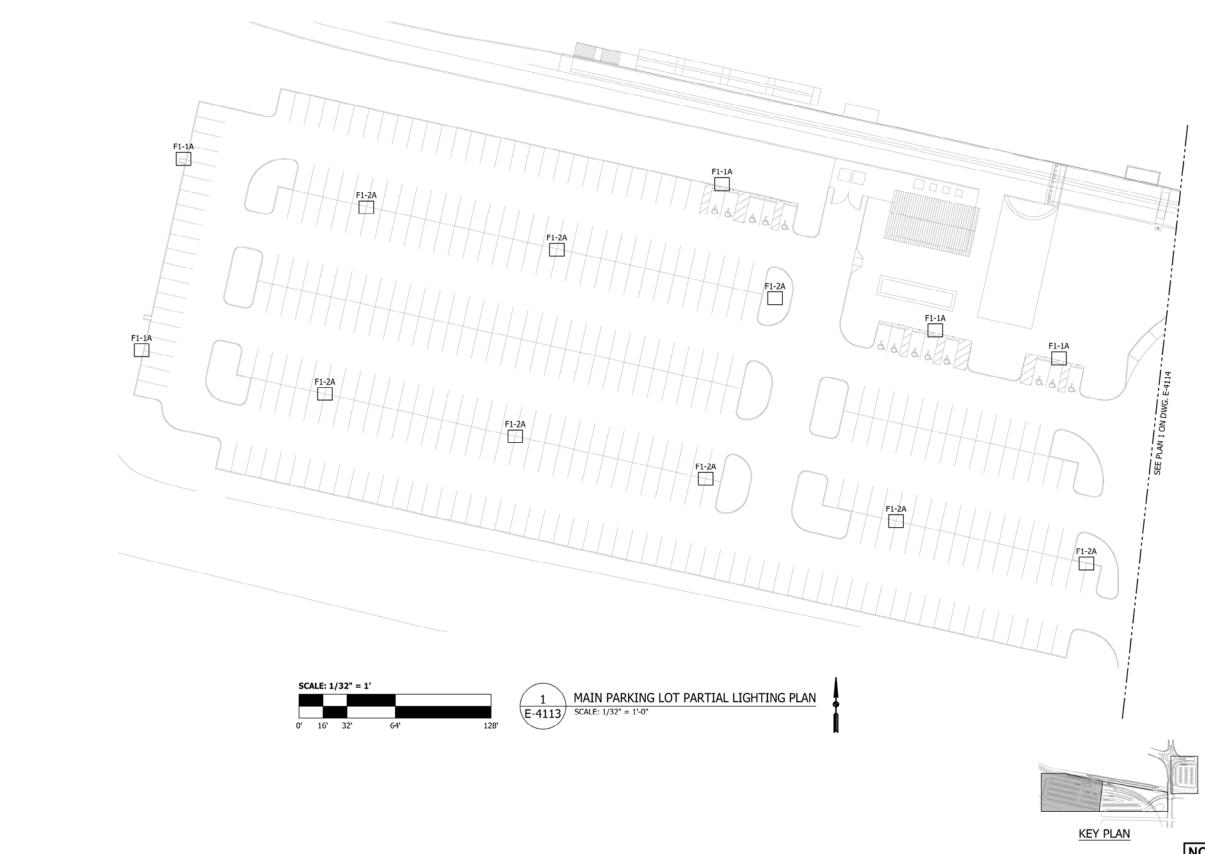

- SEE SHEETS E-0001 AND E-0002 FOR ELECTRICAL SYMBOL LIST, ABBREVIATIONS, AND GENERAL NOTES.
- 2. SEE SHEET E-4602 FOR CABLE AND CONDUIT SCHEDULE.
- 3. SEE SHEET E-0601 FOR LIGHTING FIXTURE SCHEDULE.

NOT FOR CONSTRUCTION SERIES E-4113

DESIGNED:

DRAWN: CHECKED: A. FAREKAS

C. MARTIN

OF

361


NICTD - WEST LAKE CORRIDOR - MP WL 69.0 HAMMOND GATEWAY STATION

MAIN PARKING LOT PARTIAL LIGHTING PLAN

SCALE 1/32" = 1' - 0"

FILENAME SHT_WL_E_GATEWAYSTN_PL_13 229

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DBE CERTIFIED AAA Engineering, Ltd. 4323 W Irving Park Rd., Suite 200 Chicago, IL 60641 P: 773-657-3300 F: 773-657-3330 www.AAAEngineering.net ISSUE DATE DESCRIPTION NORTHERN INDIANA COMMUTER TRANSPORTATION DISTRICT 33 East Highway 12 Chesterton, Indiana 46304

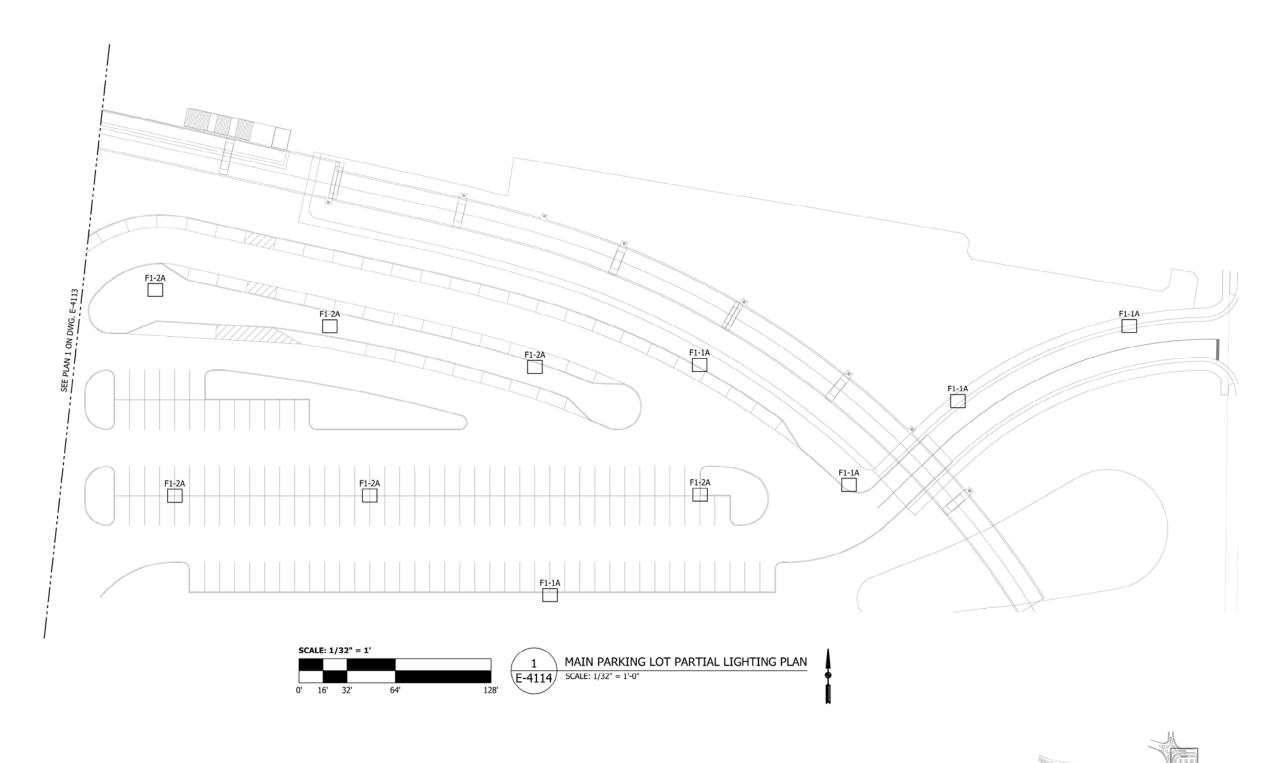



KEY PLAN

HDR Engineering, Inc. 8550 W Bryn Mawr Ave., Suite 900 Chicago, IL 60631 www.hdrinc.com	AAA ENGINEERING DBE CERTIFIED AAA Engineering, Ltd. 4323 W Irving Park Rd., Sulte 200 Chicago, IL 006041 P; 773-657-3330 www.AAAEngineering.net				NORTHERN INI TRANSPORTAT 33 East Highway Chesterton, India
		ISSUE	DATE	DESCRIPTION	Chesterton, mus

NDIANA COMMUTER ATION DISTRICT way 12 ndiana 46304



		NOT F	OR CONSTRUCTION	SERIES E-4114
DESIGNED:	A. FAREKAS		NICTD - WEST LAKE CORRIDO	
DRAWN:	C. MARTIN		HAMMOND GATEWAY	STATION
CHECKED:	M. BLUMENTHAL		MAINI DADKII	NCIOT
			MAIN PARKII	NG LOT
DATE:	07/21/17		PARTIAL LIGHT	ING PL
			17.0.117.12.21.0111	
-		FILENAME	SHT_WL_E_GATEWAYSTN_PL_14	SHEET

NICTD - WEST LAKE CORRIDOR - MP WL 69.0 HAMMOND GATEWAY STATION MAIN PARKING LOT PARTIAL LIGHTING PLAN

SCALE 1/32" = 1' - 0"

NOTES:

SEE SHEETS E-0001 AND E-0002 FOR ELECTRICAL SYMBOL LIST, ABBREVIATIONS, AND GENERAL NOTES.


3. SEE SHEET E-0601 FOR LIGHTING FIXTURE SCHEDULE.


2. SEE SHEET E-4602 FOR CABLE AND CONDUIT SCHEDULE.

AME SHT_WL_E_GATEWAYSTN_PL_14 SHEET 230 OF 361

- SEE SHEETS E-0001 AND E-0002 FOR ELECTRICAL SYMBOL LIST, ABBREVIATIONS, AND GENERAL NOTES.
- 2. SEE SHEET E-4602 FOR CABLE AND CONDUIT SCHEDULE.
- 3. SEE SHEET E-0601 FOR LIGHTING FIXTURE SCHEDULE.


231 OF 361

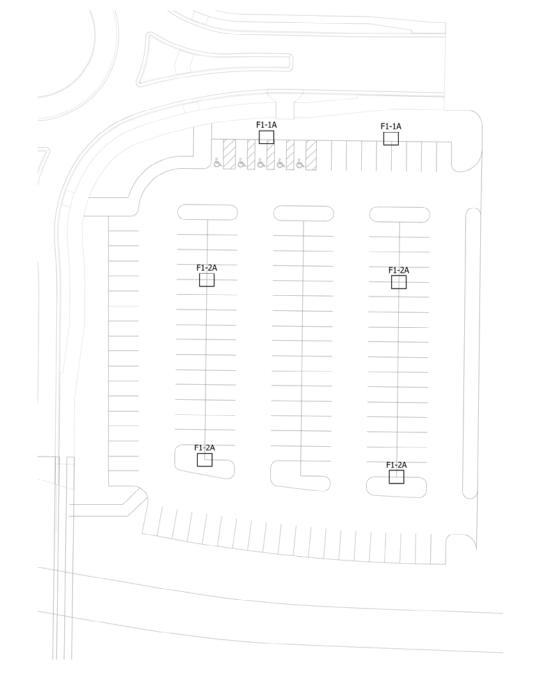

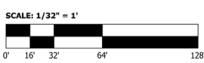





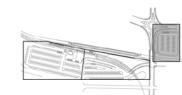


KEY PLAN

HDR Engineering, Inc. 8550 W Bryn Mawr Ave., Suite 900 Chicago, IL 60631 www.hdrinc.com	AAA ENGINEERING DEL CERTIFED AAA Engineering, Ltd. 4323 W Irving Park Rd., Suite 200 Chicago, IL 60641 P: 773-687-3330 www.AAAEngineering.net	ISSUE	DATE	DESCRIPTION	NORTHERN INDIAN TRANSPORTATION 33 East Highway 12 Chesterton, Indiana

ANA COMMUTER ON DISTRICT Chesterton, Indiana 46304



		NOT F	OR CONSTRUCTION	SERIES E-4115		
DESIGNED:	A. FAREKAS		NICTD - WEST LAKE CORRIDO			
DRAWN:	C. MARTIN		HAMMOND GATEWAY S	STATION		
CHECKED:	M. BLUMENTHAL					
DATE:	07/21/17		PARKING LOT LIG	HTING	PLAI	V
		FILENAME	SHT_WL_E_GATEWAYSTN_PL_15	SHEET		
		SCALE	1/32" = 1' - 0"	231	OF	:

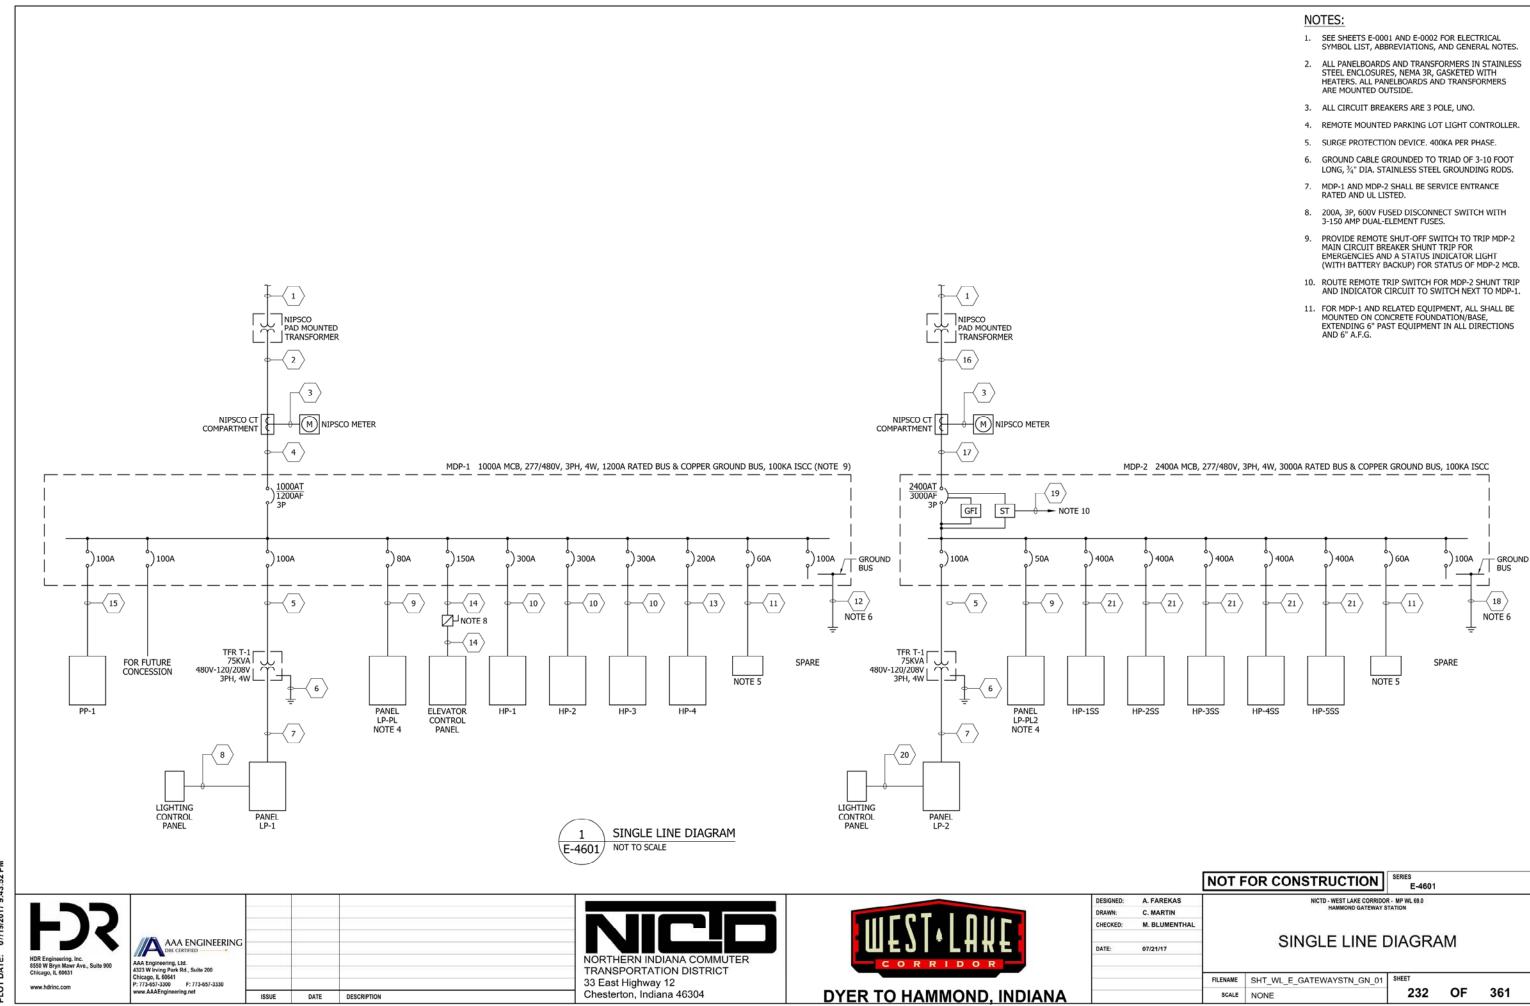

	CABLE AND CONDUIT SCHED	ULE	
LEGEND NUMBER	CABLE DESCRIPTION QUANTITY/SIZES	CONDUIT SIZE (INCHES)	NOTES
$\langle 1 \rangle$		(2) 4	2
2	3 SETS 4 #500 KCMIL & 1 #4/0 AWG GRD	(3) 4	3
3	10 #10 AWG	1	4
4	3 SETS 4 #500 KCMIL & 1 #4/0 AWG GRD	(3) 4	4
5	3 #2 AWG & 1 #8 AWG GRD	1½	4
6	1 #2 AWG GRD	1	4, 5
7	4 #4/0 AWG & 1 #2 AWG GRD	2½	4
8	4 SETS 8 #8 AWG & 1 #10 AWG GRD	(4) 1½	4, 6
9	4 #2 AWG & 1 #4 AWG GRD	2	3
(10)	4 #500 KCMIL & 1 #3 AWG GRD	3½	4
(11)	4 #6 AWG & 1 #8 AWG GRD	1	4
<u></u>	1 #4/0 AWG GRD	2	4
<u></u>	4 #4/0 AWG & 1 #4 AWG GRD	2½	4
<u></u>	3 #2/0 AWG & 1 #6 AWG GRD	2½	4
15	4 #2 AWG & 1 #8 AWG GRD	1½	4
(16)	6 SETS 4 #600 KCMIL & 1 #500 KCMIL GRD	(6) 4	3
(17)	6 SETS 4 #600 KCMIL & 1 #500 KCMIL GRD	(6) 4	4
(18)	1 #500 KCMIL GRD	2	4
(19)	10 #10 AWG & 1 #10 AWG GRD	1	3
20	5 SETS 8 #8 AWG & 1 #10 AWG GRD	(5) 1½	4
21	4 #600 KCMIL & 1 #1/0 AWG GRD	4	4
	-		

- SEE SHEETS E-0001 AND E-0002 FOR ELECTRICAL SYMBOL LIST, ABBREVIATIONS, AND GENERAL NOTES.
- 2-4" PVC SCHEDULE 40 CONDUITS TO NIPSCO POLE FOR PRIMARY TRANSFORMER FEEDER CABLE, CABLE FURNISHED AND INSTALLED BY NIPSCO.
- 3. CONDUIT, PVC SCHEDULE 40.
- 4. CONDUIT TO BE GRC.
- 5. GROUND CABLE GROUNDED TO 10 FOOT LONG, $3\!\!/\!_{\rm T}$ DIA. STAINLESS STEEL GROUNDING ROD.
- 6. 2 CONDUITS ARE FOR FUTURE.

NOT FOR CONSTRUCTION E-4602

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		_
DESIGNED:	A. FAREKAS	
DRAWN:	C. MARTIN]
CHECKED:	M. BLUMENTHAL]
]
DATE:	07/21/17]
]

CABLE AND CONDUIT SCHEDULE

FILENAME SHT_WL_E_GATEWAYSTN_GN_02 SHEET SCALE NONE

DATE DESCRIPTION

PANEL: LP-1 VOLTAGE: 120/208V, 3P, 4W ENCLOSURE: NEMA 1										MAIN MOUNTING BUS			DUND BUS
	BREAK			LOAD (VA)					LOAD (V		BREA		
CIRCUIT USE	TRIP	POLE	Α	В	С		T#	Α	В	С	TRIP	POLE	CIRCUIT USE
SPARE	20	1				1	2				20		SPARE
SPARE	20	1				3	4				20		SPARE
SPARE	20	1				5	6				20		SPARE
SPARE	20	1				7	8				20		SPARE
SPARE	20	1				9	10				20		SPARE
SPARE	20	1				11	12				20		SPARE
SPARE	20	1									20		SPARE
SPARE	20	1				15					20		SPARE
SPARE	20	1				17	18				20		SPARE
SPARE	20	1				19 21	20				20		SPARE
SPARE	20	1				21	22				20		SPARE
SPARE	20	1				23	24				20		SPARE
SPARE	20	1				25	26				20		SPARE
SPARE	20	1				27	28				20		SPARE
SPARE	20	1				29	30				20		SPARE
SPARE	20	1					32				20		SPARE
SPARE	20	1				33	34				20		SPARE
SPARE	20	1				35	36				20		SPARE
SPARE	20	1				37	38				20		SPARE
SPARE	20	1									20		SPARE
SPARE	20	1				41	42				20	1	SPARE
TOTALS			0	0	C			0	C		0		
PHASE A:	0	VA											
PHASE B:	0	VA]							
PHASE C:	0	VA											
TOTAL CONNECTED VA	0	VA				1							
AMPS	0	Α	CONNECT	ED		1							
1.25X AMPS	0	Α]							
						_							

ANEL: LP-2 OLTAGE: 120/208V, 3P, 4W NCLOSURE: NEMA 3R									MAIN MOUNTING BUS	225A MC 250A WI		DUND BUS
	BREA			LOAD (VA)				LOAD (VA		BREAK		
CIRCUIT USE	TRIP	POLE	Α	В	С	CKT#	Α	В	С	TRIP	POLE	
PARE	20	1				1 2				20		SPARE
PARE	20	1				3 4				20		SPARE
PARE PARE	20	1				5 6 7 8				20	1	SPARE SPARE
SPARE SPARE	20	1				9 10				20 20	1	SPARE
SPARE	20	1				11 12				20	1	SPARE
SPARE	20	1				13 14				20	1	SPARE
SPARE	20	1				15 16				20	1	SPARE
SPARE	20	1				17 18		_		20	1	SPARE
SPARE	20	1				19 20			_	20		SPARE
SPARE	20	1				21 22				20		SPARE
SPARE	20	1				23 24				20		SPARE
SPARE	20	1				25 26				20	1	SPARE
SPARE	20	1				27 28				20	1	SPARE
SPARE	20	1				29 30				20	1	SPARE
SPARE	20	1				31 32				20	1	SPARE
SPARE	20	1				33 34				20	1	SPARE
SPARE	20	1				35 36				20	1	SPARE
SPARE	20	1				37 38				20	1	SPARE
SPARE	20	1				39 40				20	1	SPARE
SPARE	20	1				41 42				20	1	SPARE
TOTALS			0	0	C		(0	0			
PHASE A:		VA				4						
PHASE B:	0	VA				1						
PHASE C:	0	VA										
OTAL CONNECTED VA	0	VA										
MPS	0	Α	CONNECT	ED		1						
.25XAMPS		Α				1						

PANEL: PP-1 VOLTAGE: 480/277V, 3P, 4W ENCLOSURE: NEMA 1										MOUNTING	100A MC	_	DUND BUS
CIRCUIT USE	BREAF TRIP	POLE	A	LOAD (VA) C	Ck	(T#	Α	LOAD (V/	A)	BREAK TRIP	ERS POLE	CIRCUIT USE
SPARE	20	1		В	C	1		^	В	U	20		SPARE CIRCUIT USE
SPARE	20	1				3					20		SPARE
SPARE	20	1				5		1			20		SPARE
SPARE	20	1				7	8				20		SPARE
SPARE	20	1				9					20		SPARE
SPARE	20	1					12				20	1	SPARE
SPARE	20	1				13	14	1			20	1	SPARE
SPARE	20	1				15	16				20	1	SPARE
SPARE	20	1				17	18	1			20	1	SPARE
SPARE	20	1					20				20		SPARE
SPARE	20	1					22				20		SPARE
SPARE	20	1					24				20		SPARE
SPARE	20	1					26				20		SPARE
SPARE	20	1					28				20		SPARE
SPARE	20	1					30				20		SPARE
SPARE	20	1					32				20		SPARE
SPARE	20	1					34				20		SPARE
SPARE	20	1					36				20		SPARE
SPARE	20	1					38				20		SPARE
SPARE	20	1					40				20		SPARE
SPARE TOTALS	20	1	0	1 0			42	0		0	20	1	SPARE
PHASE A:	0	VA	U	1 0		1	Ь.	U		U			l
PHASE B:		VA				1							
PHASE C:	0	VA											
TOTAL CONNECTED VA	0	VA				1							
AMPS	0	Α	CONNECT	TED.		1							

NOTES:

SEE SHEETS E-0001 AND E-0002 FOR ELECTRICAL SYMBOL LIST, ABBREVIATIONS, AND GENERAL NOTES.

NOT FOR CONSTRUCTION E-4603

DESIGNED: A. FAREKAS C. MARTIN

M. BLUMENTHAL

07/21/17

DRAWN:


DATE:

PANELBOARD SCHEDULES

FILENAME SHT_WL_E_GATEWAYSTN_GN_03 SHEET 234 OF 361 SCALE NONE

AAA FNICINIFEDINIC			
AAA ENGINEERING			
AAA Engineering, Ltd.			
4323 W Irving Park Rd., Suite 200 Chicago, IL 60641			
P: 773-657-3300 F: 773-657-3330			
www.AAAEngineering.net	ISSUE	DATE	DESCRIPTION



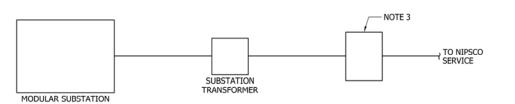

SUBSTATION SINGLE LINE DIAGRAM NOT TO SCALE E-4604/



PICTURE OF TYPICAL SWITCH E-4604 NOT TO SCALE

8550 W Bryn Mawr Ave., Suite 900 Chicago, IL 60631

AAA ENGINEERING AAA Engineering, Ltd. 4323 W Irving Park Rd., Suite 200 Chicago, IL 60641 P: 773-657-3300 F: 773-657-3330 www.AAAEngineering.net ISSUE DATE DESCRIPTION

NORTHERN INDIANA COMMUTER TRANSPORTATION DISTRICT 33 East Highway 12 Chesterton, Indiana 46304



		NOT F	FOR CONSTRUCTION E-4604
DESIGNED:	A. FAREKAS		NICTD - WEST LAKE CORRIDOR - MP WL 68.6
DRAWN:	C. MARTIN		HAMMOND GATEWAY SUBSTATION
CHECKED:	M. BLUMENTHAL		HAMMOND CATEMA
			HAMMOND GATEWA
DATE:	07/21/17		SUBSTATION SERVICE
			COBOTATION CENTRO
		FILENAME	SHT WL F GATEWAYSTN GN 04 SHEET

HAMMOND GATEWAY SUBSTATION SERVICE

361

FILENAME SHT_WL_E_GATEWAYSTN_GN_04 SHEET SCALE NONE

NOTES:

SEE SHEETS E-0001 AND E-0002 FOR ELECTRICAL SYMBOL LIST, ABBREVIATIONS, AND GENERAL NOTES.

3. 69KV GROUND OPERATED VERTICAL BREAKER SWITCH.

PROVIDE FENCING AROUND SWITCH AND TRANSFORMER AND NIPSCO SWITCH AREA AHEAD OF SWITCH, COORDINATE EXACT AREA REQUIREMENTS WITH NIPSCO.

8. ALL DESIGNS MUST BE CERTIFIED BY STRUCTURAL

PROVIDE LIGHTS ON STRUCTURE UP/DOWN AND AREA WITH WEATHERPROOF LED FLOODLIGHTS.

2. SEE SHEET E-4602 FOR CABLE AND CONDUIT SCHEDULE.

 USE ALUMINUM WIRING FOR CONNECTION. 5. PROVIDE CONCRETE FOUNDATION FOR SWITCH.

7. PROVIDE TUBULAR I-BEAM SUPPORT STAND.

 NIPSCO BUS SUPPORT SHALL HAVE LIGHTNING PROTECTION. 11. SWITCH SHALL HAVE HAND OPERATED MANUAL AUXILIARY INLINE SWITCH.

12. STRUCTURE SHALL BE PROPERLY GROUNDED PER NIPSCO SPECIFICATIONS.

13. PROVIDE WEATHERPROOF OUTDOOR GFI SERVICE RECEPTACLES ON EACH SUPPORT LEG OF SWITCH. SWITCH SHALL BE VERTICAL BREAK SWITCH VBI BY EM SPEC OR APPROVED EQUAL. CONTACT MARK SNYDER, 734-645-2886.


15. COORDINATE EXACT LOCATION WITH ARCHITECTURAL SITE PLAN DRAWING.

235 OF


M:5050 NICTD WEST LAKE PROJECT:04 - CADD FILES:04 - SHEET FILES:HAMMOND GATEWAY STATION:SHT_WL_E_GATEWAYSTN_GN_04.DWG



- 1. SEE SHEETS E-0001 AND E-0002 FOR ELECTRICAL SYMBOL LIST, ABBREVIATIONS, AND GENERAL NOTES.
- 2. SEE SHEET E-0601 FOR LIGHTING FIXTURE SCHEDULE.

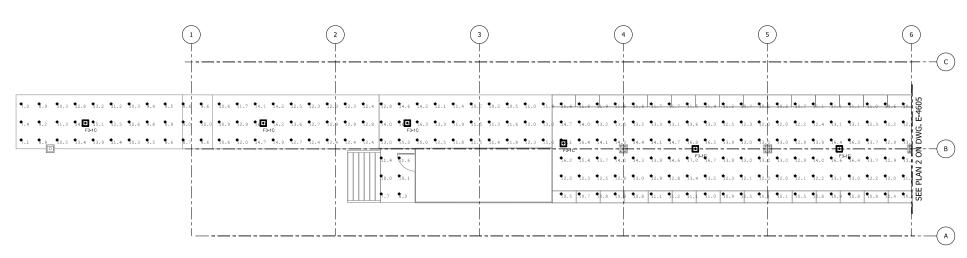


PARTIAL PLATFORM PHOTOMETRIC PLAN SCALE: 1/8" = 1'-0"

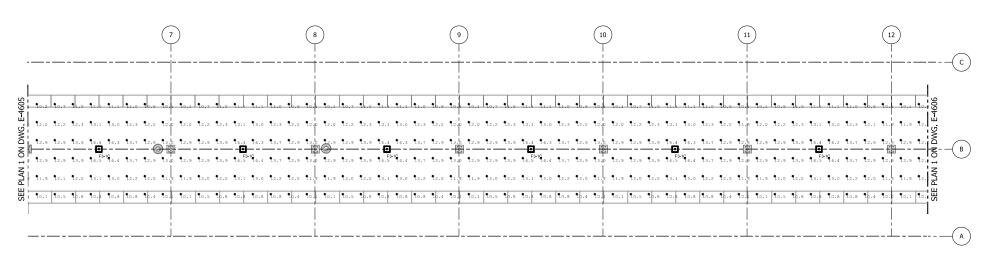

PARTIAL PLATFORM PHOTOMETRIC PLAN E-4605 SCALE: 1/8" = 1'-0"

Luminaire Sc	hedule							
Symbol	Qty	Tag	Label	Arrangement	Lum. Watts	Mounting Height (ft.)	LLF	Description
•	37	F3-1C	1970LED-10ARC45T5-MD	SINGLE	157.8	10	0.700	1970LED-10ARC45T5-MDL03-SV1

Calculation Summary							
Label	CalcType	Units	Avg	Max	Min	Avg/Min	Max/Min
Gateway Hammond SS Platform	Illuminance	Fc	12.31	17.1	6.6	1.87	2.59

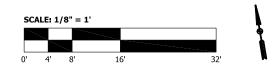

AAA Engineering, Ltd. 4323 W Irving Park Rd., Suite 200 Chicago, IL 60641 P: 773-657-3300 F: 773-657-3330 DATE DESCRIPTION

NORTHERN INDIANA COMMUTER TRANSPORTATION DISTRICT 33 East Highway 12 Chesterton, Indiana 46304



		NOT FOR CONSTRUCTION	SERIES E-4605
DESIGNED:	A. FAREKAS	NICTD - WEST LAKE CORF	
DRAWN:	C. MARTIN	HAMMOND GATEWA	STATION
CHECKED:	M. BLUMENTHAL		
		PARTIAL PLATFORM	IPHOIC
DATE:	07/21/17	PLANS - SOUTH SH	ORF PLA
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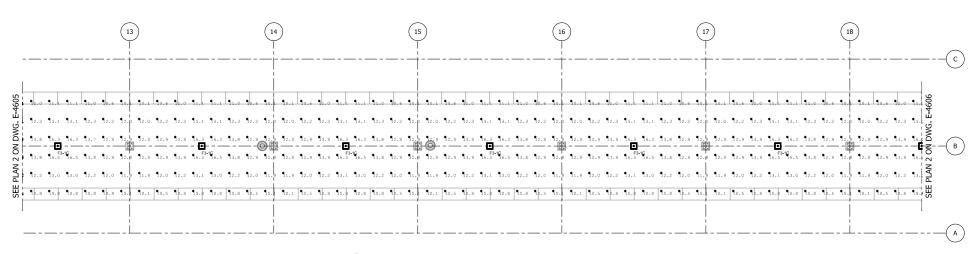
PARTIAL PLATFORM PHOTOMETRIC PLANS - SOUTH SHORE PLATFORM

FILENAME SHT_WL_E_GATEWAYSTN_DP_05 SHEET SCALE 1/8" = 1' - 0"


236 OF 361



- 1. SEE SHEETS E-0001 AND E-0002 FOR ELECTRICAL SYMBOL LIST, ABBREVIATIONS, AND GENERAL NOTES.
- 2. SEE SHEET E-0601 FOR LIGHTING FIXTURE SCHEDULE.



PARTIAL PLATFORM PHOTOMETRIC PLAN

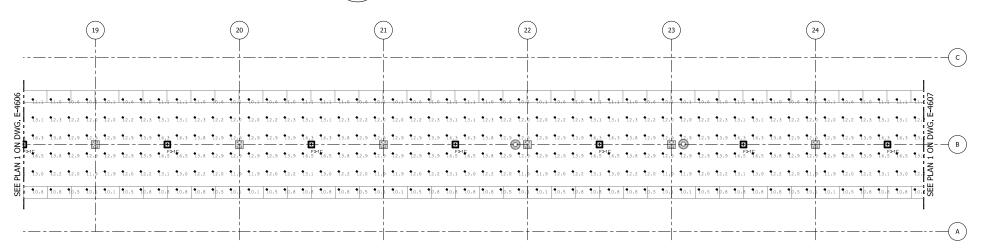

PARTIAL PLATFORM PHOTOMETRIC PLAN SCALE: 1/8" = 1'-0"

Luminaire Sc	hedule							
Symbol	Qty	Tag	Label	Arrangement	Lum. Watts	Mounting Height (ft.)	LLF	Description
•	37	F3-1C	1970LED-10ARC45T5-MD	SINGLE	157.8	10	0.700	1970LED-10ARC45T5-MDL03-SV1

Calculation Summary							
Label	CalcType	Units	Avg	Max	Min	Avg/Min	Max/Min
Gateway Hammond SS Platform	Illuminance	Fc	12.31	17.1	6.6	1.87	2.59



AAA Engineering, Ltd. 4323 Wirving Park Rd., Suite 200 Chicago, IL 60641 P: 773-657-3300 F: 773-657-3330 DATE DESCRIPTION NORTHERN INDIANA COMMUTER TRANSPORTATION DISTRICT 33 East Highway 12 Chesterton, Indiana 46304



		NOT FOR CONSTRUCTION 5
DESIGNED: DRAWN:	A. FAREKAS C. MARTIN	NICTD - WEST LAKE CORRIDOR HAMMOND GATEWAY STA
CHECKED:	M. BLUMENTHAL	PARTIAL PLATFORM F
DATE:	07/21/17	PLANS - SOUTH SHO
		<u> </u>


PARTIAL PLATFORM PHOTOMETRIC PLANS - SOUTH SHORE PLATFORM

FILENAME SHT_WL_E_GATEWAYSTN_DP_06 SHEET SCALE 1/8" = 1' - 0"


237 OF 361



- 1. SEE SHEETS E-0001 AND E-0002 FOR ELECTRICAL SYMBOL LIST, ABBREVIATIONS, AND GENERAL NOTES.
- 2. SEE SHEET E-0601 FOR LIGHTING FIXTURE SCHEDULE.

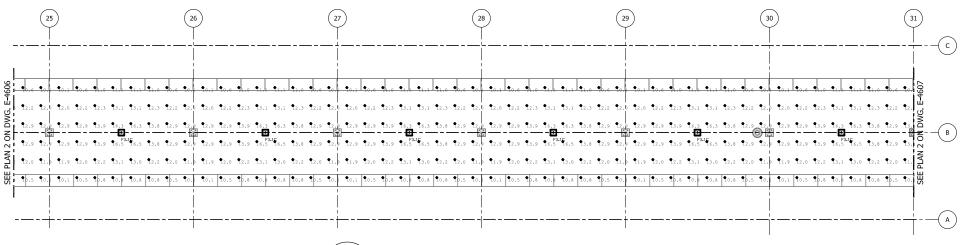

PARTIAL PLATFORM PHOTOMETRIC PLAN SCALE: 1/8" = 1'-0"

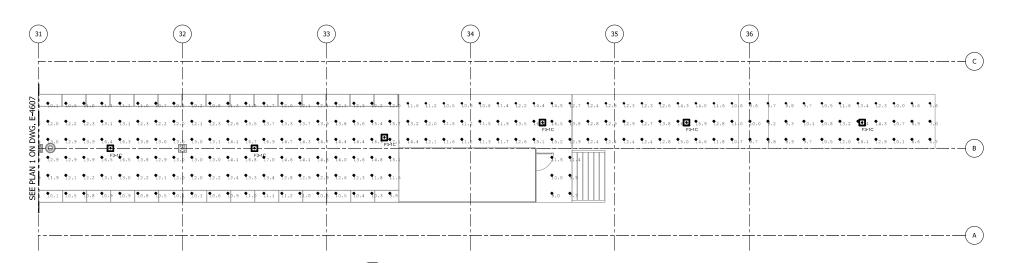


PARTIAL PLATFORM PHOTOMETRIC PLAN

Luminaire So	Luminaire Schedule									
Symbol	Qty	Tag	Label	Arrangement	Lum. Watts	Mounting Height (ft.)	LLF	Description		
П	37	F3-1C	1970LED-10ARC45T5-MD	SINGLE	157.8	10	0.700	1970LED-10ARC45T5-MDL03-SV1		

Calculation Summary							
Label	CalcType	Units	Avg	Max	Min	Avg/Min	Max/Min
Gateway Hammond SS Platform	Illuminance	Fc	12.31	17.1	6.6	1.87	2.59

SCALE: 1/8" = 1'-0"

E-4607

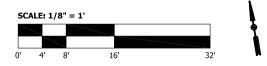

AAA Engineering, Ltd. 4323 W Irving Park Rd., Suite 200 Chicago, IL 60641 P: 773-657-3300 F: 773-657-3330 DATE DESCRIPTION NORTHERN INDIANA COMMUTER TRANSPORTATION DISTRICT 33 East Highway 12 Chesterton, Indiana 46304



		NOT F	OR CONSTRU	JCTION	SERIES E-4607
DESIGNED:	A. FAREKAS			- WEST LAKE CORRID	
DRAWN:	C. MARTIN		H	AMMOND GATEWAY S	STATION
CHECKED:	M. BLUMENTHAL		DTIAL DLA		DUOT
		12	RTIAL PLA	IFURIVI	PHOTO
DATE:	07/21/17	PL	ANS - SOU	TH SHO	RE PL


PARTIAL PLATFORM PHOTOMETRIC PLANS - SOUTH SHORE PLATFORM

FILENAME SHT_WL_E_GATEWAYSTN_DP_07 SHEET


238 OF 361 SCALE 1/8" = 1' - 0"



- SEE SHEETS E-0001 AND E-0002 FOR ELECTRICAL SYMBOL LIST, ABBREVIATIONS, AND GENERAL NOTES.
- 2. SEE SHEET E-0601 FOR LIGHTING FIXTURE SCHEDULE.

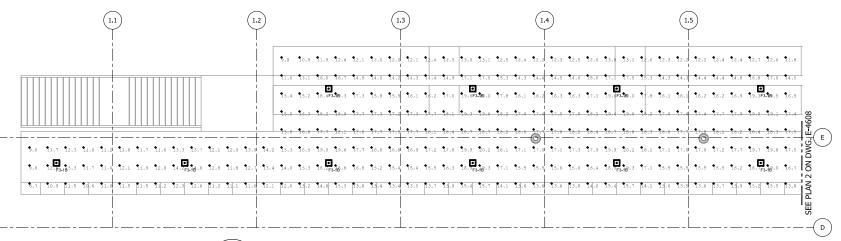


PARTIAL PLATFORM PHOTOMETRIC PLAN SCALE: 1/8" = 1'-0" E-4608/

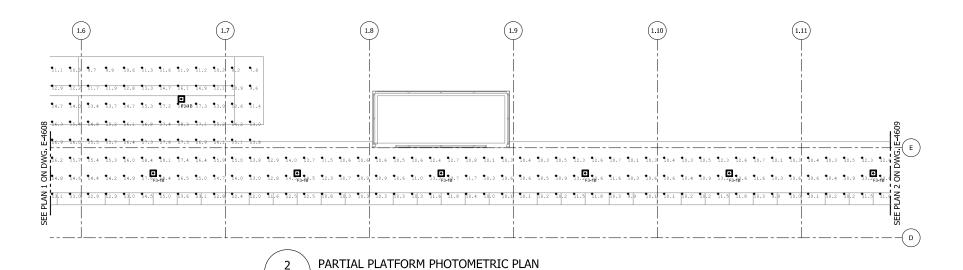

Luminaire Sch	edule							
Symbol	Qty	Tag	Label	Arrangement	Lum. Watts	Mounting Height (ft.)	LLF	Description
•	31	F3-1B	1970LED-8ARC45T5-MDL	SINGLE	122.7	10	0.700	1970LED-8ARC45T5-MDL03-SV1

Calculation Summary									
Label	CalcType	Units	Avg	Max	Min	Avg/Min	Max/Min		
Gateway Hammond Westlake Platform	Illuminance	Fc	13.85	21.8	7.0	1.98	3.11		

SCALE: 1/8" = 1'-0"

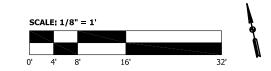

AAA Engineering, Ltd. 4323 W Irving Park Rd., Suite 200 Chicago, IL 60641 P: 773-657-3300 F: 773-657-3330 DATE DESCRIPTION

NORTHERN INDIANA COMMUTER TRANSPORTATION DISTRICT 33 East Highway 12 Chesterton, Indiana 46304




		NOT F	OR CONSTRUCTION	1	SERIES E-4608
DESIGNED:	A. FAREKAS		NICTD - WEST LAKE COR		
DRAWN:	C. MARTIN		HAMMOND GATE	VAY :	STATION
CHECKED:	M. BLUMENTHAL	D ^	RTIAL PLATFOR	N /I	DUOTO
] PP	KHAL PLATFOR	IVI	PHOTO
DATE:	07/21/17		PLANS - WEST LA	٩k	KE PLAT
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PARTIAL PLATFORM PHOTOMETRIC PLANS - WEST LAKE PLATFORM


FILENAME SHT_WL_E_GATEWAYSTN_DP_08 SHEET 239 OF 361 SCALE 1/8" = 1' - 0"



- SEE SHEETS E-0001 AND E-0002 FOR ELECTRICAL SYMBOL LIST, ABBREVIATIONS, AND GENERAL NOTES.
- 2. SEE SHEET E-0601 FOR LIGHTING FIXTURE SCHEDULE.

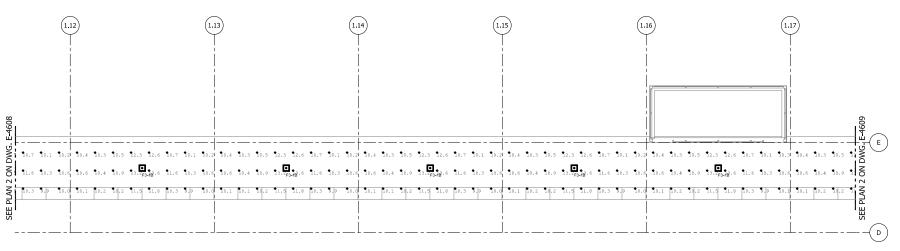

PARTIAL PLATFORM PHOTOMETRIC PLAN E-4609 SCALE: 1/8" = 1'-0"

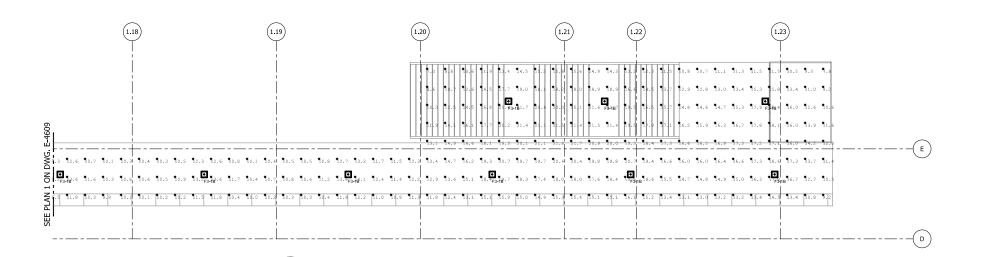


Luminaire Sch	edule							
Symbol	Qty	Tag	Label	Arrangement	Lum. Watts	Mounting Height (ft.)	LLF	Description
•	31	F3-1B	1970LED-8ARC45T5-MDL	SINGLE	122.7	10	0.700	1970LED-8ARC45T5-MDL03-SV1

PARTIAL PLATFORM PHOTOMETRIC PLAN

Calculation Summary							
Label	CalcType	Units	Avg	Max	Min	Avg/Min	Max/Min
Gateway Hammond Westlake Platform	Illuminance	Fc	13.85	21.8	7.0	1.98	3.11

E-4609 SCALE: 1/8" = 1'-0"

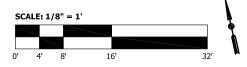

AAA Engineering, Ltd. 4323 Wirving Park Rd., Suite 200 Chicago, IL 60641 P: 773-657-3300 F: 773-657-3330 DATE DESCRIPTION

NORTHERN INDIANA COMMUTER TRANSPORTATION DISTRICT 33 East Highway 12 Chesterton, Indiana 46304




		NOT F	OR CONS	FRUCTION	SERIES E-4609
DESIGNED:	A. FAREKAS		N	IICTD - WEST LAKE CORRIDO	
DRAWN:	C. MARTIN			HAMMOND GATEWAY	STATION
CHECKED:	M. BLUMENTHAL	D ^	DTIAL DI	ATFORM	DUOTO
		17	KHALPL	AIFURIVI	PHOTO
DATE:	07/21/17]	PLANS - \	NEST LAK	(E PLAT
		<u>'</u>	_,		,
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PARTIAL PLATFORM PHOTOMETRIC PLANS - WEST LAKE PLATFORM

FILENAME SHT_WL_E_GATEWAYSTN_DP_09 SHEET SCALE 1/8" = 1' - 0"

240 OF 361

- SEE SHEETS E-0001 AND E-0002 FOR ELECTRICAL SYMBOL LIST, ABBREVIATIONS, AND GENERAL NOTES.
- 2. SEE SHEET E-0601 FOR LIGHTING FIXTURE SCHEDULE.



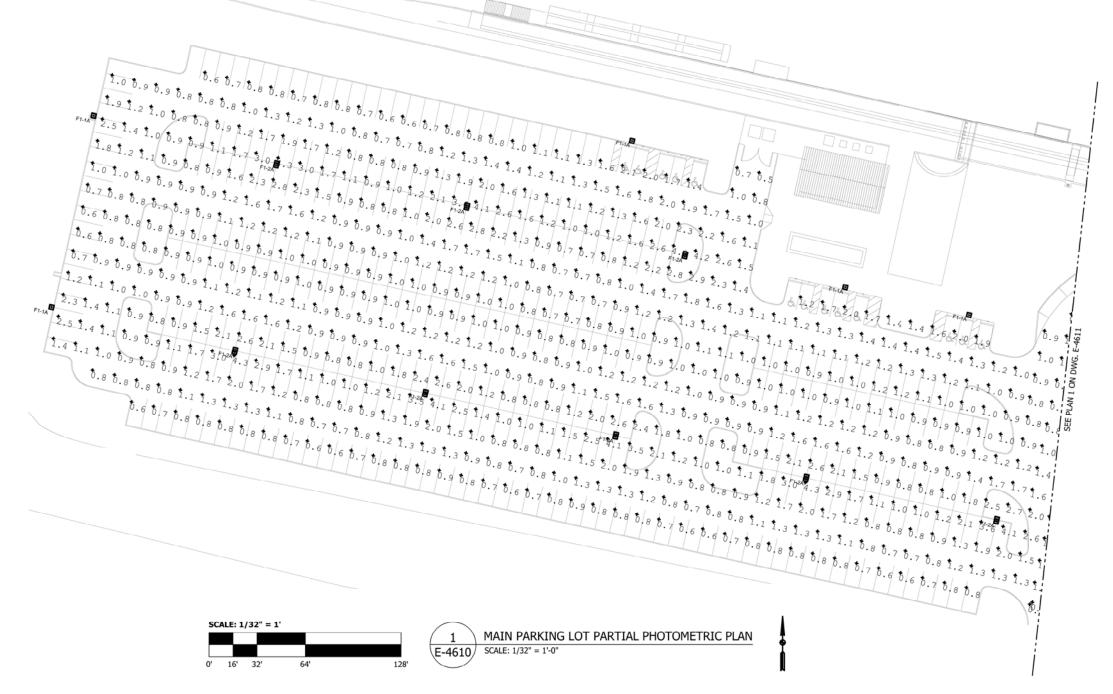

KEY PLAN

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HDR Engineering, Inc.	4
8550 W Bryn Mawr Ave., Suite 900	1.5
Chicago, IL 60631	14
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www.hdrinc.com	I P

AAA ENGINEERING

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AAA Engineering, Ltd.
4323 W Irving Park Rd., Suite 200
Chicago, IL 60641
P: 773-657-3300 F: 773-657-3330
www.AAAEngineering.net


ISSUE DATE DESCRIPTION





		14011	OK CONSTRUCTION	E-4610		
DESIGNED:	A. FAREKAS		NICTD - WEST LAKE CORRIDO			
DRAWN:	C. MARTIN		HAMMOND GATEWAY S	STATION		
CHECKED:	M. BLUMENTHAL		MAIN PARKING L	OT PAI	RTIAL	
DATE:	07/21/17		PHOTOMETR			
		FILENAME	SHT WL E GATEWAYSTN DP 10	SHEET		
				241	OF	36′
		SCALE	1/32" = 1' - 0"	24 1	OF.	30

NOT FOR CONSTRUCTION SERIES

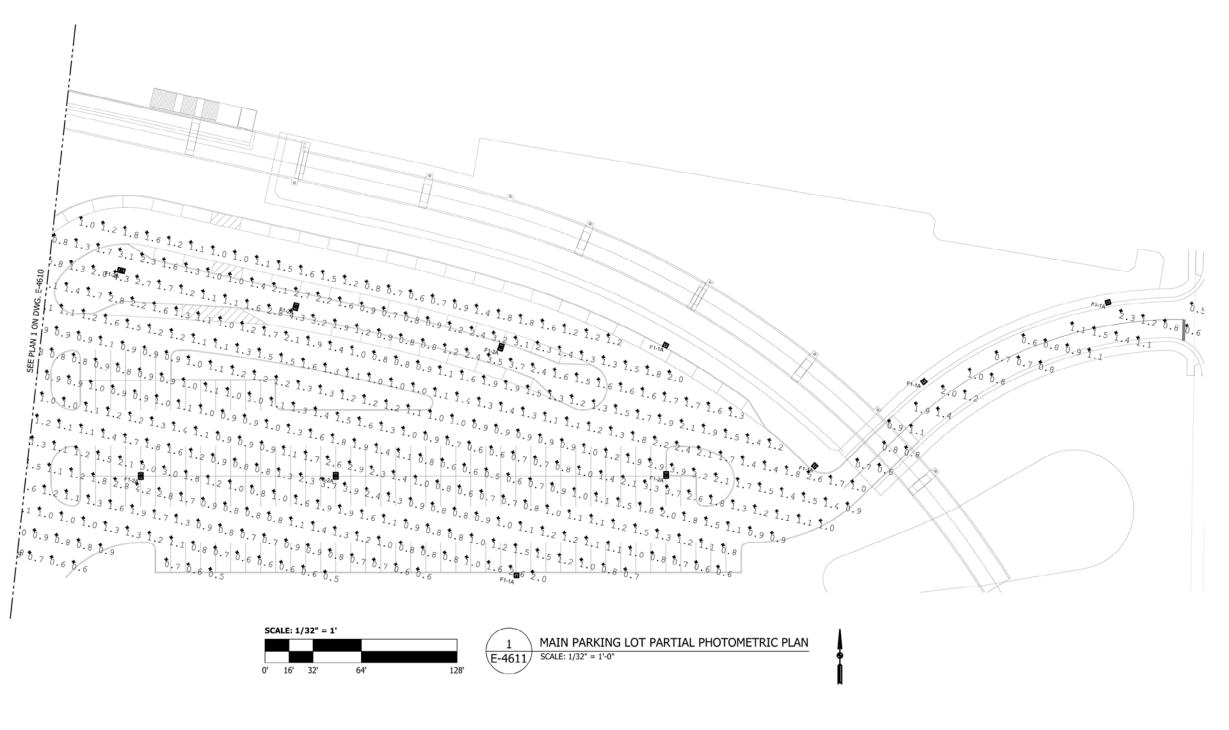

KEY PLAN

HDR Engineering, Inc. 8550 W Bryn Mawr Ave., Suite 900	AAA 4323
Chicago, IL 60631	Chica P: 77
www.numic.com	340404

AAA ENGINEERING ago, IL 60641 3-657-3300 F: 773-657-3330 DATE DESCRIPTION





		NOT F	OR CONSTRUCTION	SERIES E-4611		
DESIGNED:	A. FAREKAS		NICTD - WEST LAKE CORRIDO			
DRAWN:	C. MARTIN		HAMMOND GATEWAY S	STATION		
CHECKED:	M. BLUMENTHAL		MAIN PARKING LO			
			NG LUI			
DATE:	07/21/17		PARTIAL PHOTOM	IFTRIC.		
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SCALE 1/32" = 1' - 0"


EST LAKE CORRIDOR - MP WL 69.0 MMOND GATEWAY STATION PARKING LOT HOTOMETRIC PLAN YSTN_DP_11 242 OF 361

NOTES:

1. SEE SHEETS E-0001 AND E-0002 FOR ELECTRICAL SYMBOL LIST, ABBREVIATIONS, AND GENERAL NOTES. 2. SEE SHEET E-0601 FOR LIGHTING FIXTURE SCHEDULE.

M:5050 NICTD WEST LAKE PROJECT/04 - CADD FILES/04 - SHEET FILES/HAMMOND GATEWAY STATION/SHT_WL_E_GATEWAYSTN_DP_11.DWG


- SEE SHEETS E-0001 AND E-0002 FOR ELECTRICAL SYMBOL LIST, ABBREVIATIONS, AND GENERAL NOTES.
- 2. SEE SHEET E-0601 FOR LIGHTING FIXTURE SCHEDULE.

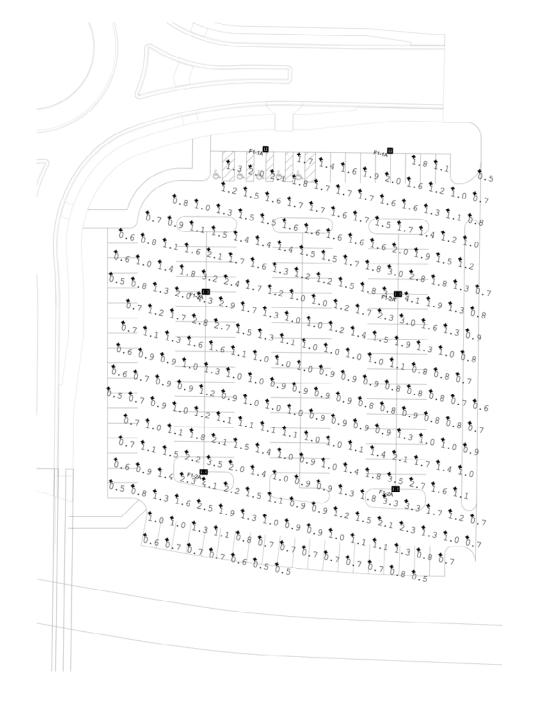







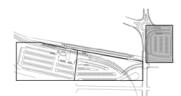

KEY PLAN

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HDR Engineering, Inc.	Mawr Ave., Suite 900 0631
Chicago, IL 60631	

AAA ENGINEERING
DECERTRIED

JAA Engineering, Ltd.
1323 W Irving Park Rd., Suite 200
Thicago, IL 60641
T:73-657-3300
T:73-657-3330
Tivew AAAEngineering net

ISSUE

DATE

DESCRIPTION

NORTHERN INDIANA COMMUTER TRANSPORTATION DISTRICT 33 East Highway 12 Chesterton, Indiana 46304



KET PL	<u>_AIN</u>					
		NOT F	OR CONSTRUCTION	SERIES E-4612		
DESIGNED:	A. FAREKAS		NICTD - WEST LAKE CORRIDO			
DRAWN:	C. MARTIN		HAMMOND GATEWAY S	HAHON		
CHECKED:	M. BLUMENTHAL					
	70-1 C-100000	P/	ARKING LOT PHOT	OMETE	RIC PL	AN
DATE:	07/21/17					
		FILENAME	SHT_WL_E_GATEWAYSTN_DP_12	SHEET		
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SCALE 1/32" = 1' - 0"

243 OF 361

- SEE SHEETS E-0001 AND E-0002 FOR ELECTRICAL SYMBOL LIST, ABBREVIATIONS, AND GENERAL NOTES.
- 2. SEE SHEET E-0601 FOR LIGHTING FIXTURE SCHEDULE.
- THIS TABLE SHOWS FIXTURES IN TOTAL PARKING LOT AND KISS AND RIDE AREAS.

Luminaire Schedule									
Symbol		Qty	Tag	Label	Arrangement	Lum. Watts	Mounting Height (ft.)	LLF	Description
	•	12	F1-1A	DSX1_LED_40C_1000_40K_T4M_MVO	SINGLE	138	25	0.700	DSX1 LED 40C 1000 40K T4M MVOLT
Œ	1	18	F1-2A	DSX1 LED 40C 1000 40K T4M MVO 1	BACK-BACK	138	25	0.700	DSX1 LED 40C 1000 40K T4M MVOLT

Calculation Summary							
Label	CalcType	Units	Avg	Max	Min	Avg/Min	Max/Min
East-Parking Lot	Illuminance	Fc	1.32	4.3	0.5	2.64	8.60
North Parking Lot	Illuminance	Fc	1.32	4.3	0.5	2.64	8.60
West-Parking Lot 1	Illuminance	Fc	1.25	4.3	0.5	2.50	8.60
North Parking Lot Handicap	Illuminance	Fc	1.78	2.1	1.3	1.37	1.62
West-Sec-A-Handicap	Illuminance	Fc	1.80	2.1	1.4	1.29	1.50
West-Sec-B-Handicap_2	Illuminance	Fc	1.66	2.0	1.2	1.38	1.67

HDR Engineering, Inc. 8550 W Bryn Mawr Ave., Suite 900 Chicago, IL 60631

AAA ENGINEERING AAA Engineering, Ltd. 4323 W Irving Park Rd., Suite 200 Chicago, IL 60641 P: 773-657-3300 F: 773-657-3330 www.AAAEngineering.net ISSUE DATE DESCRIPTION

NORTHERN INDIANA COMMUTER TRANSPORTATION DISTRICT 33 East Highway 12 Chesterton, Indiana 46304



		NOT F	OR CONSTRUCTION	SERIES E-4613	
DESIGNED:	A. FAREKAS		NICTD - WEST LAKE CORRIDOR		
DRAWN:	C. MARTIN		HAMMOND GATEWAY S	TATION	
CHECKED:	M. BLUMENTHAL				
		PΔ	METRI		
DATE:	07/21/17	' /	RKING LOT PHOTO		
		FILENAME	SHT WILE GATEWAYSTN DD 13	SHEET	

PARKING LOT PHOTOMETRIC TABLES

SCALE 1/32" = 1' - 0"